AIRPORT CAMPUS

TAX MAP SECTION 118.02 | BLOCK 1 | LOT 1 WESTCHESTER COUNTY 113 KING STREET (NY RT 120) TOWN OF NORTH CASTLE, NEW YORK

Applicant:

AIRPORT CAMPUS I-V LLC **46 WESTCHESTER AVENUE POUND RIDGE, NY 10576** (914) 764-1000



Veneziano & Associates 84 BUSINESS PARK DRIVE, SUITE 200 **ARMONK, NY 10504** (914) 273-1300

Environmental, Planning, and **Engineering Consultants:** AKRF, INC. 34 SOUTH BROADWAY, SUITE 401 WHITE PLAINS, NY 10601 (914) 922-2370

Wetland Consultant: Ecological Solutions 1248 SOUTHFORD ROAD SOUTHBURY, CT 06488


Architect:

(203) 910-4716


Perkins Eastman 677 WASHINGTON BOULEVARD, SUITE 101 STAMFORD, CT 06901 (203) 251-7400

Traffic Engineers:

John Collins Engineers 11 BRADHURST AVENUE **HAWTHORNE, NY 10532** (914) 347-7500

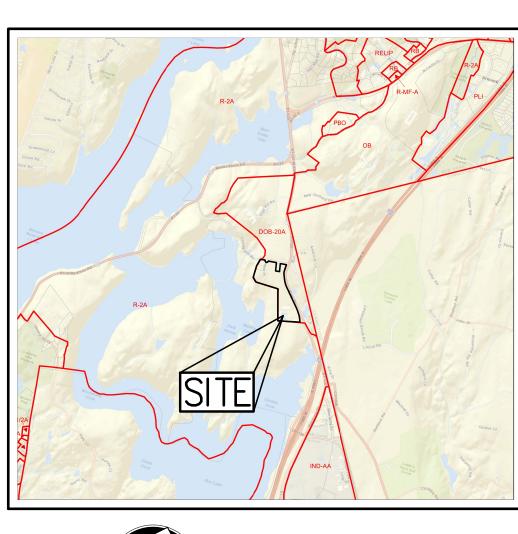



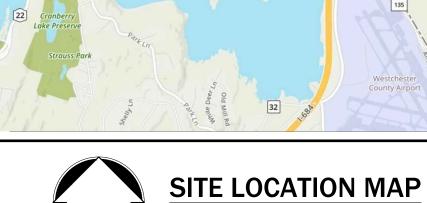

GENERAL CONSTRUCTION NOTES APPLY TO ALL WORK HEREIN:

1. PRIOR TO CONSTRUCTION, THE CONTRACTOR SHALL CALL 811 "DIG SAFELY" (1-800-962-7962) TO HAVE UNDERGROUND UTILITIES LOCATED INCLUDING ARRANGING FOR A PRIVATE MARKOUT ON-SITE WHERE APPLICABLE. EXPLORATORY EXCAVATIONS SHALL COMPLY WITH CODE 753 REQUIREMENTS. NO WORK SHALL COMMENCE UNTIL ALL THE OPERATORS HAVE NOTIFIED THE CONTRACTOR THAT THEIR UTILITIES HAVE BEEN LOCATED. THE CONTRACTOR SHALL BE RESPONSIBLE FOR THE PRESERVATION OF ALL PUBLIC AND PRIVATE UNDERGROUND AND SURFACE UTILITIES AND STRUCTURES AT OR ADJACENT TO THE SITE OF CONSTRUCTION, INSOFAR AS THEY MAY BE ENDANGERED BY THE CONTRACTOR'S OPERATIONS. THIS SHALL HOLD TRUE WHETHER OR NOT THEY ARE SHOWN ON THE CONTRACT DRAWINGS. IF THEY ARE SHOWN ON THE DRAWINGS, THEIR LOCATIONS ARE NOT GUARANTEED EVEN THOUGH THE INFORMATION WAS OBTAINED FROM THE BEST AVAILABLE SOURCES, AND IN ANY EVENT, OTHER UTILITIES ON THESE PLANS MAY BE ENCOUNTERED IN THE FIELD. THE CONTRACTOR SHALL, AT HIS OWN EXPENSE, IMMEDIATELY REPAIR OR REPLACE ANY STRUCTURES OR UTILITIES THAT HE DAMAGES, AND SHALL CONSTANTLY PROCEED WITH CAUTION TO PREVENT UNDUE INTERRUPTION OF UTILITY SERVICE.

2. CONTRACTOR SHALL HAND DIG TEST PITS TO VERIFY THE LOCATION OF ALL EXISTING UNDERGROUND UTILITIES PRIOR TO THE START OF CONSTRUCTION. CONTRACTOR SHALL VERIFY EXISTING UTILITIES DEPTHS AND ADVISE OF ANY CONFLICTS WITH PROPOSED UTILITIES. IF CONFLICTS ARE PRESENT. THE OWNER'S FIELD REPRESENTATIVE, JMC, PLLC AND THE APPLICABLE MUNICIPALITY OR AGENCY SHALL BE NOTIFIED IN WRITING. THE EXISTING/PROPOSED UTILITIES RELOCATION SHALL BE DESIGNED BY JMC, PLLC.

3. CONTRACTOR IS RESPONSIBLE FOR OBTAINING ANY AND ALL LOCAL PERMITS REQUIRED.

4. ALL WORK SHALL BE DONE IN STRICT COMPLIANCE WITH ALL APPLICABLE NATIONAL, STATE, AND LOCAL CODES, STANDARDS, ORDINANCES, RULES, AND REGULATIONS. ALL CONSTRUCTION WORK SHALL BE PERFORMED IN ACCORDANCE WITH ALL SAFETY CODES. APPLICABLE SAFETY CODES MEAN THE LATEST EDITION INCLUDING ANY AND ALL AMENDMENTS, REVISIONS, AND ADDITIONS THERETO, TO THE FEDERAL DEPARTMENT OF LABOR, OCCUPATIONAL SAFETY AND HEALTH ADMINISTRATION'S OCCUPATIONAL SAFETY AND HEALTH STANDARDS (OSHA); AND APPLICABLE SAFETY, HEALTH REGULATIONS AND BUILDING CODES FOR CONSTRUCTION IN THE STATE OF NEW YORK. THE CONTRACTOR SHALL BE RESPONSIBLE FOR GUARDING AND PROTECTING ALL OPEN EXCAVATIONS IN ACCORDANCE WITH THE PROVISION OF SECTION 107-05 (SAFETY AND HEALTH REQUIREMENTS) OF THE NYSDOT STANDARD SPECIFICATIONS. IF THE CONTRACTOR PERFORMS ANY HAZARDOUS CONSTRUCTION PRACTICES, ALL OPERATIONS IN THE AFFECTED ARÉA SHALL BE DISCONTINUED AND IMMEDIATE ACTION SHALL BE TAKEN TO CORRECT THE SITUATION TO THE SATISFACTION OF THE APPROVAL AUTHORITY HAVING JURISDICTION.

5. CONTRACTOR SHALL MAINTAIN ACCESS TO ALL PROPERTIES AFFECTED BY THE SCOPE OF WORK SHOWN HEREON AT ALL TIMES TO THE SATISFACTION OF THE OWNERS REPRESENTATIVE. RAMPING CONSTRUCTION TO PROVIDE ACCESS MAY BE CONSTRUCTED WITH SUBBASE MATERIAL EXCEPT THAT TEMPORARY ASPHALT CONCRETE SHALL BE PLACED AS DIRECTED BY THE ENGINEER. THE CONTRACTOR SHALL BE RESPONSIBLE FOR PROVIDING SAFE PEDESTRIAN ACCESS AT ALL TIMES.





JMC Drawing List:

C-000	COVER SHEET
C-010	EXISTING CONDITIONS PLAN
C-100	OVERALL PREFERRED DEVELOPMENT PLAN
C-101	PREFERRED DEVELOPMENT PLAN
C-102	PREFERRED DEVELOPMENT PLAN
C-151	TREE PROTECTION PLAN
C-152	TREE PROTECTION PLAN
C-153	TREE PROTECTION TABLE (PART A)
C-154	TREE PROTECTION TABLE (PART B)
C-201	PRELIMINARY GRADING PLAN
C-202	PRELIMINARY GRADING PLAN
C-301	PRELIMINARY UTILITIES PLAN
C-302	PRELIMINARY UTILITIES PLAN
C-401	PRELIMINARY EROSION & SEDIMENT CONTROL PLAN
C-402	PRELIMINARY EROSION & SEDIMENT CONTROL PLAN
L-101	PRELIMINARY LANDSCAPE PLAN
L-102	PRELIMINARY LANDSCAPE PLAN

TABLE OF LAND USE							
PROPOSED USE: AIRPORT CAMPUS DEVELOPMENT CONCEPT PLAN ZONING DISTRICT: DOB-20A (DESIGNED OFFICE BUSINESS DISTRICT)							
	EXISTING DOB-20A	EXISTING CONDITION	PROPOSED DOB-20A	PROVIDED			
AREA							
MINIMUM LOT AREA	20 ACRES	37.8 ACRES	NO CHANGE	NO CHANGE			
MINIMUM FRONTAGE	500 FT	2,215 FT	NO CHANGE	NO CHANGE			
MINIMUM DEPTH	500	857 FT (AVG)	NO CHANGE	NO CHANGE			
MINIMUM FRONT YARD SETBACKS							
CURRENTLY PERMITTED USES (355-23)	150 FT	61 FT ⁽⁷⁾	NO CHANGE	NO CHANGE			
MULTIFAMILY RESIDENTIAL BUILDINGS	N/A	N/A	65 FT ⁽¹⁾	65 FT			
RESIDENTIAL TOWNHOMES	N/A	N/A	200 FT ⁽¹⁾	244 FT			
MINIMUM REAR YARD SETBACKS							
CURRENTLY PERMITTED USES (355–23)	300 FT / 10 FT ⁽²⁾	14 FT	NO CHANGE	NO CHANGE			
MULTIFAMILY RESIDENTIAL BUILDINGS	N/A	N/A	50 FT	61 FT			
MINIMUM SIDE YARD SETBACKS			22 == (1)	A. F-			
RESIDENTIAL TOWNHOMES	N/A	N/A	60 FT ⁽¹⁾	64 FT			
MAXIMUM BUILDING COVERAGE							
CURRENTLY PERMITTED USES (355-23)	10 PERCENT	6.86 PERCENT	15 PERCENT (1)	3.69 PERCENT			
MULTIFAMILY RESIDENTIAL BUILDINGS	N/A	N/A	15 PERCENT (1)	4.08 PERCENT			
RESIDENTIAL TOWNHOMES	N/A	N/A	15 PERCENT (1)	2.19 PERCENT			
MAXIMUM BUILDING HEIGHT		<u> </u>					
CURRENTLY PERMITTED USES (355–23)	AS IN 355-30J(3)(C)	≤45 FT	AS IN 355-30J(3)(C)	NO CHANGE			
MULTIFAMILY RESIDENTIAL BUILDINGS	N/A	N/A	85 FEET ⁽¹⁾	≤85 FEET			
RESIDENTIAL TOWNHOMES	N/A	N/A	35 FEET ⁽¹⁾	≤35 FEET			
FLOOR AREA RATIO			Γ				
CURRENTLY PERMITTED USES (355-23)	0.15	0.16 (4)	NO CHANGE	0.06			
MULTIFAMILY RESIDENTIAL BUILDINGS	0.15 N/A	N/A	N/A ⁽³⁾	0.06 N/A			
RESIDENTIAL TOWNHOMES	N/A N/A	N/A	N/A (5)	N/A			
	,		,	•			
PARKING	10 11		No 600000	0111000			
CURRENTLY PERMITTED USES (355-23)	AS IN 355-30	473	NO CHANGE	SHARED WITH HOTEL			
MULTIFAMILY RESIDENTIAL BUILDINGS	N/A	N/A	AS DETERMINED BY PLANNING BOARD (5)	347			
RESIDENTIAL TOWNHOMES	N/A	N/A	AS DETERMINED BY PLANNING BOARD (5)	4 PER UNIT (6)			
HOTEL	N/A	N/A	AS DETERMINED BY PLANNING BOARD (5)	SHARED WITH OFFICE			

TABLE OF LAND USE NOTES

(1) SUBJECT TO SPECIAL PERMIT APPROVAL BY THE TOWN BOARD.


(2) 10 FEET FOR BUILDING ADJACENT TO NYCDEP WATERSHED LANDS BY SPECIAL PERMIT.

(3) SUBJECT TO OTHER DENSITY LIMITATIONS

(4) INCREASED FLOOR AREA RATIO PERMITTED DUE TO PREVIOUS TRANSFER OF DEVELOPMENT RIGHTS (5) PARKING REQUIREMENTS FOR MULTIFAMILY AND TOWNHOUSE USES SHALL BE DETERMINED BY THE PLANNING BOARD IN CONNECTION WITH SITE PLAN APPROVAL.


(6) PARKING FOR EACH RESIDENTIAL TOWNHOME UNIT INCLUDES 2 DRIVEWAY AND 2 GARAGE SPACES (4 SPACES TOTAL).

(7) PREVIOUSLY APPROVED BY SPECIAL PERMIT OF TOWN BOARD.

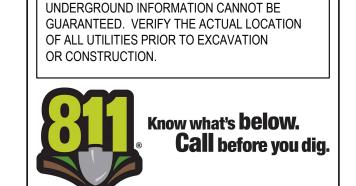

SUBSURFACE UTILITY LOCATIONS ARE BASED ON A COMPILATION OF FIELD EVIDENCE, AVAILABLE RECORD PLANS AND/OR UTILITY MARK-OUTS.


THE LOCATION OR COMPLETENESS OF

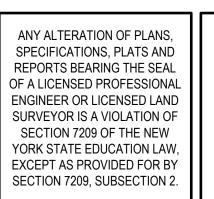



Revision	Date	Ву	
POND TO TOWN COMMENTS	09/16/2020	JJ	


Previous Editions Obsolete



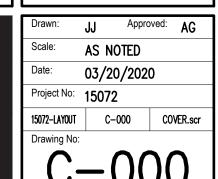

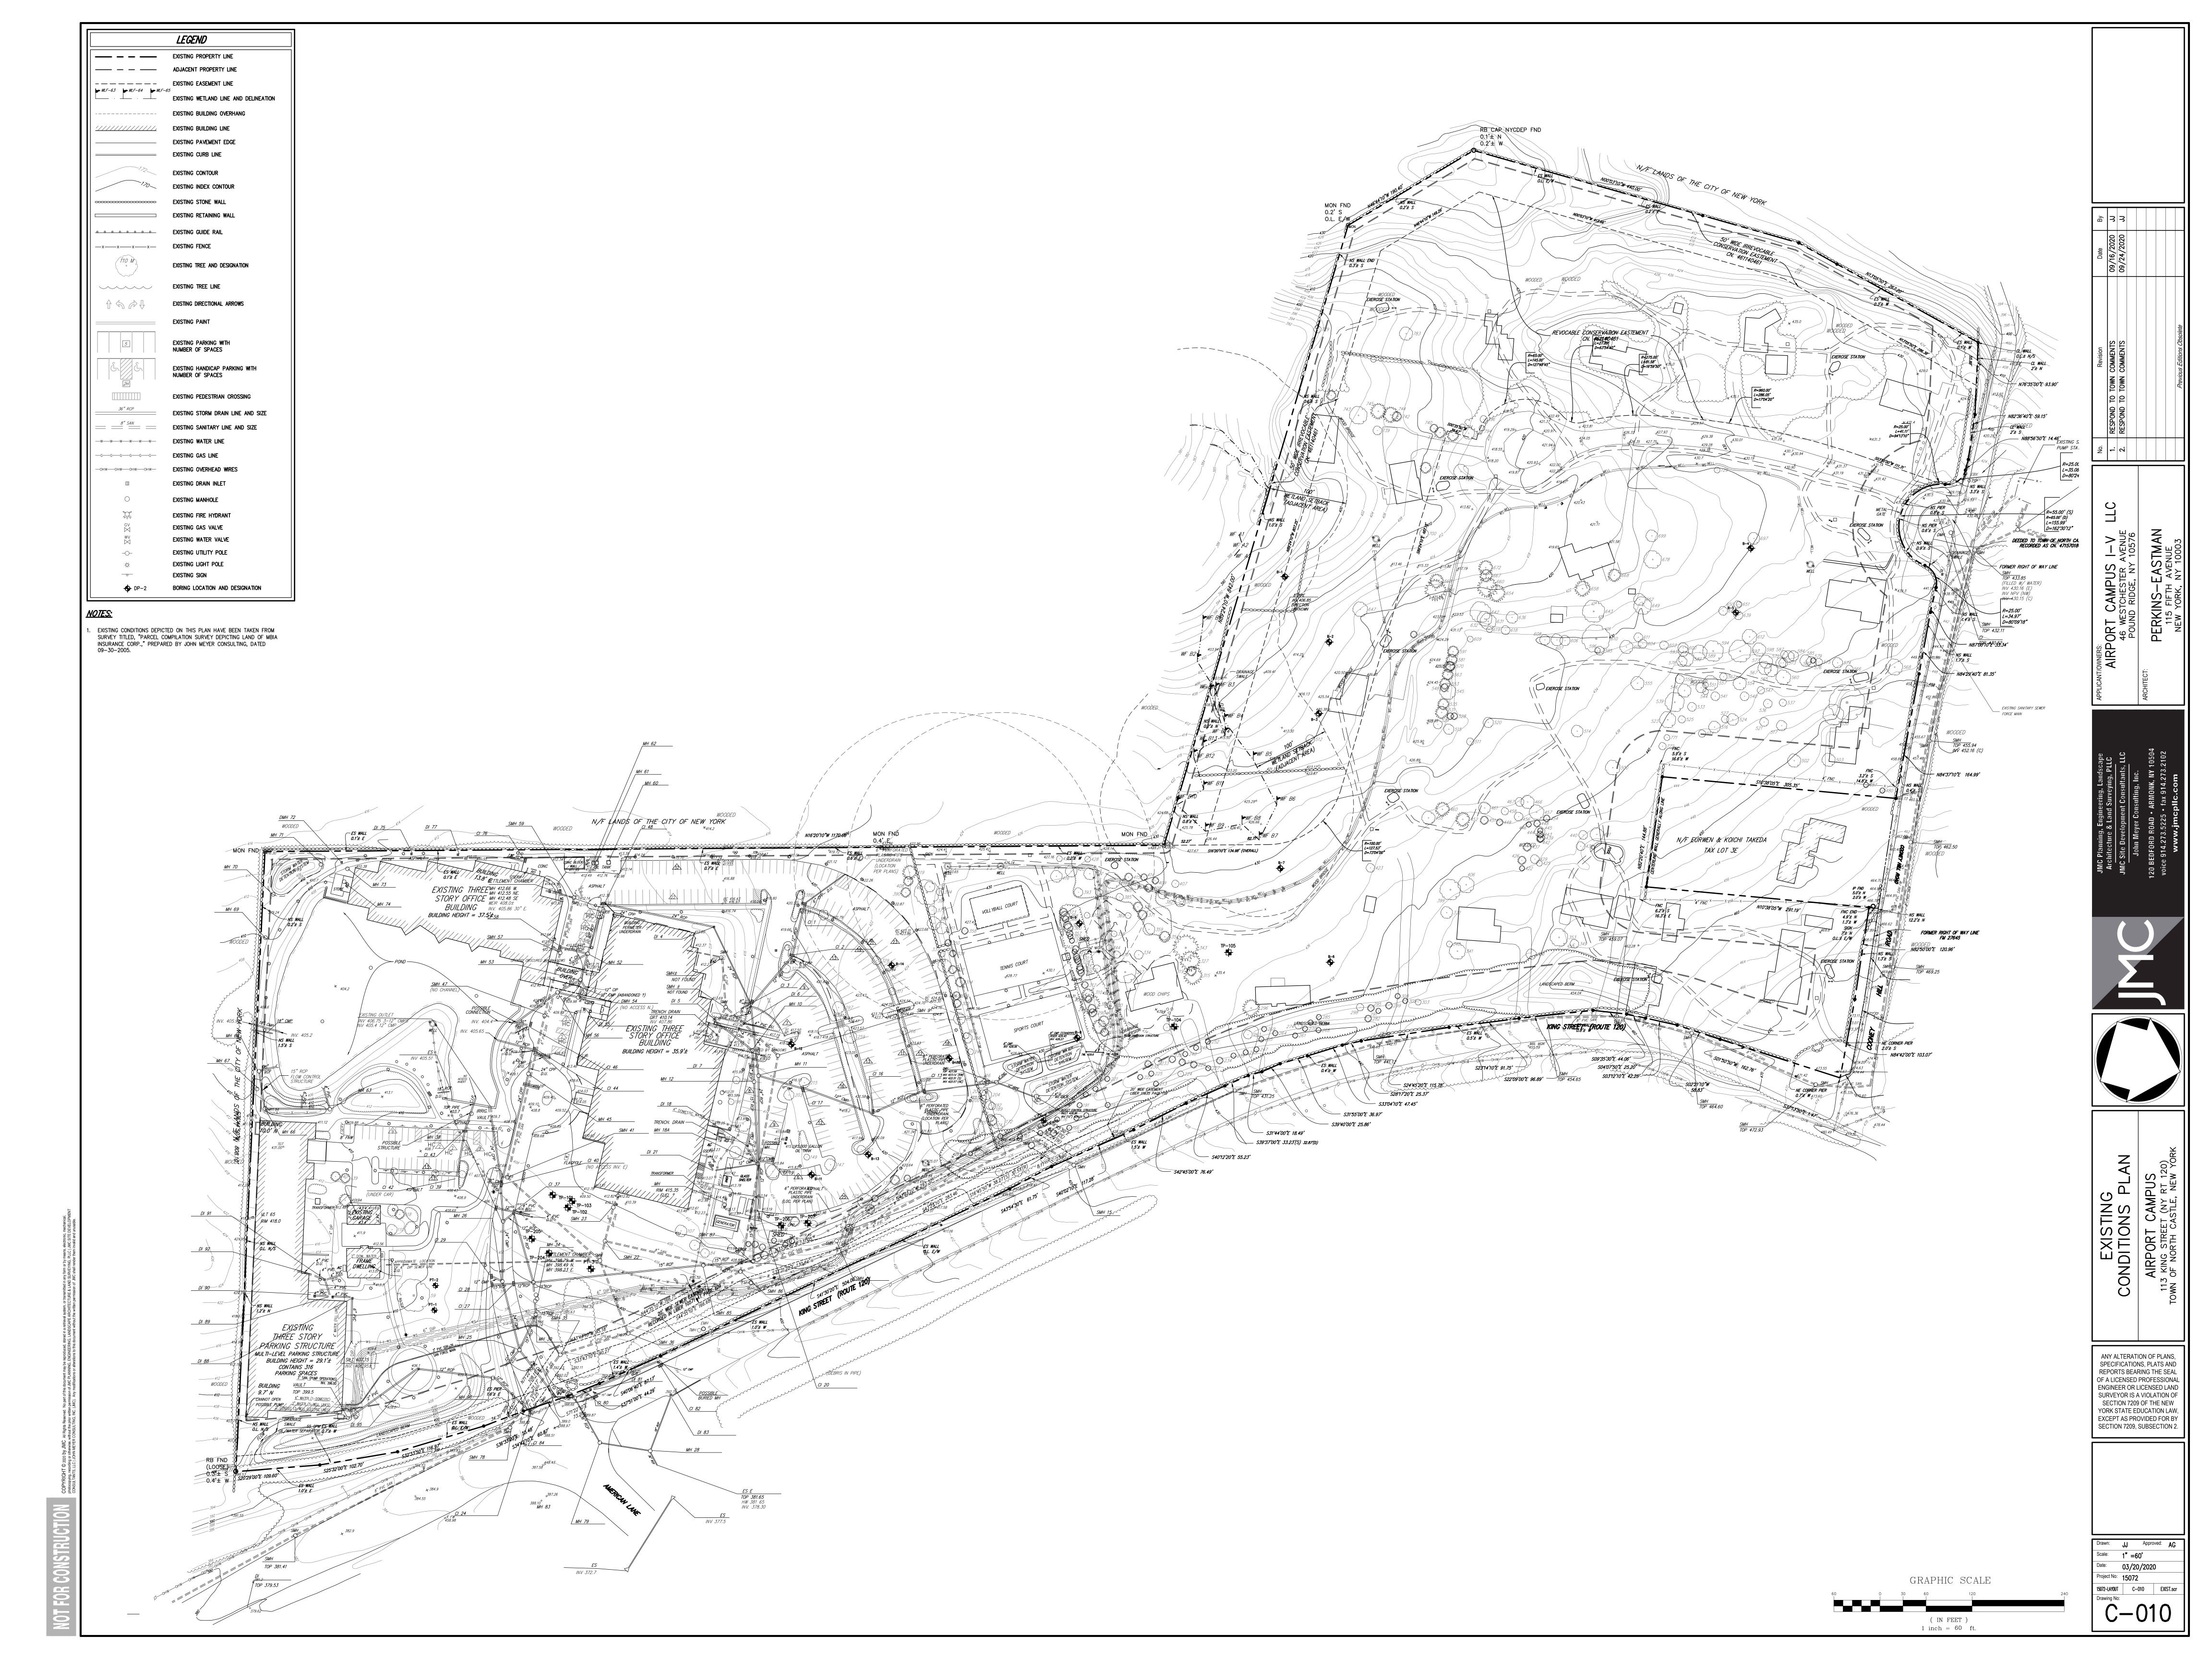


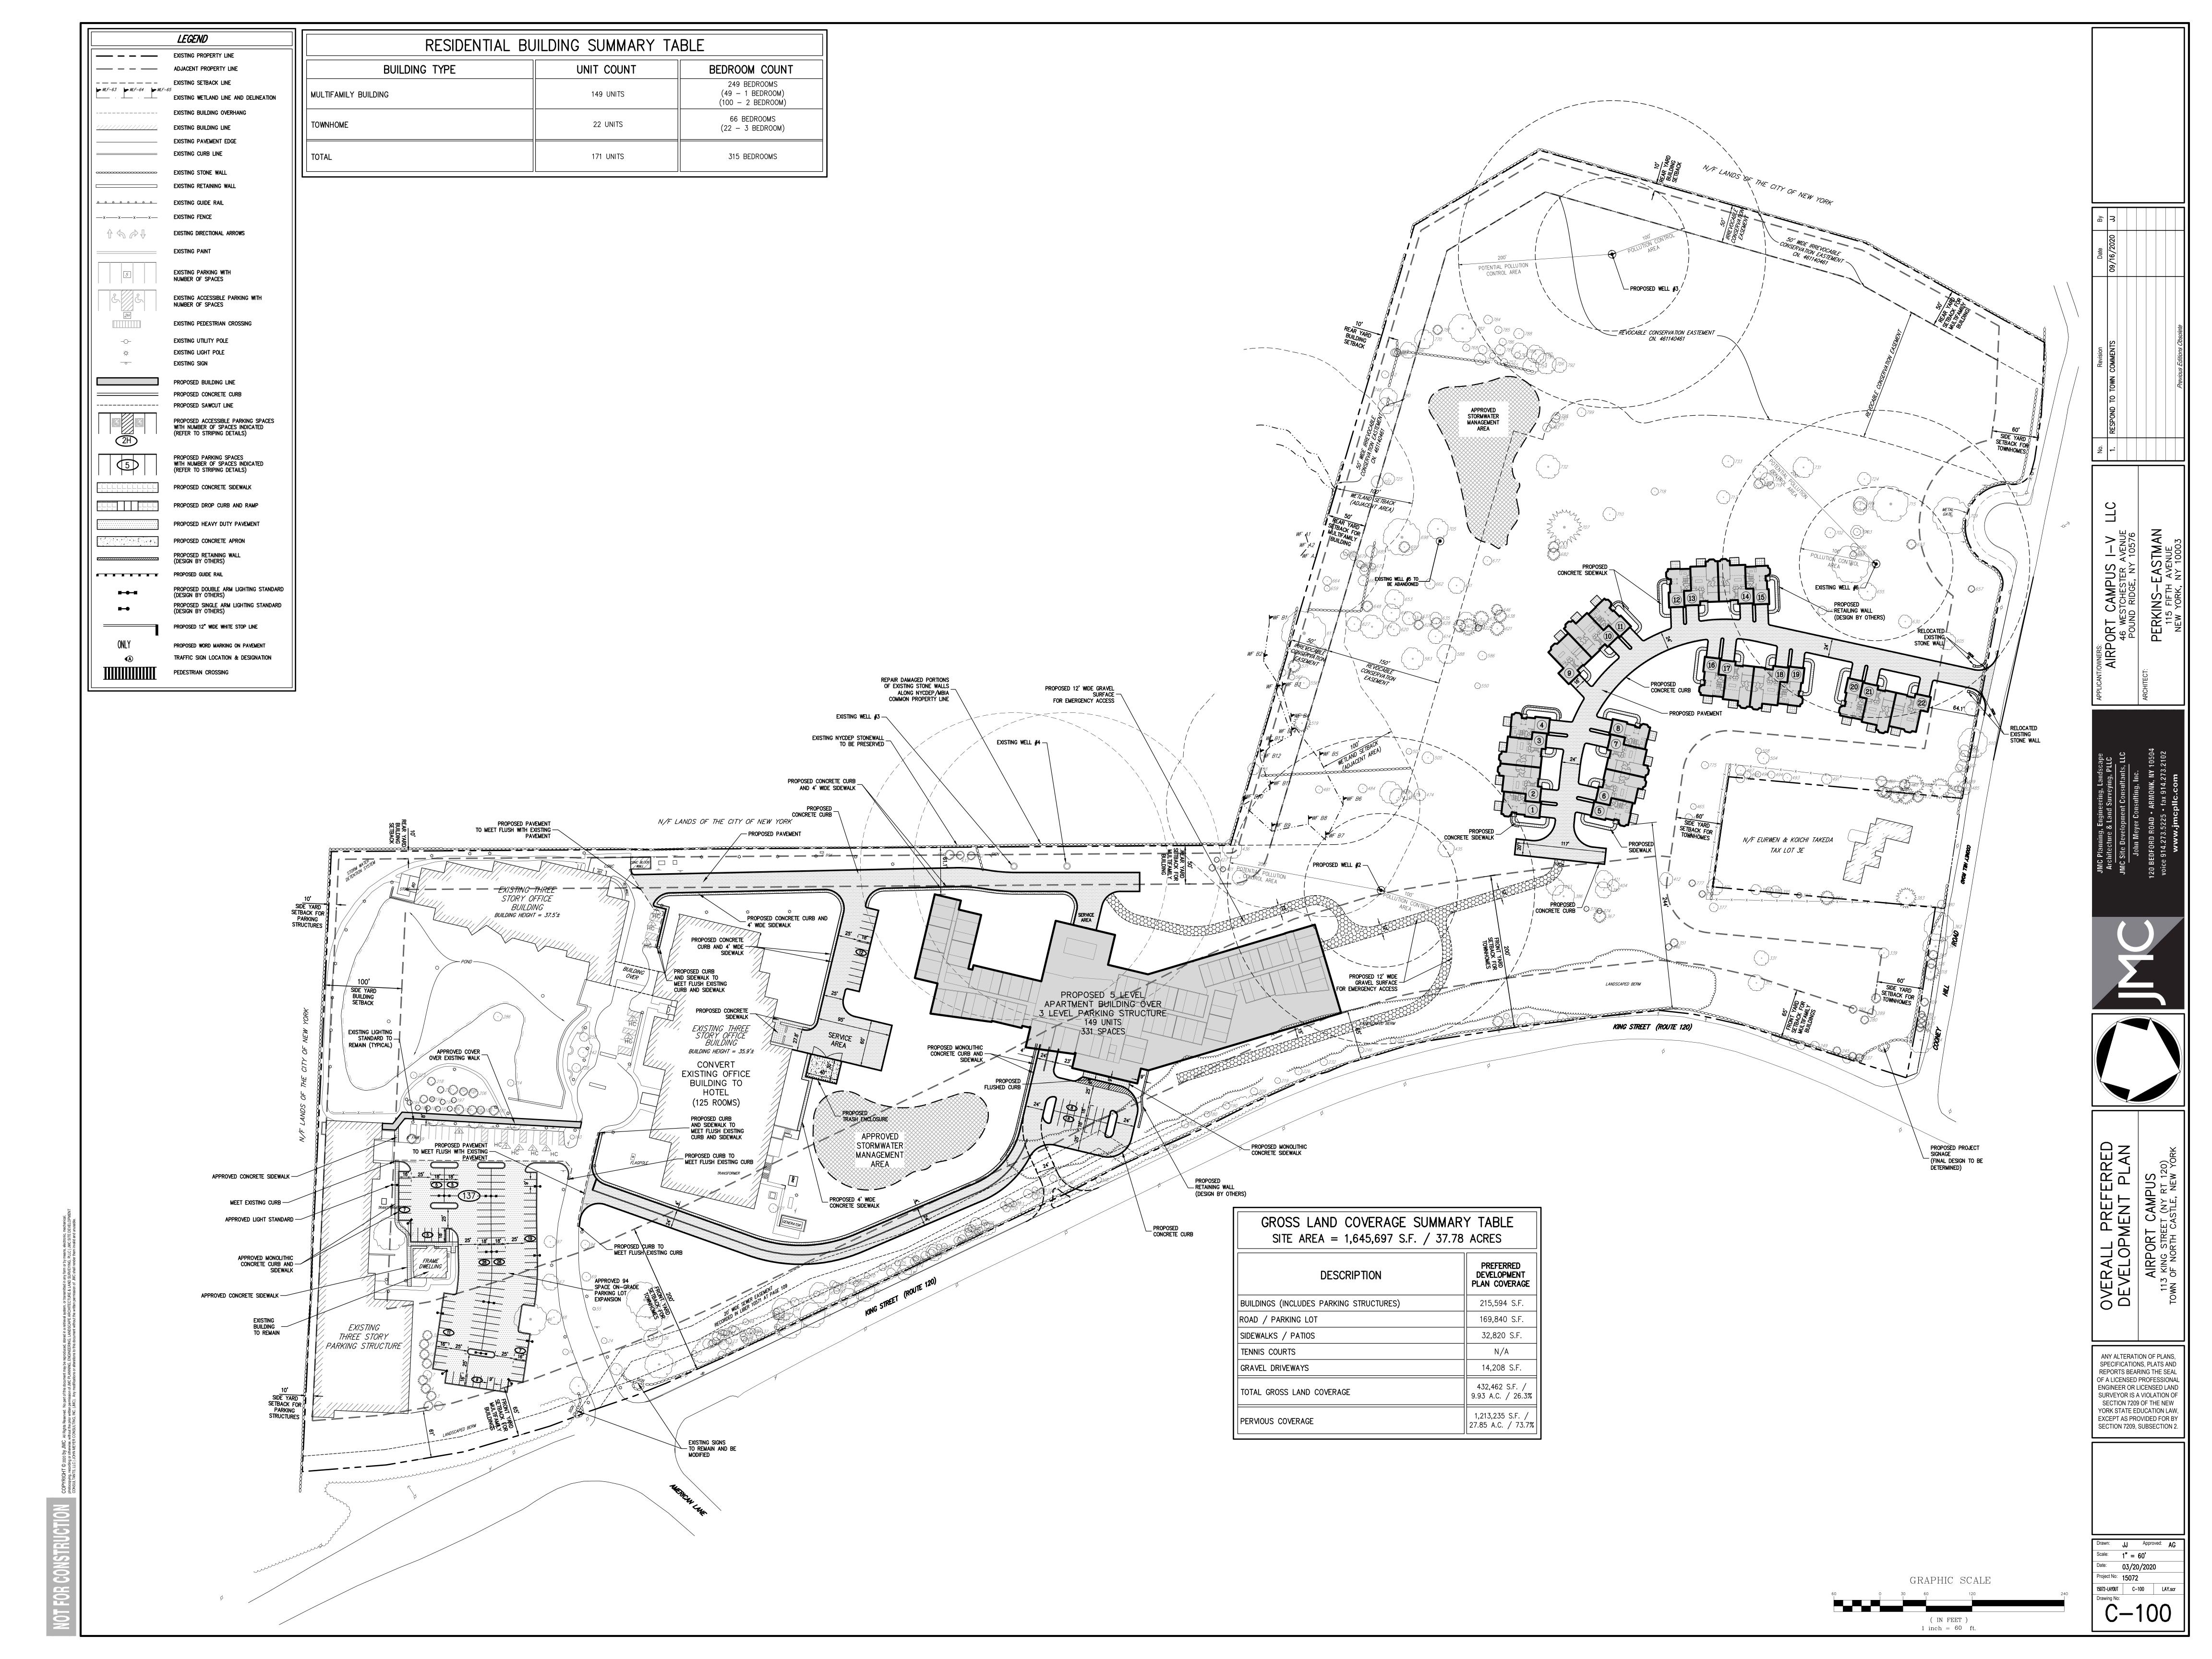

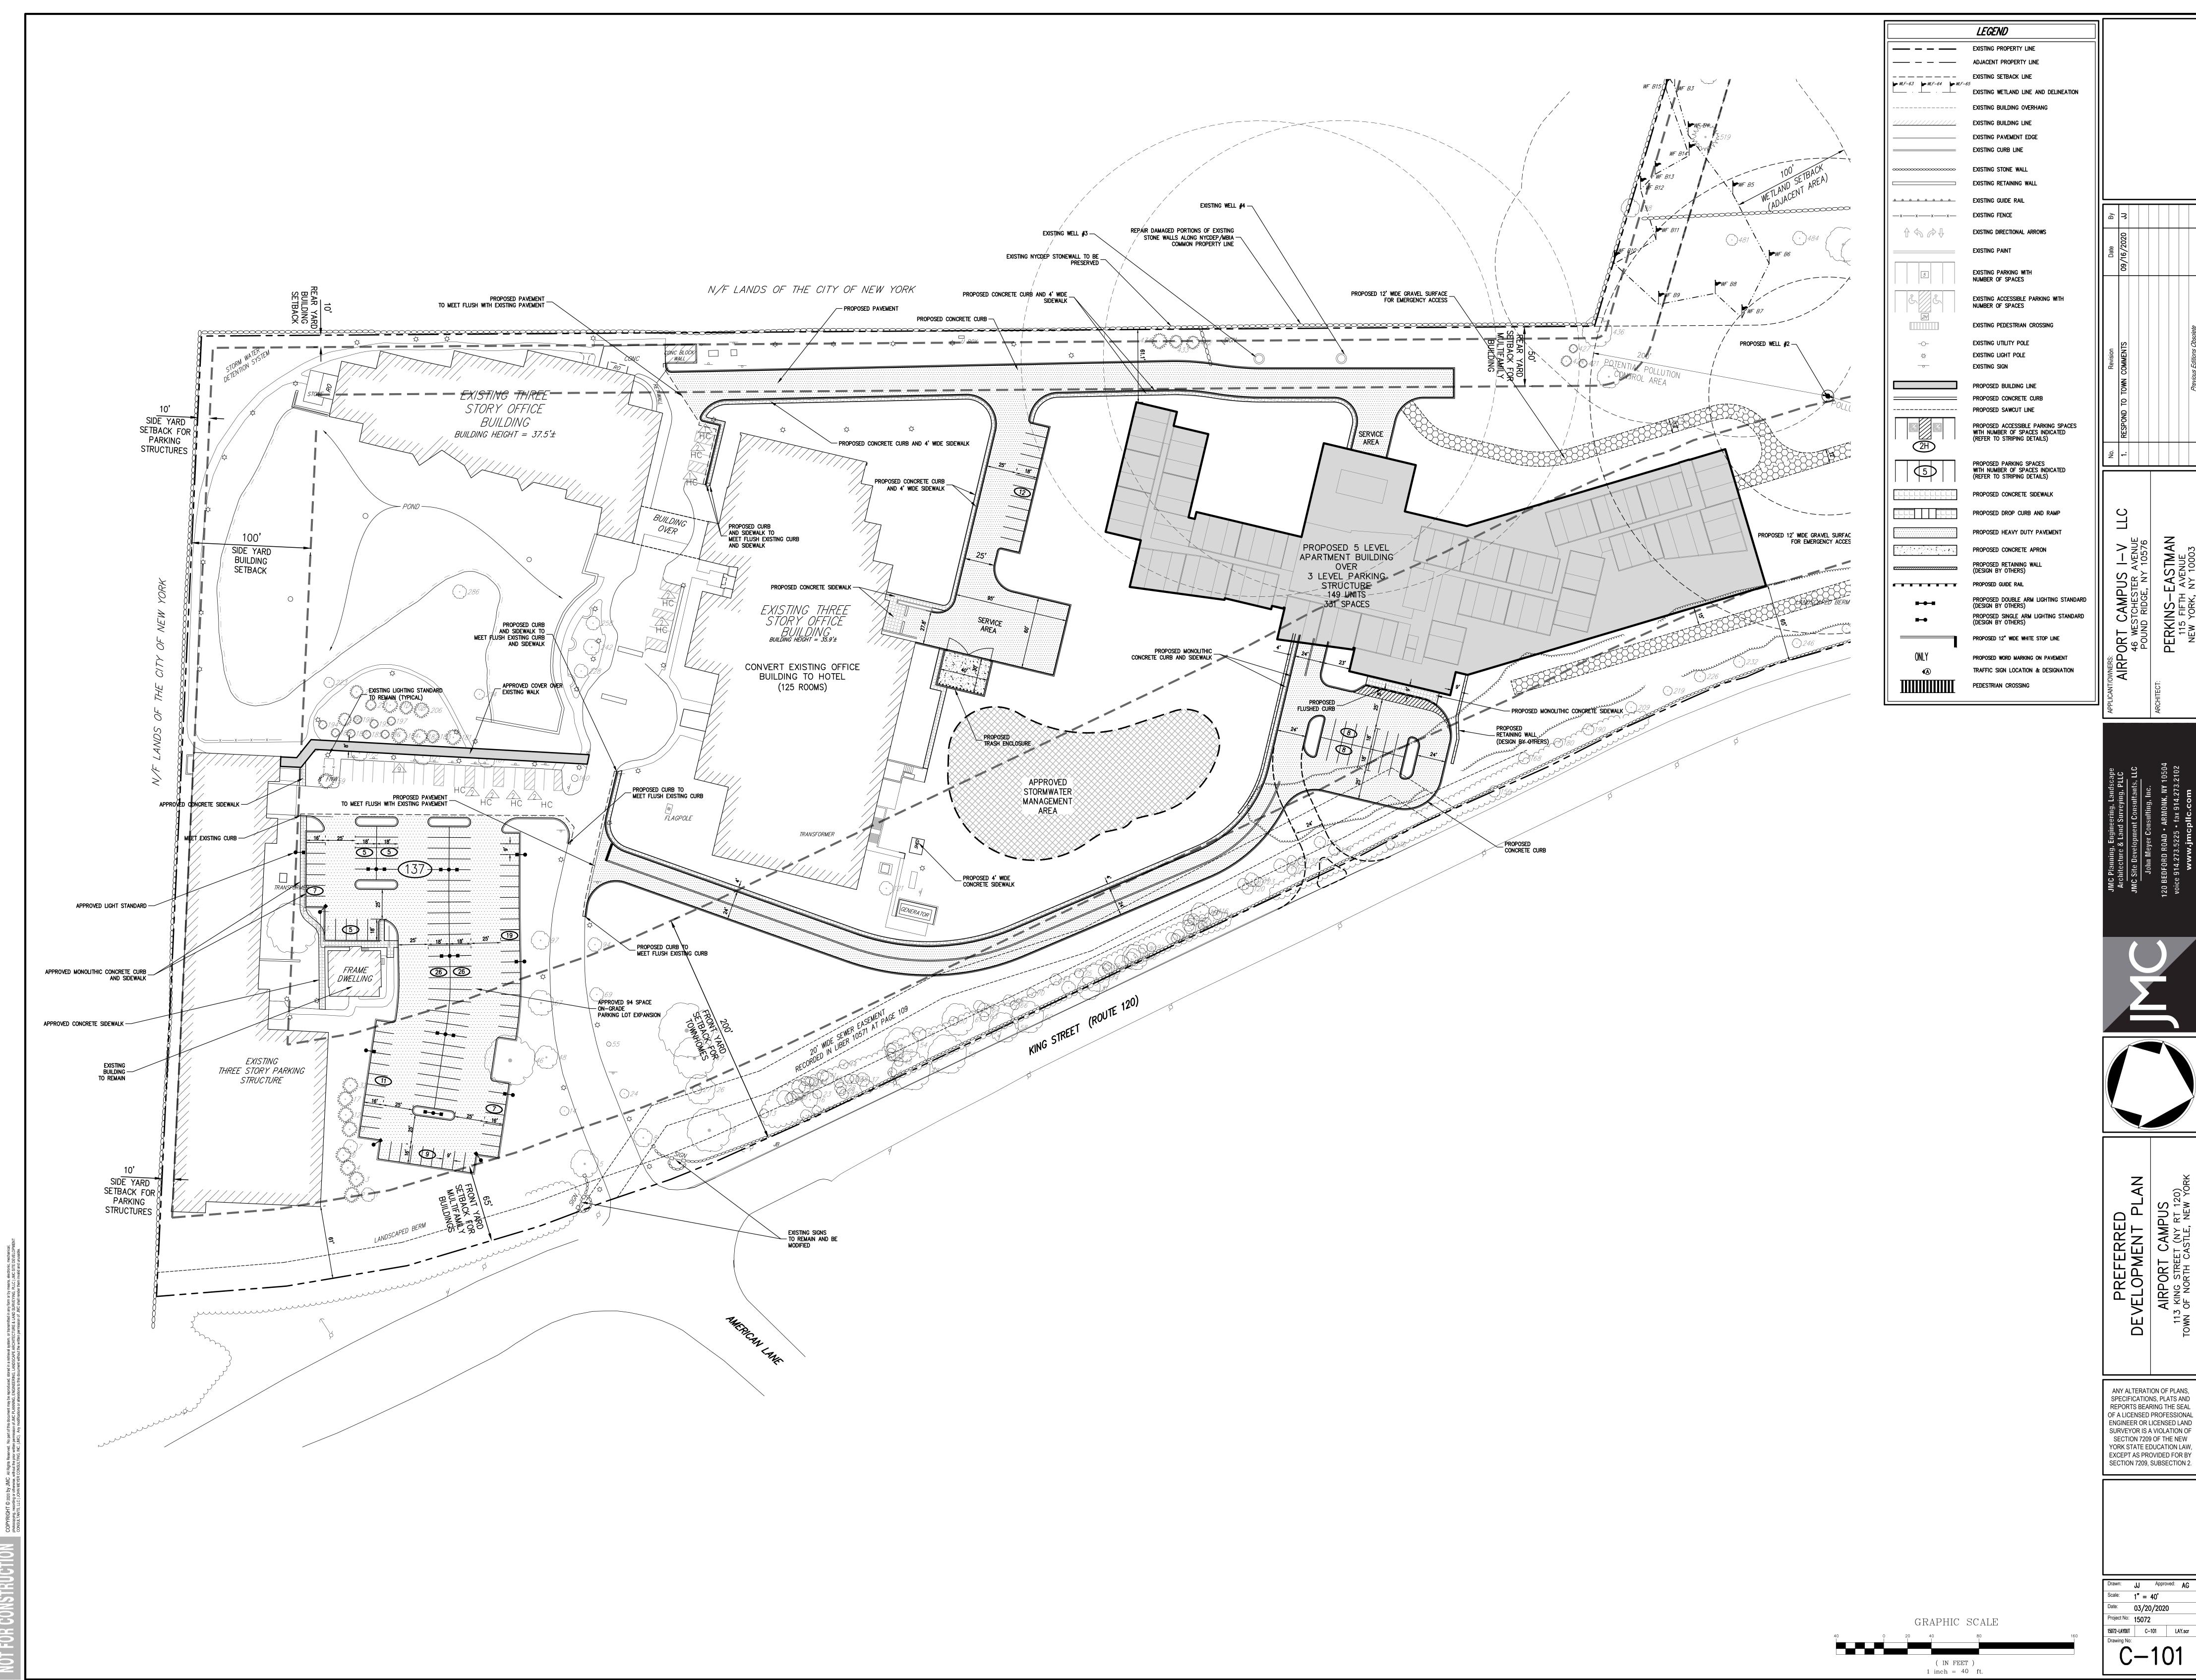

Drawn: JJ Approved: AG Scale: 1" = 40' 03/20/2020 15072-LAYOUT C-101 LAY.scr


C-101

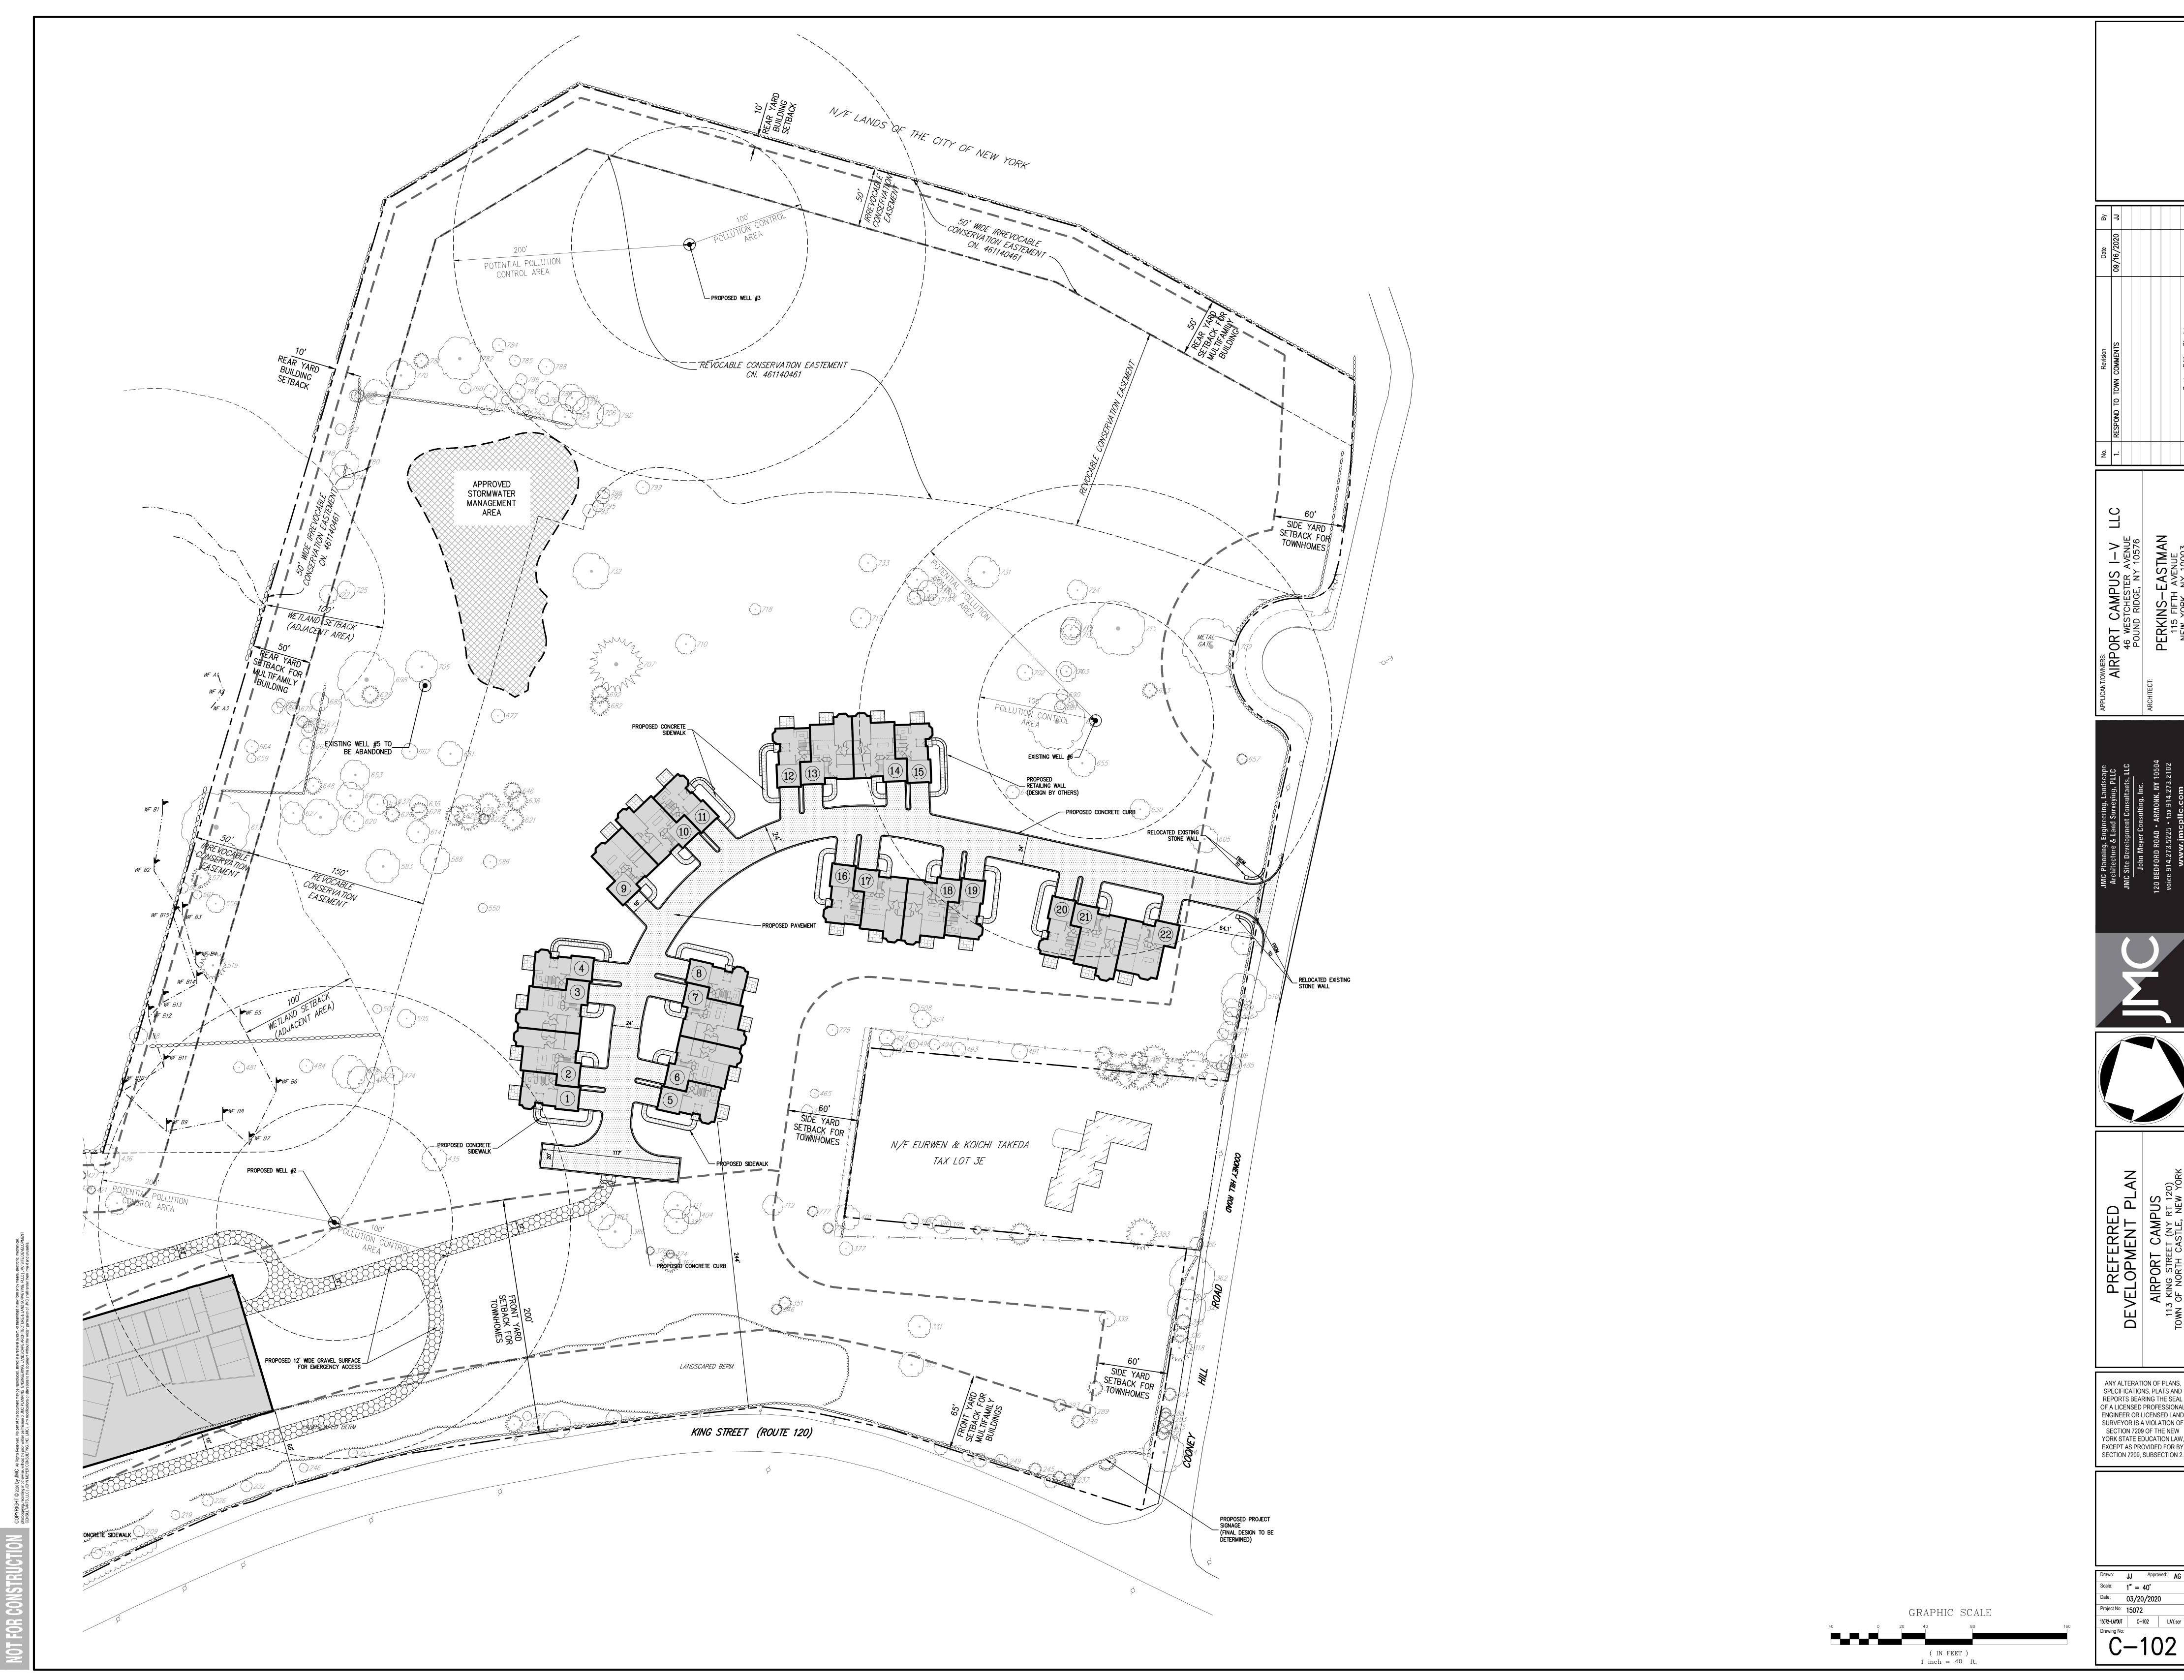

ANY ALTERATION OF PLANS, SPECIFICATIONS, PLATS AND REPORTS BEARING THE SEAL OF A LICENSED PROFESSIONAL ENGINEER OR LICENSED LAND SURVEYOR IS A VIOLATION OF SECTION 7209 OF THE NEW YORK STATE EDUCATION LAW, EXCEPT AS PROVIDED FOR BY SECTION 7209, SUBSECTION 2.

Drawn: JJ Approved: AG

Scale: 1" = 40' Date: 03/20/2020 15072-LAYOUT C-102 LAY.scr

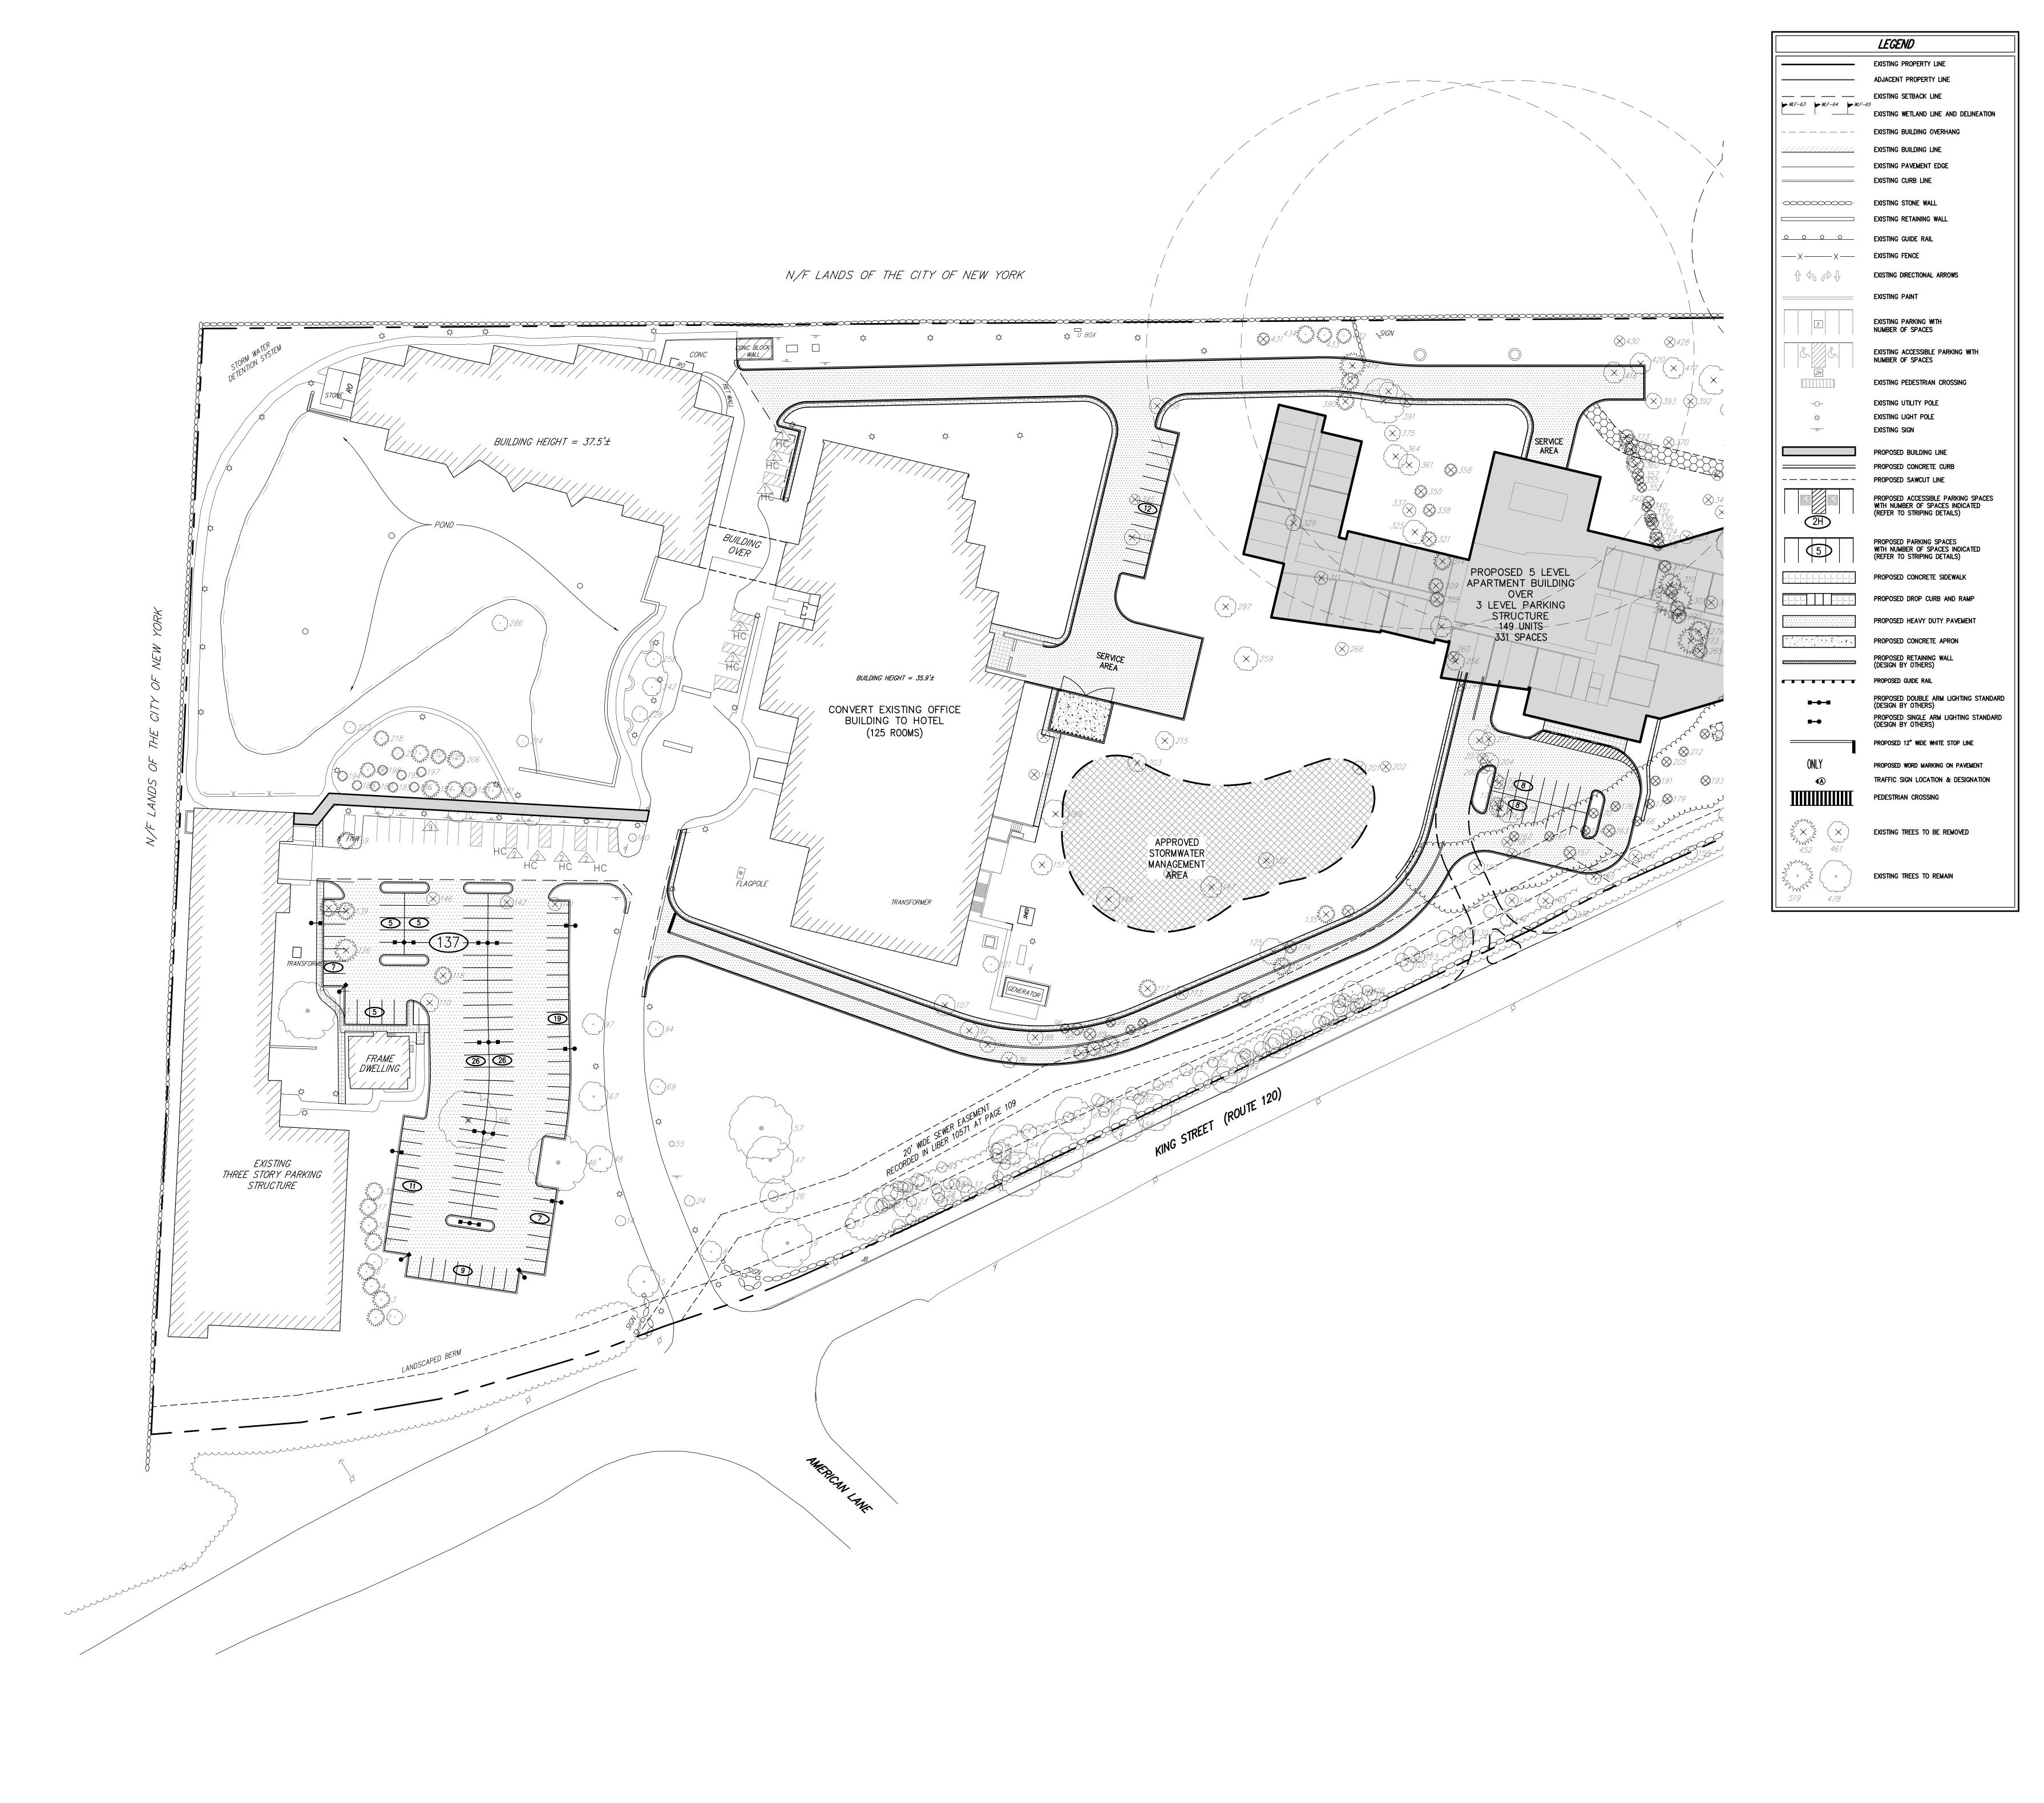

GRAPHIC SCALE (IN FEET) 1 inch = 40 ft.

Scale: 1" = 40'__ Date: 03/20/2020 Project No: 15072 15072-TREE-PROT C-151 TREE.scr

ANY ALTERATION OF PLANS,

SPECIFICATIONS, PLATS AND REPORTS BEARING THE SEAL OF A LICENSED PROFESSIONAL


ENGINEER OR LICENSED LAND SURVEYOR IS A VIOLATION OF SECTION 7209 OF THE NEW YORK STATE EDUCATION LAW,

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AIRPORT CAMPUS I-V L
46 WESTCHESTER AVENUE
POUND RIDGE, NY 10576
II:
PERKINS-EASTMAN
115 FIFTH AVENUE
NEW YORK, NY 10003

C-151

PROTECTION

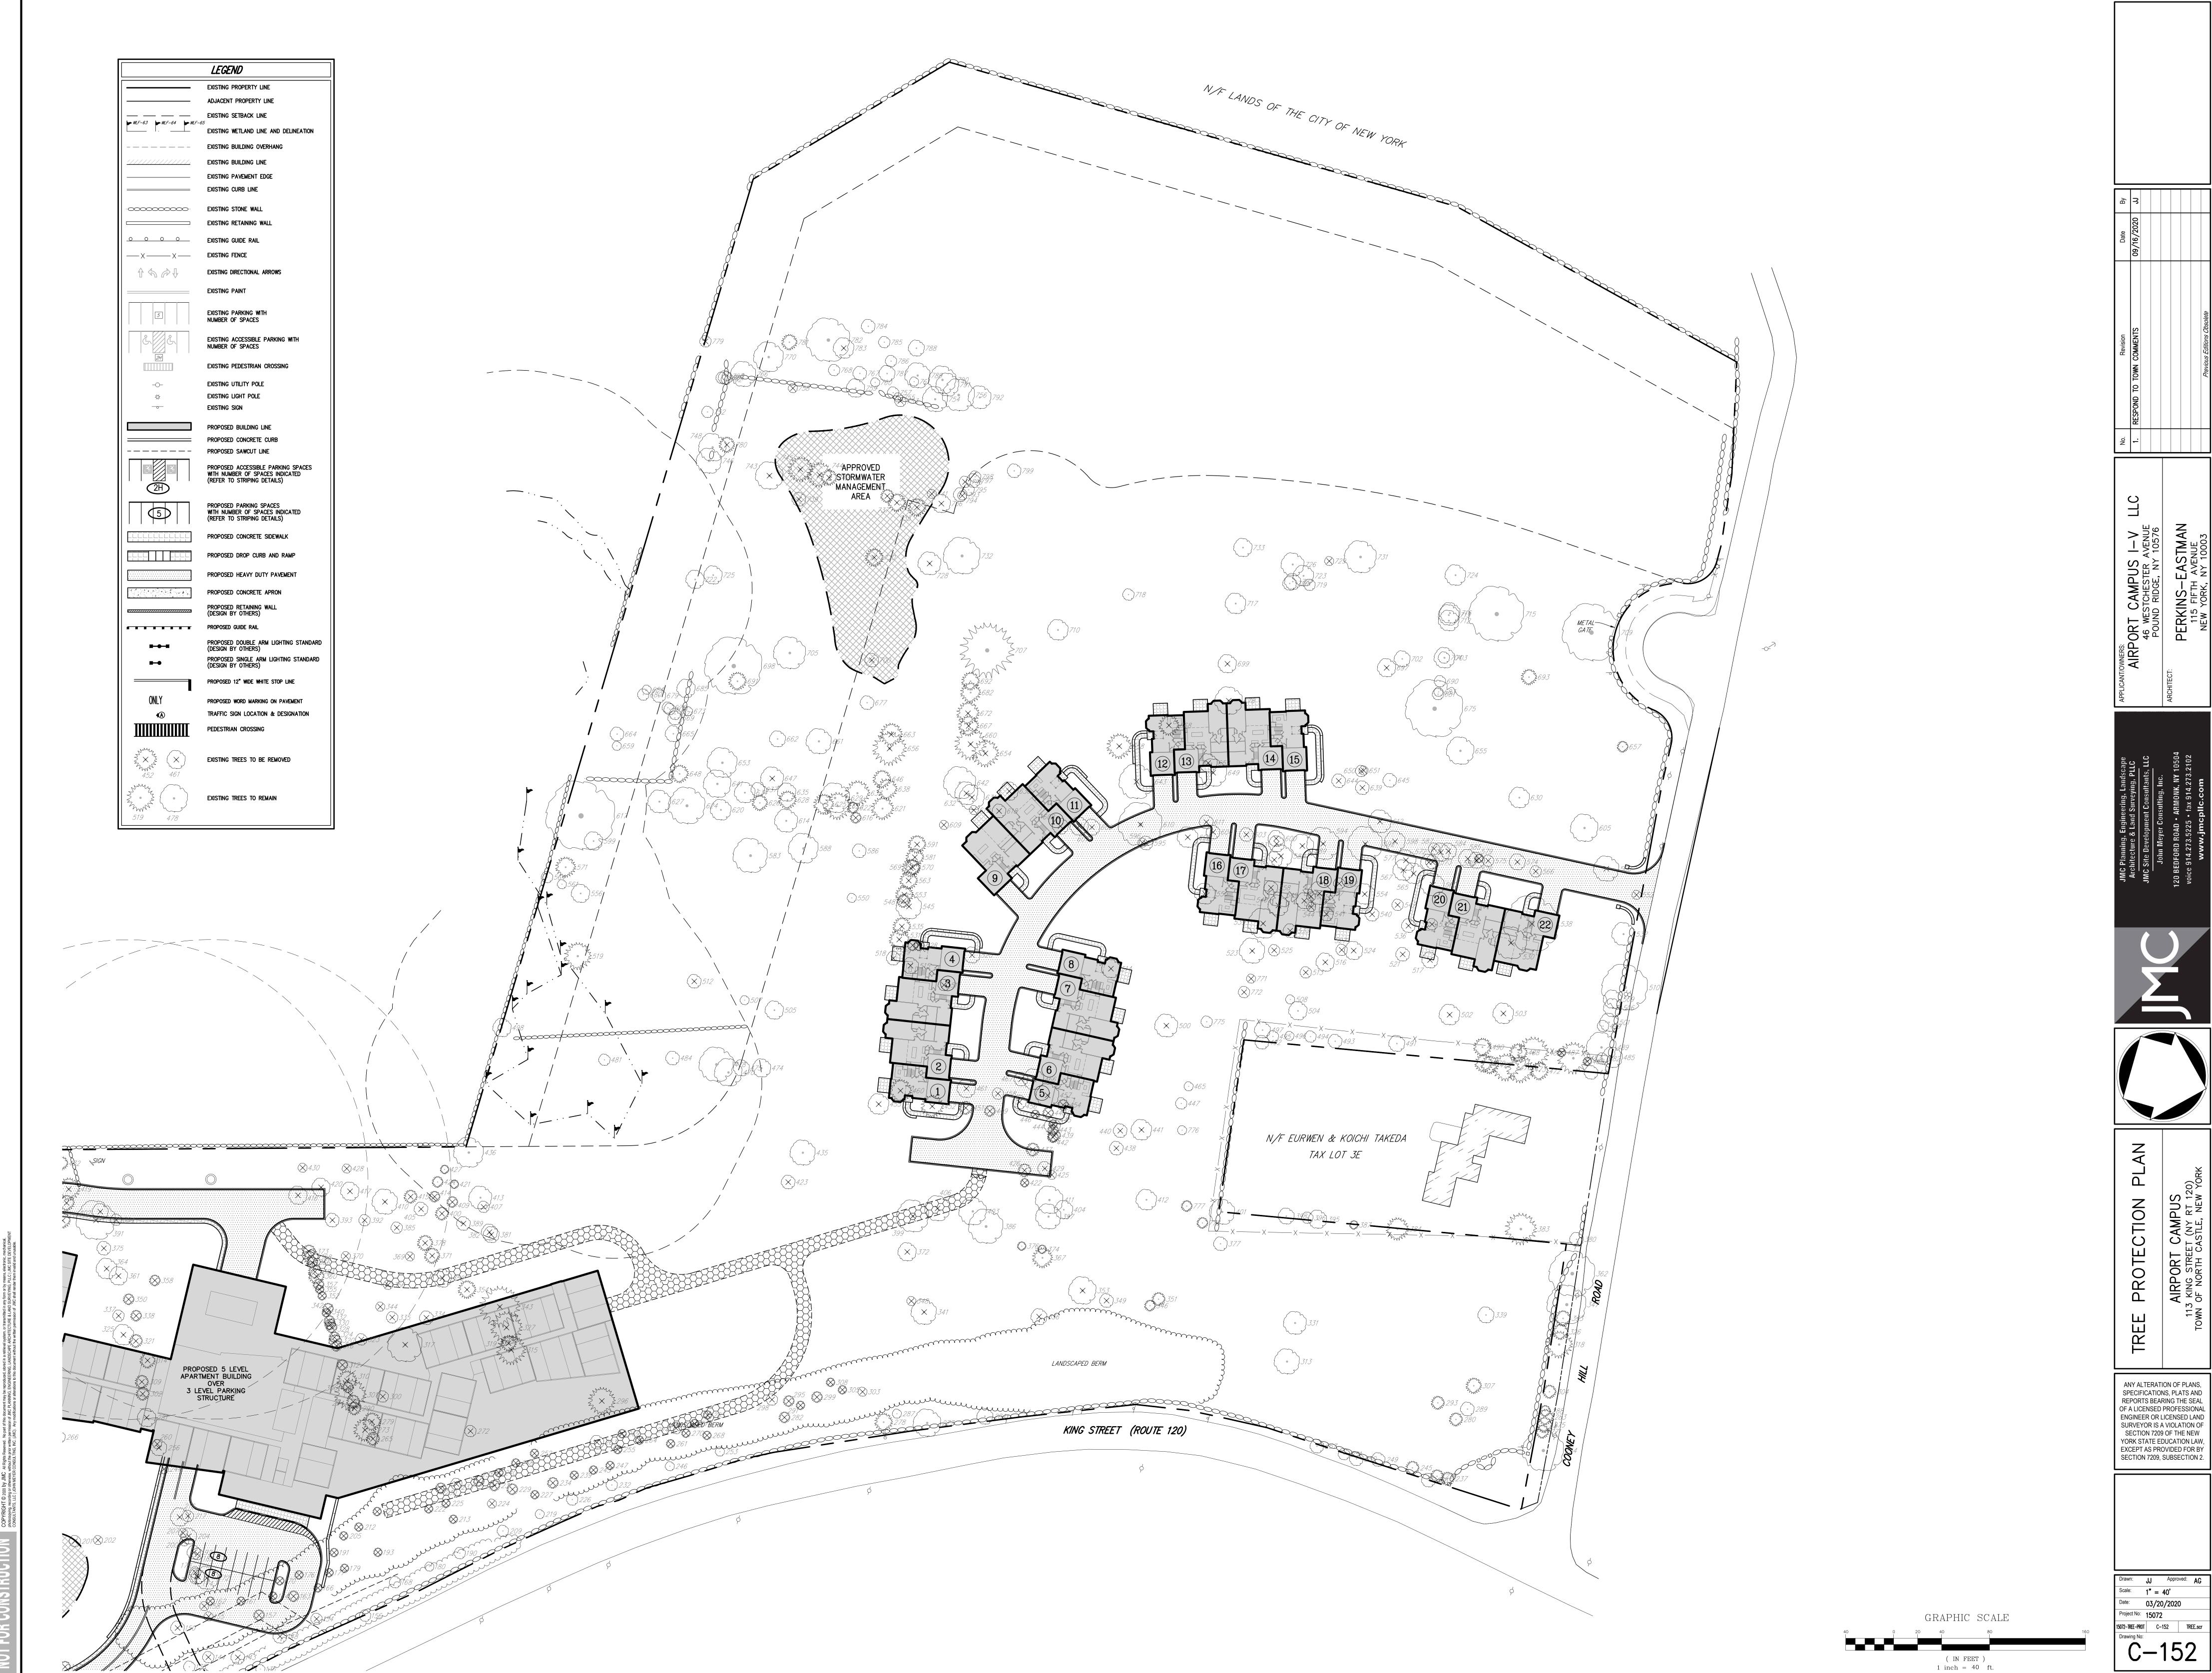

POOR

REMOVE

SPRUCE

Scale: N.T.S. 03/20/2020 Project No: **15072** 15072-TREE-PROT C-153 TREE.scr

ANY ALTERATION OF PLANS,

SPECIFICATIONS, PLATS AND REPORTS BEARING THE SEAL

OF A LICENSED PROFESSIONAL

ENGINEER OR LICENSED LAND SURVEYOR IS A VIOLATION OF

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RT CAMPUS I—V LLC

6 WESTCHESTER AVENUE
POUND RIDGE, NY 10576

ERKINS—EASTMAN

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JMC Site Development Consultants, LLC
John Meyer Consulting, Inc.
120 BEDFORD ROAD • ARMONK, NY 10504
voice 914.273.5225 • fax 914.273.2102
www.jmcpllc.com



RPORT CAMPUS

NORTH CASTLE, NEW YORK

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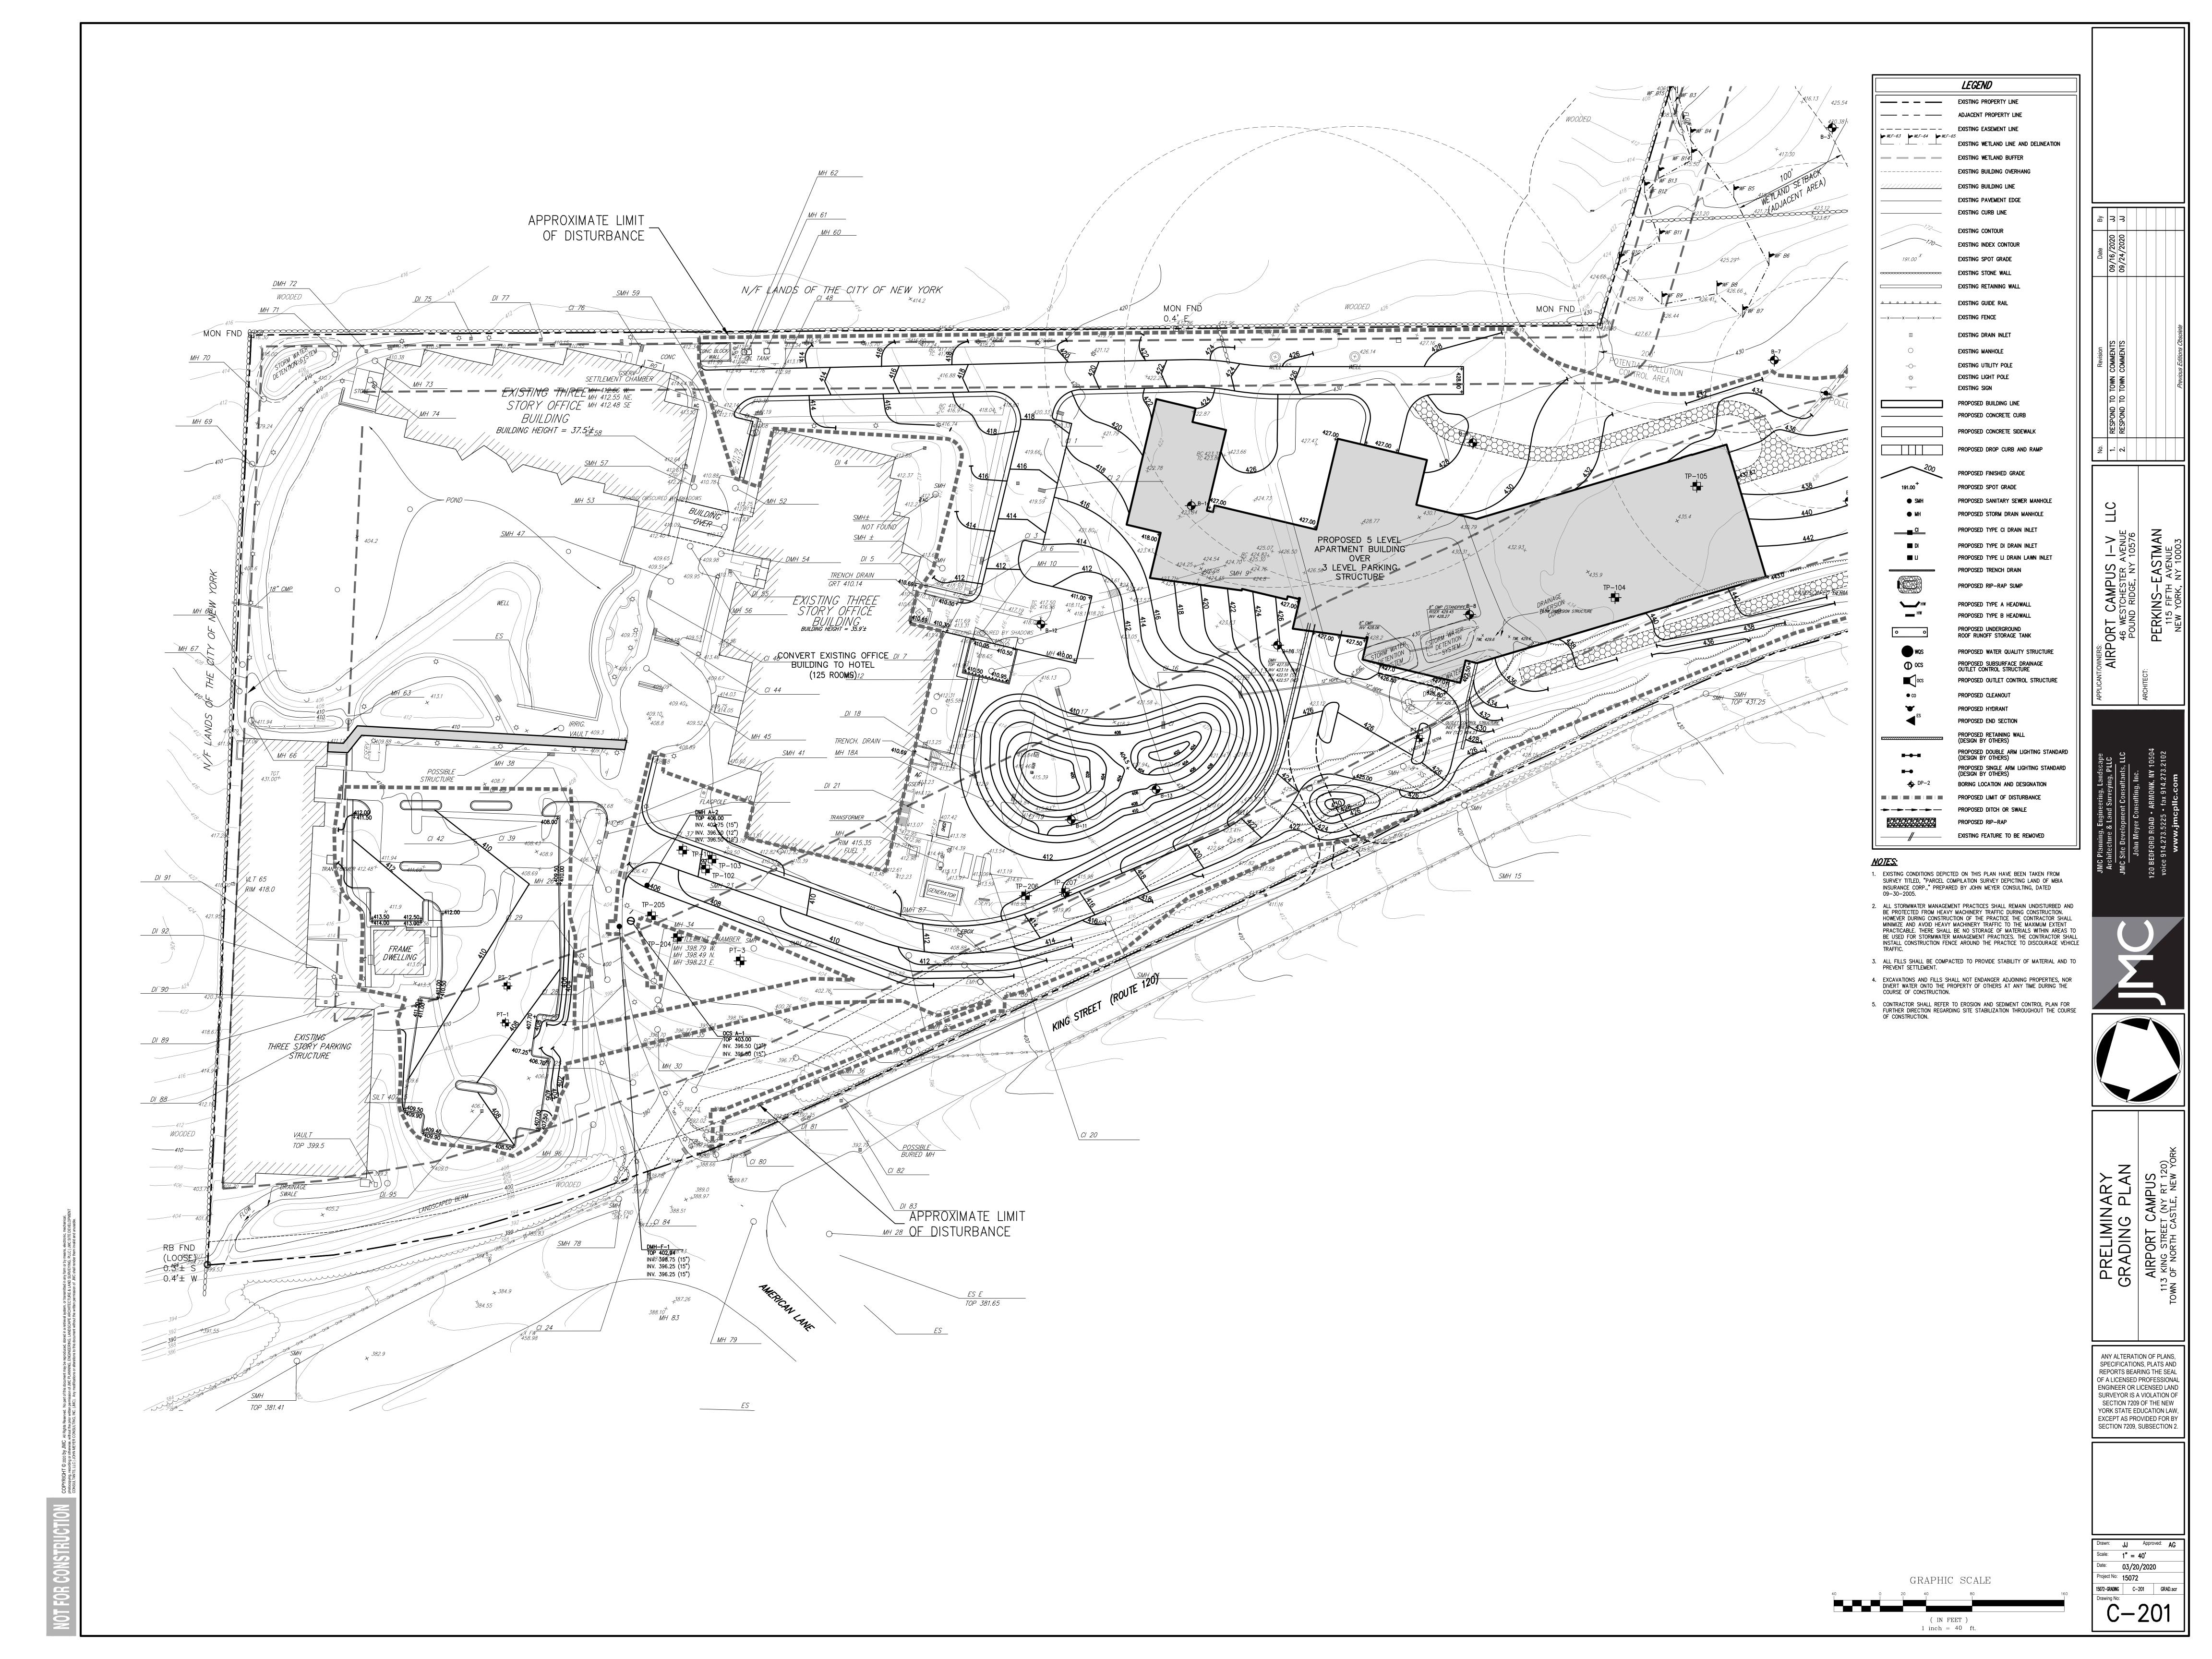
 Date:
 03/20/2020

 Project No:
 15072

 15072-TREE-PROT
 C-154
 TREE.scr

 Drawing No:

C-154





416.5 E 410.35 6" E 407.58 24" E 407.7 6" E 407.65 8" SE 406.9 S 407.8 E 407.0 NE 408.1 WATER ------------___ ---------------407.9 E 407.95 W ---404.5 E 407.8 SE ---------416.77 SW ---------412.67 SW ------405.8 SW ------408.94 S 409.2 WATER ---410.3± E 409.9 SILT ------409.95 SILT 409.45 N ---385.4 SW ---385.96 W ---------393.81 N ------------------------------------394.1± W 394.4± N 402.80 E 402.62 SW 403.7± 4" PVC ---391.9 W 392.0 E ------------400.9 S ------------------406.4 NE ------403.5± W ---------405.7 30" ------406.05 E ------407.45 W ------405.9± N 405.2 SE ---------------------------------------406.0 S 406.0 E --385.43 N ---------------------------------408.29 E 408.66 SW 409.03 N 408.80 N 403.95 N INVERT ---391.9 N 391.8 S 404.64 E-W ---------


GRAPHIC SCALE

(IN FEET) 1 inch = 40 ft.

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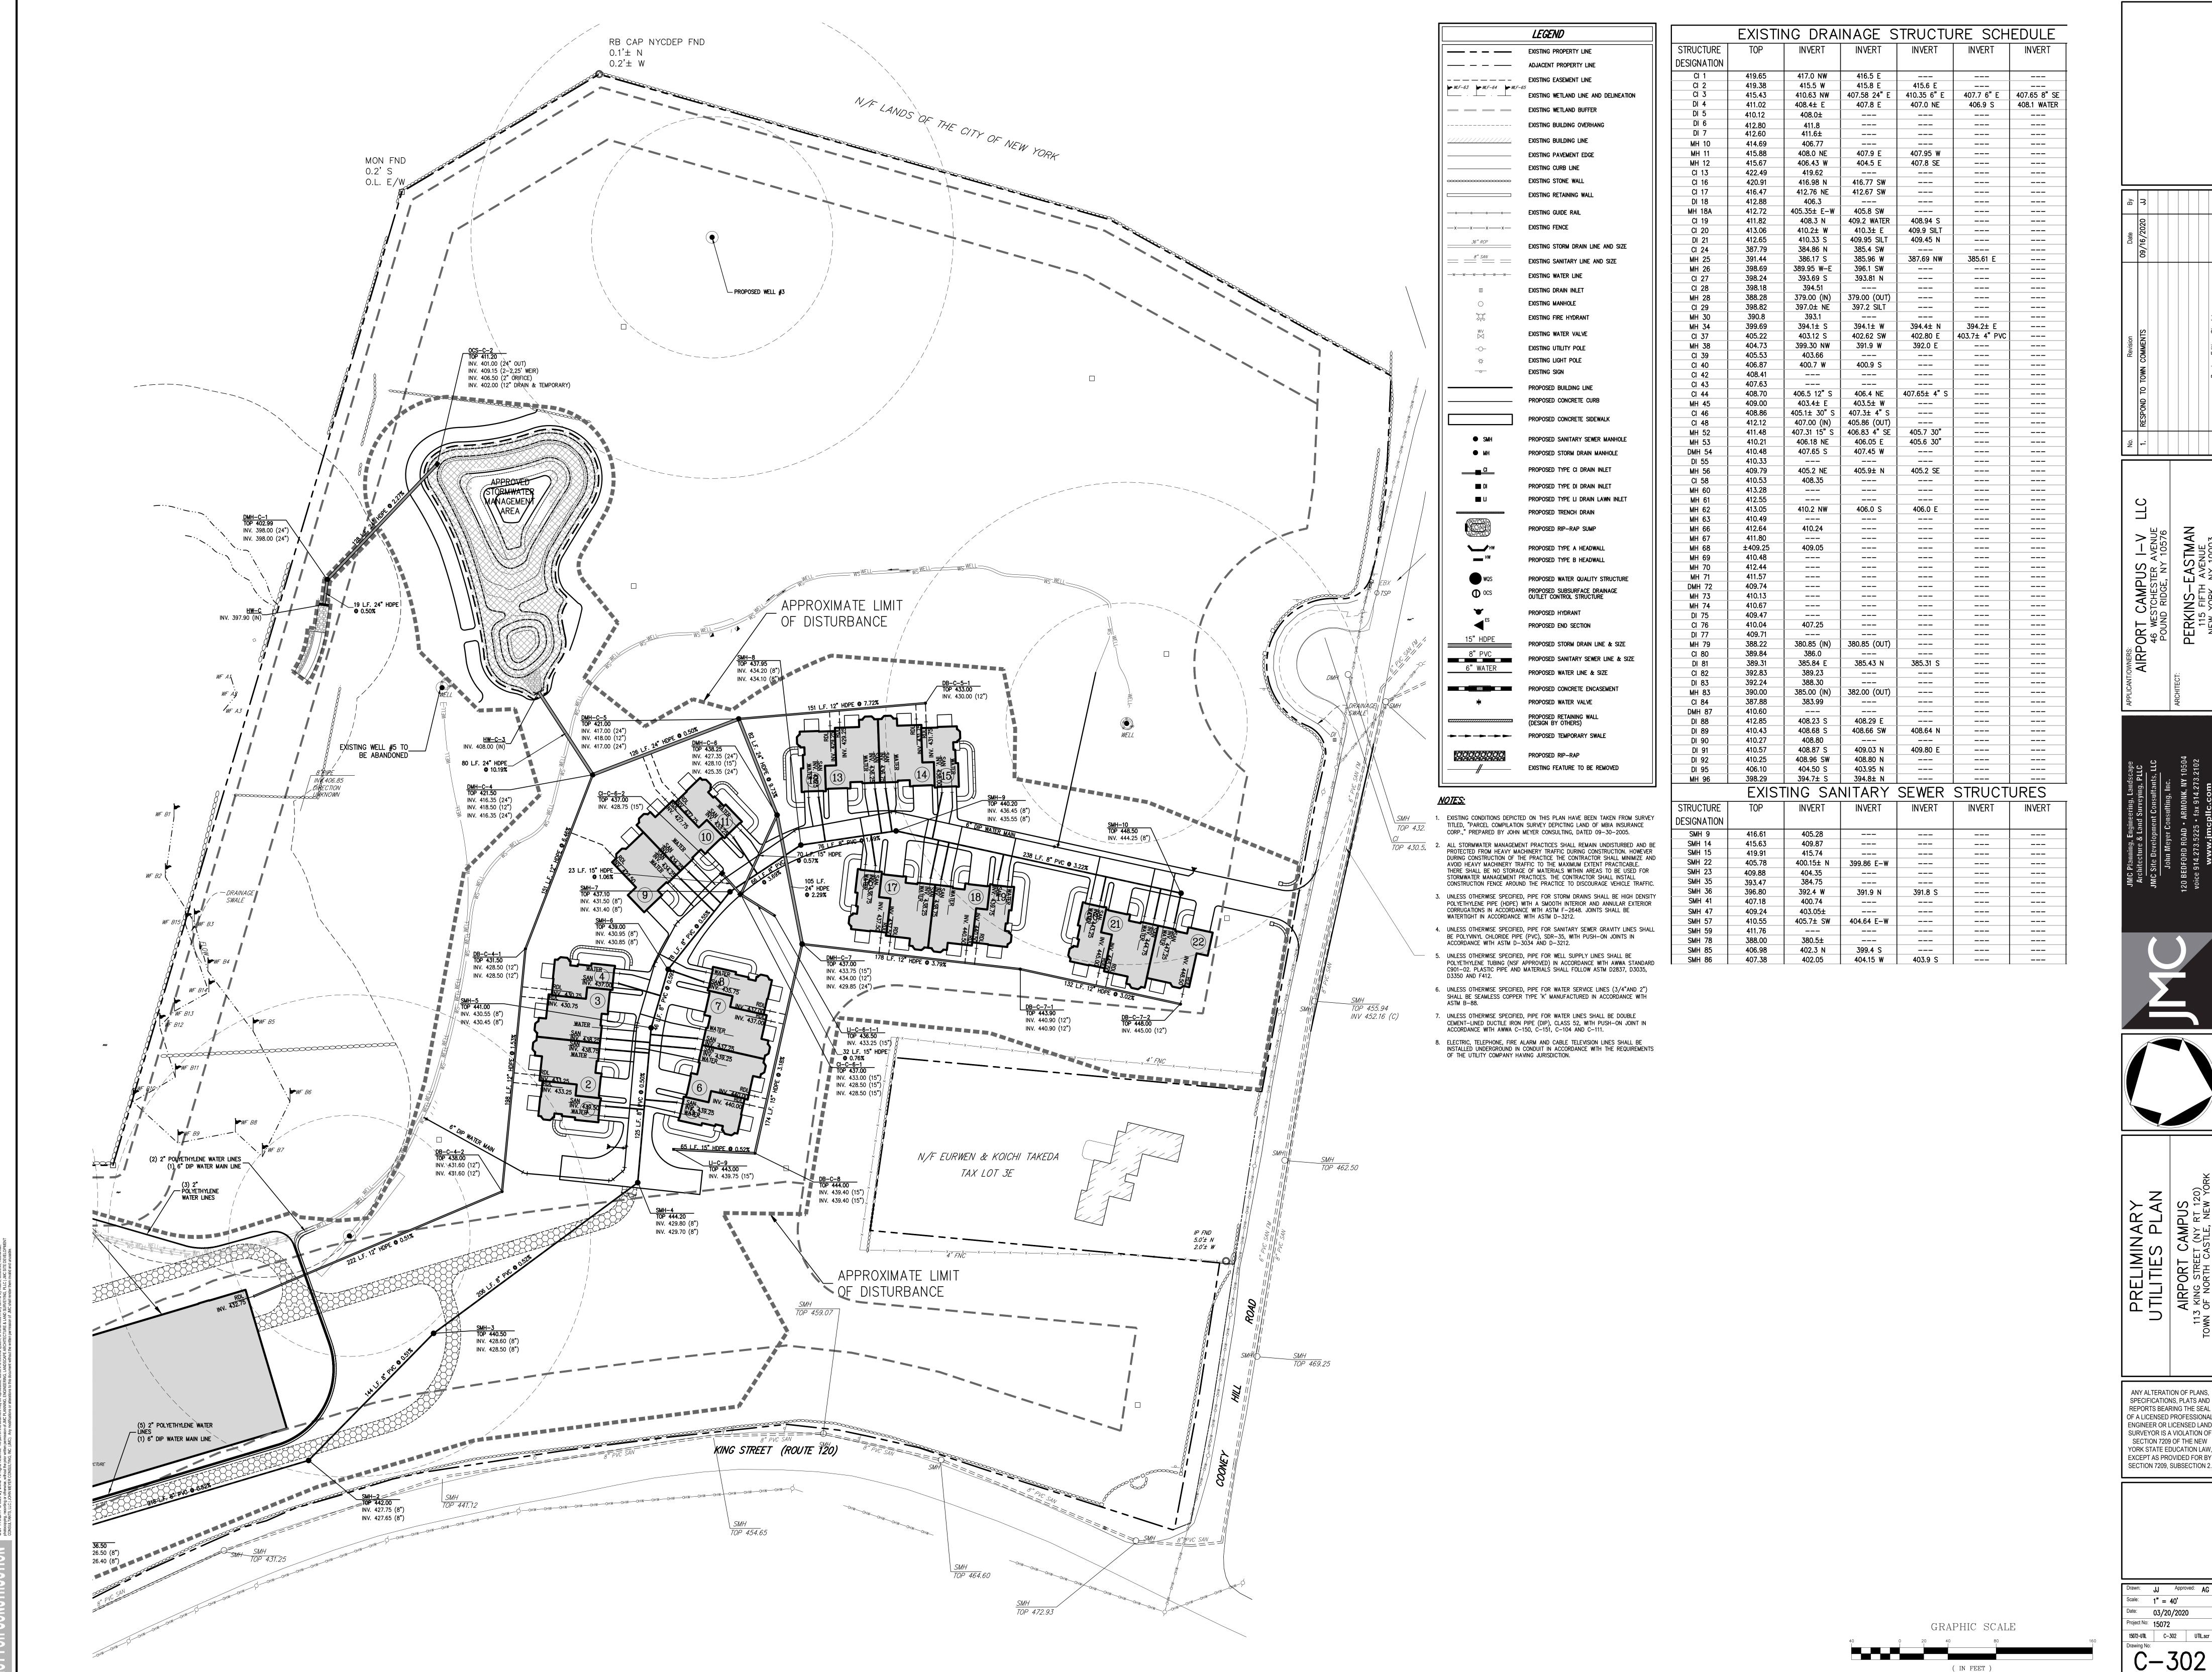
Scale: 1" = 40' 03/20/2020 Project No: 15072 15072-GRADING C-202 GRAD.scr C - 202



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Drawn: JJ Approved: AG Scale: 1" = 40' 03/20/2020 15072-UTIL C-301 UTIL.scr

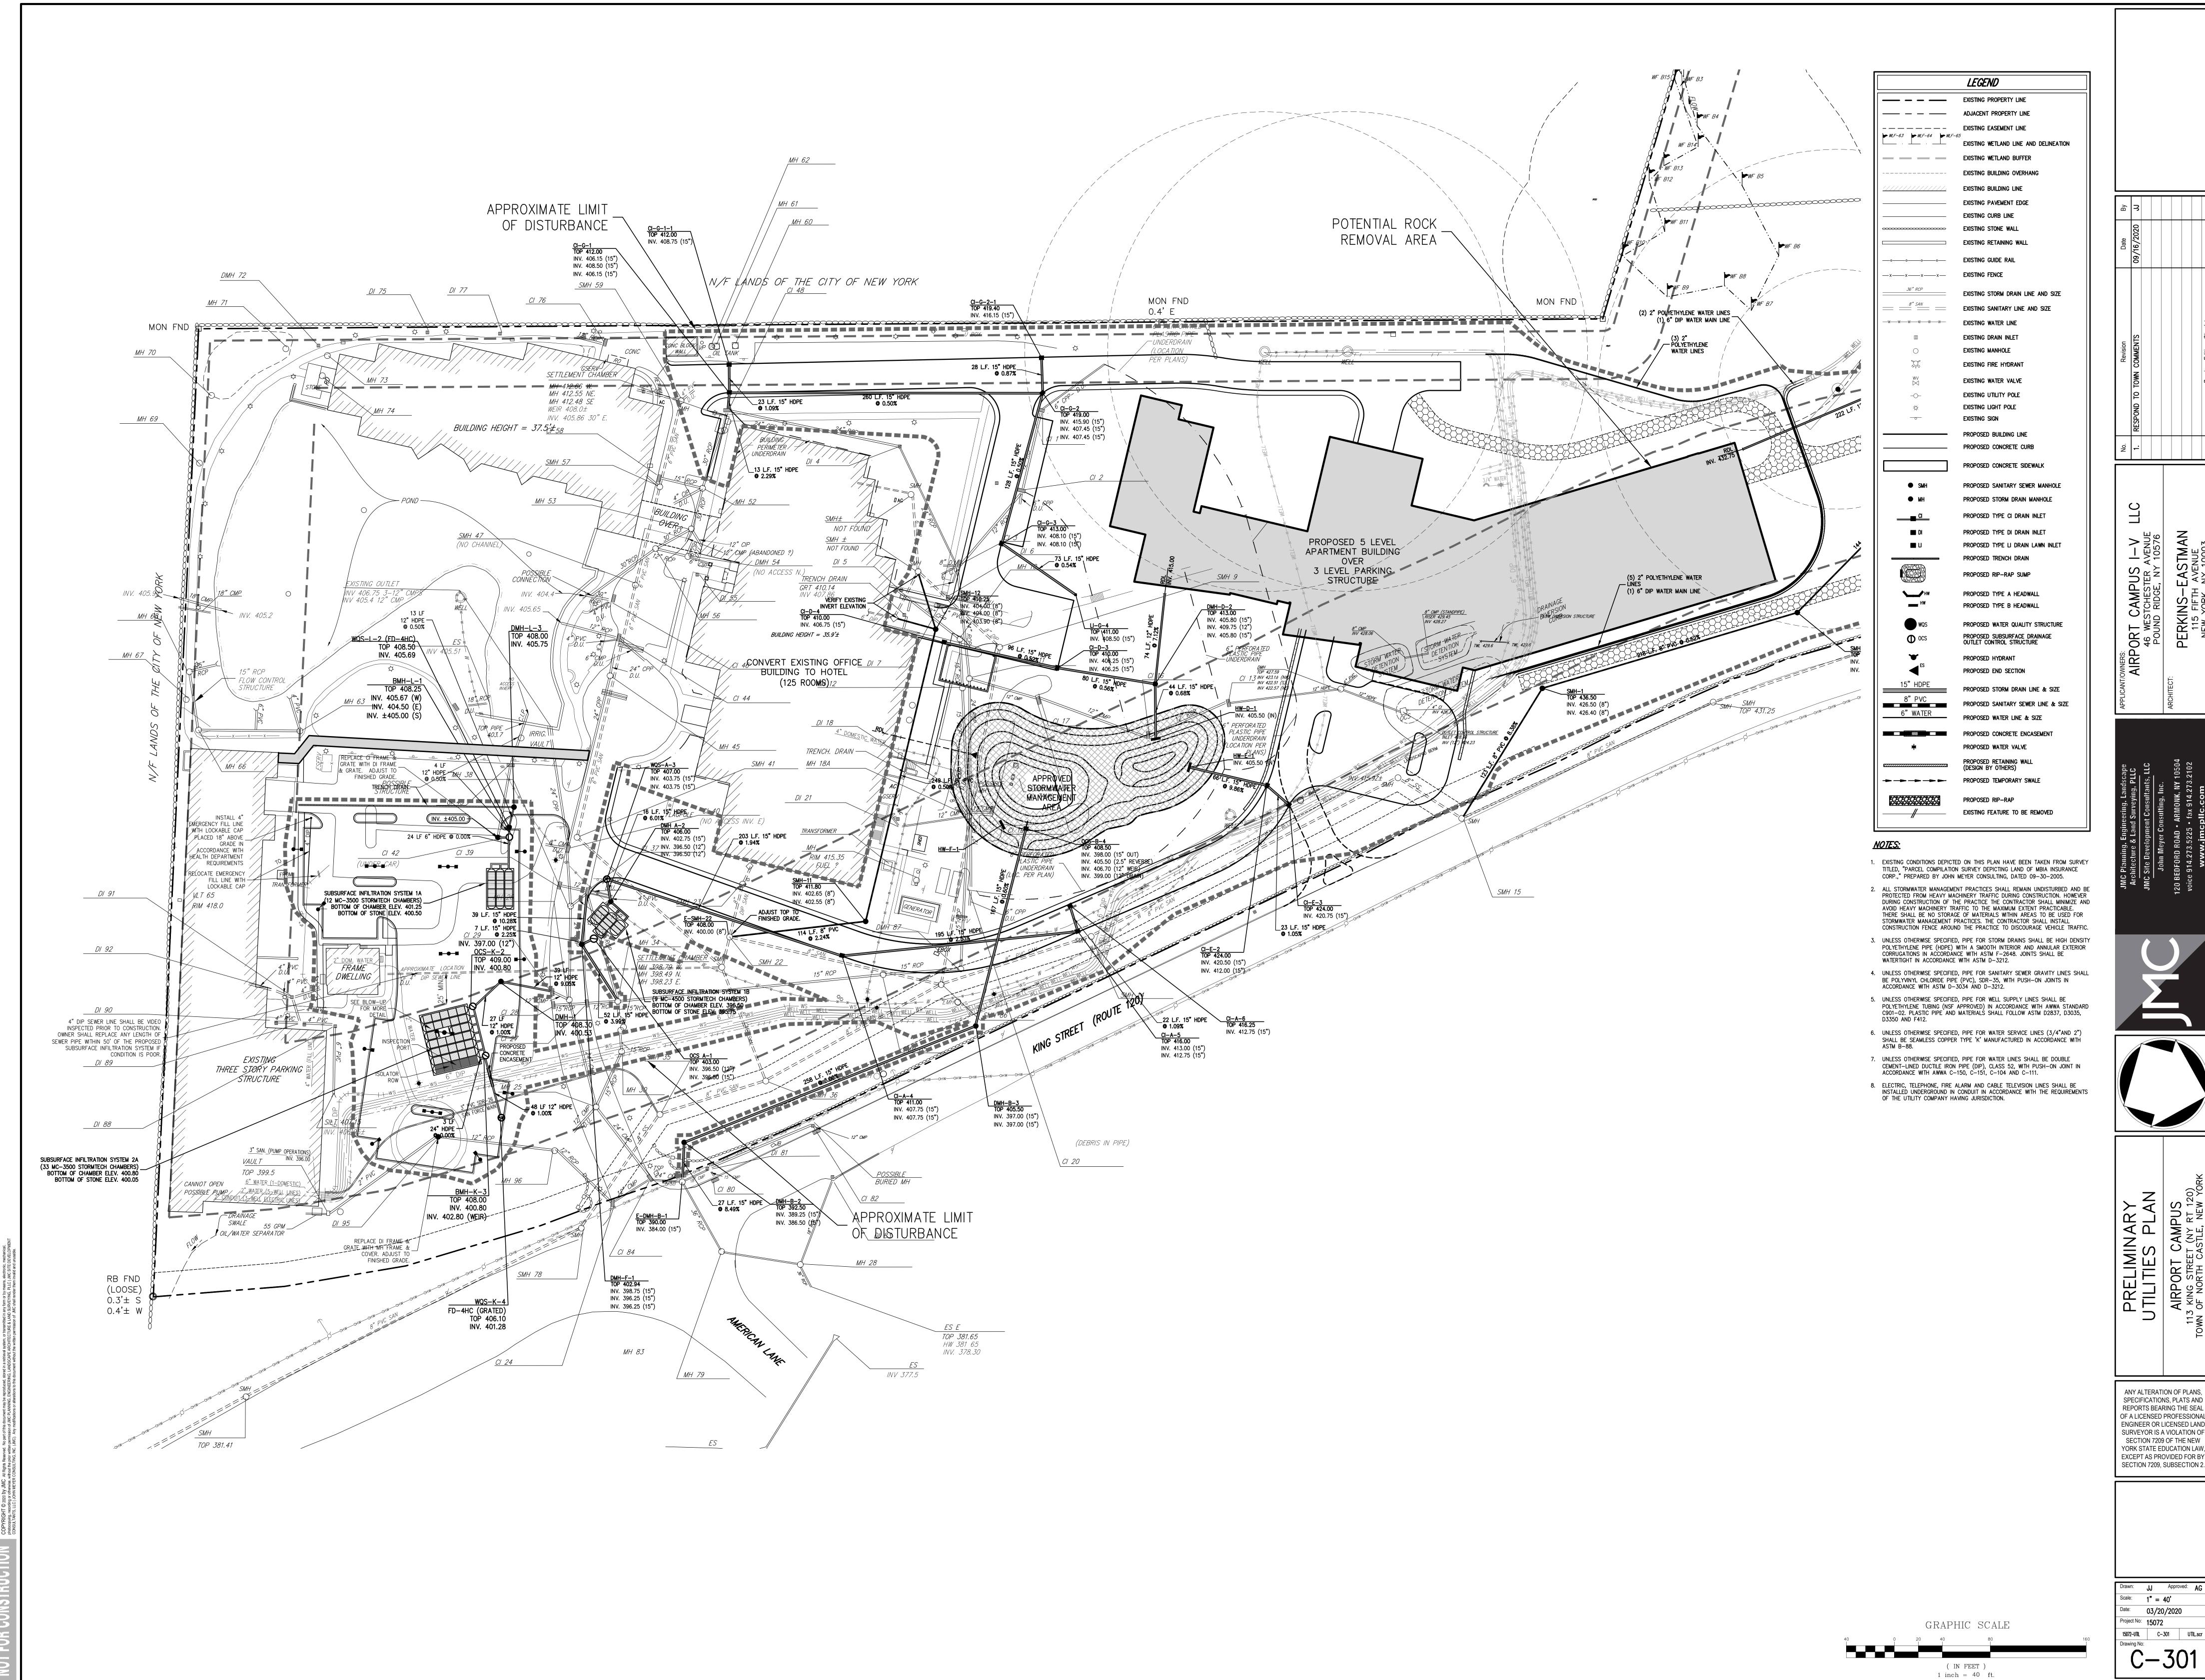
C - 301



Drawn: JJ Approved: AG Scale: 1" = 40' 03/20/2020 Project No: 15072 15072-UTIL | C-302 | UTIL.scr

C - 302

1 inch = 40 ft.

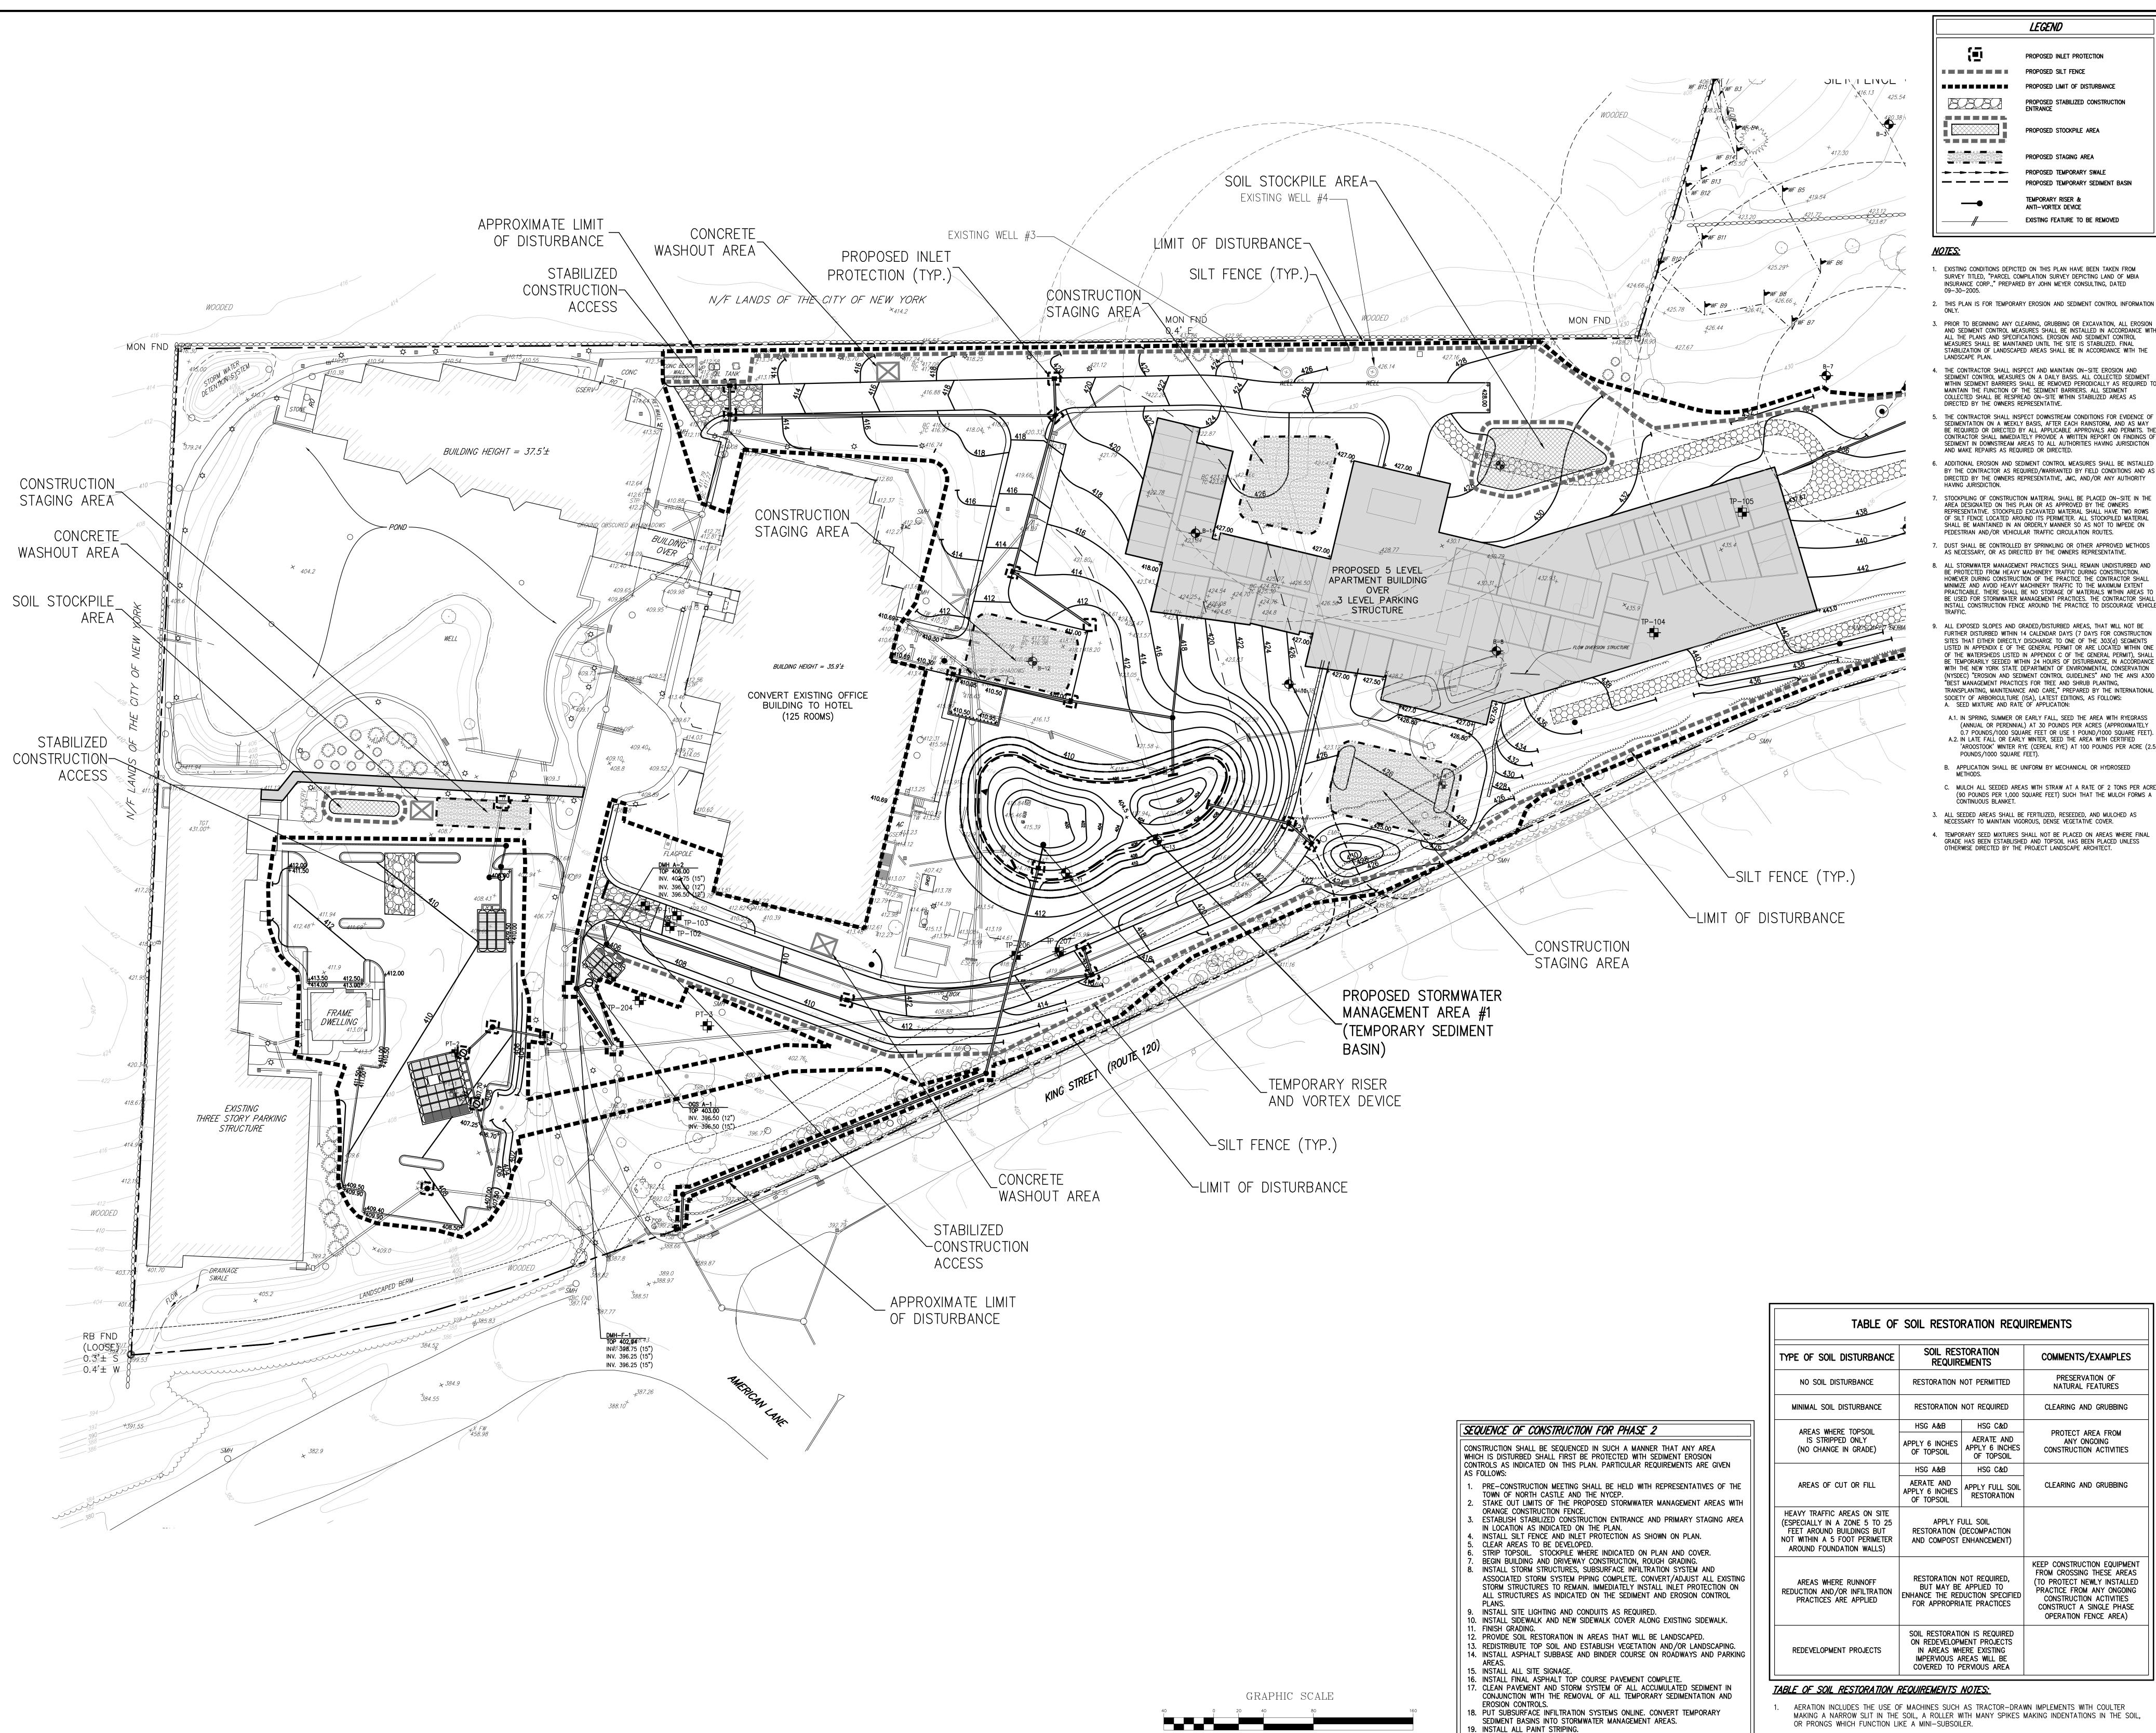

(IN FEET)

1 inch = 40 ft.

PROPOSED INLET PROTECTION PROPOSED LIMIT OF DISTURBANCE PROPOSED STABILIZED CONSTRUCTION ENTRANCE PROPOSED STOCKPILE AREA PROPOSED STAGING AREA PROPOSED TEMPORARY SWALE PROPOSED TEMPORARY SEDIMENT BASIN

- EXISTING CONDITIONS DEPICTED ON THIS PLAN HAVE BEEN TAKEN FROM SURVEY TITLED, "PARCEL COMPILATION SURVEY DEPICTING LAND OF MBIA
- 2. THIS PLAN IS FOR TEMPORARY EROSION AND SEDIMENT CONTROL INFORMATION
- 3. PRIOR TO BEGINNING ANY CLEARING, GRUBBING OR EXCAVATION, ALL EROSION AND SEDIMENT CONTROL MEASURES SHALL BE INSTALLED IN ACCORDANCE WITH ALL THE PLANS AND SPECIFICATIONS. EROSION AND SEDIMENT CONTROL MEASURES SHALL BE MAINTAINED UNTIL THE SITE IS STABILIZED. FINAL
- . THE CONTRACTOR SHALL INSPECT AND MAINTAIN ON-SITE EROSION AND SEDIMENT CONTROL MEASURES ON A DAILY BASIS. ALL COLLECTED SEDIMENT WITHIN SEDIMENT BARRIERS SHALL BE REMOVED PERIODICALLY AS REQUIRED TO MAINTAIN THE FUNCTION OF THE SEDIMENT BARRIERS. ALL SEDIMENT
- THE CONTRACTOR SHALL INSPECT DOWNSTREAM CONDITIONS FOR EVIDENCE OF SEDIMENTATION ON A WEEKLY BASIS, AFTER EACH RAINSTORM, AND AS MAY BE REQUIRED OR DIRECTED BY ALL APPLICABLE APPROVALS AND PERMITS. THE CONTRACTOR SHALL IMMEDIATELY PROVIDE A WRITTEN REPORT ON FINDINGS OF SEDIMENT IN DOWNSTREAM AREAS TO ALL AUTHORITIES HAVING JURISDICTION
- ADDITIONAL EROSION AND SEDIMENT CONTROL MEASURES SHALL BE INSTALLED BY THE CONTRACTOR AS REQUIRED/WARRANTED BY FIELD CONDITIONS AND AS
- STOCKPILING OF CONSTRUCTION MATERIAL SHALL BE PLACED ON-SITE IN THE AREA DESIGNATED ON THIS PLAN OR AS APPROVED BY THE OWNERS REPRESENTATIVE. STOCKPILED EXCAVATED MATERIAL SHALL HAVE TWO ROWS OF SILT FENCE LOCATED AROUND ITS PERIMETER. ALL STOCKPILED MATERIAL SHALL BE MAINTAINED IN AN ORDERLY MANNER SO AS NOT TO IMPEDE ON
- PEDESTRIAN AND/OR VEHICULAR TRAFFIC CIRCULATION ROUTES. DUST SHALL BE CONTROLLED BY SPRINKLING OR OTHER APPROVED METHODS AS NECESSARY, OR AS DIRECTED BY THE OWNERS REPRESENTATIVE. ALL STORMWATER MANAGEMENT PRACTICES SHALL REMAIN UNDISTURBED AND
- BE PROTECTED FROM HEAVY MACHINERY TRAFFIC DURING CONSTRUCTION. HOWEVER DURING CONSTRUCTION OF THE PRACTICE THE CONTRACTOR SHALL MINIMIZE AND AVOID HEAVY MACHINERY TRAFFIC TO THE MAXIMUM EXTENT PRACTICABLE. THERE SHALL BE NO STORAGE OF MATERIALS WITHIN AREAS TO BE USED FOR STORMWATER MANAGEMENT PRACTICES. THE CONTRACTOR SHALL INSTALL CONSTRUCTION FENCE AROUND THE PRACTICE TO DISCOURAGE VEHICLE ALL EXPOSED SLOPES AND GRADED/DISTURBED AREAS, THAT WILL NOT BE
- SITES THAT EITHER DIRECTLY DISCHARGE TO ONE OF THE 303(d) SEGMENTS LISTED IN APPENDIX E OF THE GENERAL PERMIT OR ARE LOCATÉD WITHIN ONE OF THE WATERSHEDS LISTED IN APPENDIX C OF THE GENERAL PERMIT), SHALL BE TEMPORARILY SEEDED WITHIN 24 HOURS OF DISTURBANCE, IN ACCORDANCE WITH THE NEW YORK STATE DEPARTMENT OF ENVIRONMENTAL CONSERVATION (NYSDEC) "EROSION AND SEDIMENT CONTROL GUIDELINES" AND THE ANSI A300 BEST MANAGEMENT PRACTICES FOR TREE AND SHRUB PLANTING. TRANSPLANTING, MAINTENANCE AND CARE," PREPARED BY THE INTERNATIONAL SOCIETY OF ARBORICULTURE (ISA), LATEST EDITIONS, AS FOLLOWS:
 A. SEED MIXTURE AND RATE OF APPLICATION:
- 'AROOSTOOK' WINTER RYE (CEREAL RYE) AT 100 POUNDS PER ACRE (2.5
- C. MULCH ALL SEEDED AREAS WITH STRAW AT A RATE OF 2 TONS PER ACRE
- (90 POUNDS PER 1,000 SQUARE FEET) SUCH THAT THE MULCH FORMS A

4. TEMPORARY SEED MIXTURES SHALL NOT BE PLACED ON AREAS WHERE FINAL GRADE HAS BEEN ESTABLISHED AND TOPSOIL HAS BEEN PLACED UNLESS OTHERWISE DIRECTED BY THE PROJECT LANDSCAPE ARCHITECT.

ELIMINAF

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EXCEPT AS PROVIDED FOR BY SECTION 7209, SUBSECTION 2.

Drawn: JJ Approved: AG Scale: 1" = 40' 12/24/2019 Project No: 15072 15072-S&E C-401 UTIL.scr

C - 401

PER "DEEP RIPPING AND DE-COMPACTION, NYSDEC 2008."



PROPOSED INLET PROTECTION PROPOSED SILT FENCE PROPOSED LIMIT OF DISTURBANCE PROPOSED STABILIZED CONSTRUCTION ENTRANCE ______ PROPOSED STOCKPILE AREA _____ PROPOSED TEMPORARY SWALE ____ PROPOSED TEMPORARY SEDIMENT BASIN ANTI-VORTEX DEVICE EXISTING FEATURE TO BE REMOVED

LANDSCAPE PLAN.

HAVING JURISDICTION.

- 1. EXISTING CONDITIONS DEPICTED ON THIS PLAN HAVE BEEN TAKEN FROM SURVEY TITLED, "PARCEL COMPILATION SURVEY DEPICTING LAND OF MBIA INSURANCE CORP.," PREPARED BY JOHN MEYER CONSULTING, DATED
- 2. THIS PLAN IS FOR TEMPORARY EROSION AND SEDIMENT CONTROL INFORMATION
- 3. PRIOR TO BEGINNING ANY CLEARING, GRUBBING OR EXCAVATION, ALL EROSION AND SEDIMENT CONTROL MEASURES SHALL BE INSTALLED IN ACCORDANCE WITH ALL THE PLANS AND SPECIFICATIONS. EROSION AND SEDIMENT CONTROL MEASURES SHALL BE MAINTAINED UNTIL THE SITE IS STABILIZED. FINAL STABILIZATION OF LANDSCAPED AREAS SHALL BE IN ACCORDANCE WITH THE
- 4. THE CONTRACTOR SHALL INSPECT AND MAINTAIN ON-SITE EROSION AND SEDIMENT CONTROL MEASURES ON A DAILY BASIS. ALL COLLECTED SEDIMENT WITHIN SEDIMENT BARRIERS SHALL BE REMOVED PERIODICALLY AS REQUIRED TO MAINTAIN THE FUNCTION OF THE SEDIMENT BARRIERS. ALL SEDIMENT COLLECTED SHALL BE RESPREAD ON—SITE WITHIN STABILIZED AREAS AS DIRECTED BY THE OWNERS REPRESENTATIVE.
- 5. THE CONTRACTOR SHALL INSPECT DOWNSTREAM CONDITIONS FOR EVIDENCE OF SEDIMENTATION ON A WEEKLY BASIS, AFTER EACH RAINSTORM, AND AS MAY BE REQUIRED OR DIRECTED BY ALL APPLICABLE APPROVALS AND PERMITS. THE CONTRACTOR SHALL IMMEDIATELY PROVIDE A WRITTEN REPORT ON FINDINGS OF SEDIMENT IN DOWNSTREAM AREAS TO ALL AUTHORITIES HAVING JURISDICTION
- AND MAKE REPAIRS AS REQUIRED OR DIRECTED. 6. ADDITIONAL EROSION AND SEDIMENT CONTROL MEASURES SHALL BE INSTALLED BY THE CONTRACTOR AS REQUIRED/WARRANTED BY FIELD CONDITIONS AND AS DIRECTED BY THE OWNERS REPRESENTATIVE, JMC, AND/OR ANY AUTHORITY
- 7. STOCKPILING OF CONSTRUCTION MATERIAL SHALL BE PLACED ON-SITE IN THE AREA DESIGNATED ON THIS PLAN OR AS APPROVED BY THE OWNERS REPRESENTATIVE. STOCKPILED EXCAVATED MATERIAL SHALL HAVE TWO ROWS OF SILT FENCE LOCATED AROUND ITS PERIMETER. ALL STOCKPILED MATERIAL SHALL BE MAINTAINED IN AN ORDERLY MANNER SO AS NOT TO IMPEDE ON
- PEDESTRIAN AND/OR VEHICULAR TRAFFIC CIRCULATION ROUTES. 7. DUST SHALL BE CONTROLLED BY SPRINKLING OR OTHER APPROVED METHODS AS NECESSARY, OR AS DIRECTED BY THE OWNERS REPRESENTATIVE.
- 8. ALL STORMWATER MANAGEMENT PRACTICES SHALL REMAIN UNDISTURBED AND BE PROTECTED FROM HEAVY MACHINERY TRAFFIC DURING CONSTRUCTION. HOWEVER DURING CONSTRUCTION OF THE PRACTICE THE CONTRACTOR SHALL MINIMIZE AND AVOID HEAVY MACHINERY TRAFFIC TO THE MAXIMUM EXTENT PRACTICABLE. THERE SHALL BE NO STORAGE OF MATERIALS WITHIN AREAS TO BE USED FOR STORMWATER MANAGEMENT PRACTICES. THE CONTRACTOR SHALL INSTALL CONSTRUCTION FENCE AROUND THE PRACTICE TO DISCOURAGE VEHICLE
- 9. ALL EXPOSED SLOPES AND GRADED/DISTURBED AREAS, THAT WILL NOT BE FURTHER DISTURBED WITHIN 14 CALENDAR DAYS (7 DAYS FOR CONSTRUCTION SITES THAT EITHER DIRECTLY DISCHARGE TO ONE OF THE 303(d) SEGMENTS LISTED IN APPENDIX E OF THE GENERAL PERMIT OR ARE LOCATED WITHIN ONE OF THE WATERSHEDS LISTED IN APPENDIX C OF THE GENERAL PERMIT), SHALL BE TEMPORARILY SEEDED WITHIN 24 HOURS OF DISTURBANCE, IN ACCORDANCE WITH THE NEW YORK STATE DEPARTMENT OF ENVIRONMENTAL CONSERVATION (NYSDEC) "EROSION AND SEDIMENT CONTROL GUIDELINES" AND THE ANSI A300 BEST MANAGEMENT PRACTICES FOR TREE AND SHRUB PLANTING, TRANSPLANTING, MAINTENANCE AND CARE," PREPARED BY THE INTERNATIONAL SOCIETY OF ARBORICULTURE (ISA), LATEST EDITIONS, AS FOLLOWS:
 A. SEED MIXTURE AND RATE OF APPLICATION:
- A.1. IN SPRING, SUMMER OR EARLY FALL, SEED THE AREA WITH RYEGRASS (ANNUAL OR PERENNIAL) AT 30 POUNDS PER ACRES (APPROXIMATELY 0.7 POUNDS/1000 SQUARE FEET OR USE 1 POUND/1000 SQUARE FEET). A.2. IN LATE FALL OR EARLY WINTER, SEED THE AREA WITH CERTIFIED 'AROOSTOOK' WINTER RYE (CEREAL RYE) AT 100 POUNDS PER ACRE (2.5 POUNDS/1000 SQUARE FEET).
- B. APPLICATION SHALL BE UNIFORM BY MECHANICAL OR HYDROSEED C. MULCH ALL SEEDED AREAS WITH STRAW AT A RATE OF 2 TONS PER ACRE
- (90 POUNDS PER 1,000 SQUARE FEET) SUCH THAT THE MULCH FORMS A CONTINUOUS BLANKET.
- 3. ALL SEEDED AREAS SHALL BE FERTILIZED, RESEEDED, AND MULCHED AS
- NECESSARY TO MAINTAIN VIGOROUS, DENSE VEGETATIVE COVER. 4. TEMPORARY SEED MIXTURES SHALL NOT BE PLACED ON AREAS WHERE FINAL GRADE HAS BEEN ESTABLISHED AND TOPSOIL HAS BEEN PLACED UNLESS OTHERWISE DIRECTED BY THE PROJECT LANDSCAPE ARCHITECT.

GRAPHIC SCALE

1 inch = 40 ft.

COMMENTS/EXAMPLES

PRESERVATION OF

NATURAL FEATURES

CLEARING AND GRUBBING

PROTECT AREA FROM

CONSTRUCTION ACTIVITIES

CLEARING AND GRUBBING

KEEP CONSTRUCTION EQUIPMENT

FROM CROSSING THESE AREAS

(TO PROTECT NEWLY INSTALLED

PRACTICE FROM ANY ONGOING

CONSTRUCTION ACTIVITIES

OPERATION FENCE AREA)

CONSTRUCT A SINGLE PHASE

ANY ONGOING

SOIL RESTORATION

REQUIREMENTS

RESTORATION NOT PERMITTED

RESTORATION NOT REQUIRED

APPLY 6 INCHES APPLY 6 INCHES

APPLY 6 INCHES RESTORATION

APPLY FULL SOIL

RESTORATION (DECOMPACTION

AND COMPOST ENHANCEMENT)

RESTORATION NOT REQUIRED,

BUT MAY BE APPLIED TO

ENHANCE THE REDUCTION SPECIFIED

FOR APPROPRIATE PRACTICES

SOIL RESTORATION IS REQUIRED

ON REDEVELOPMENT PROJECTS

IMPERVIOUS AREAS WILL BE COVERED TO PERVIOUS AREA

IN AREAS WHERE EXISTING

OF TOPSOIL

HSG A&B


AERATE AND

OF TOPSOIL

HSG C&D

OF TOPSOIL

HSG C&D

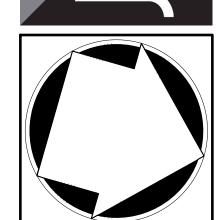

EDIMENT (

ANY ALTERATION OF PLANS, SPECIFICATIONS, PLATS AND REPORTS BEARING THE SEAL OF A LICENSED PROFESSIONAL ENGINEER OR LICENSED LAND

SURVEYOR IS A VIOLATION OF SECTION 7209 OF THE NEW YORK STATE EDUCATION LAW, EXCEPT AS PROVIDED FOR BY SECTION 7209, SUBSECTION 2.

Drawn: JJ Approved: AG Scale: 1" = 40'

03/20/2020 Project No: 15072 15072-S&E C-402 S&E.scr C - 402


SEDIMENT BASINS INTO STORMWATER MANAGEMENT AREAS.

19. INSTALL ALL PAINT STRIPING.

AERATION INCLUDES THE USE OF MACHINES SUCH AS TRACTOR-DRAWN IMPLEMENTS WITH COULTER MAKING A NARROW SLIT IN THE SOIL, A ROLLER WITH MANY SPIKES MAKING INDENTATIONS IN THE SOIL, OR PRONGS WHICH FUNCTION LIKE A MINI-SUBSOILER.

PER "DEEP RIPPING AND DE-COMPACTION, NYSDEC 2008."



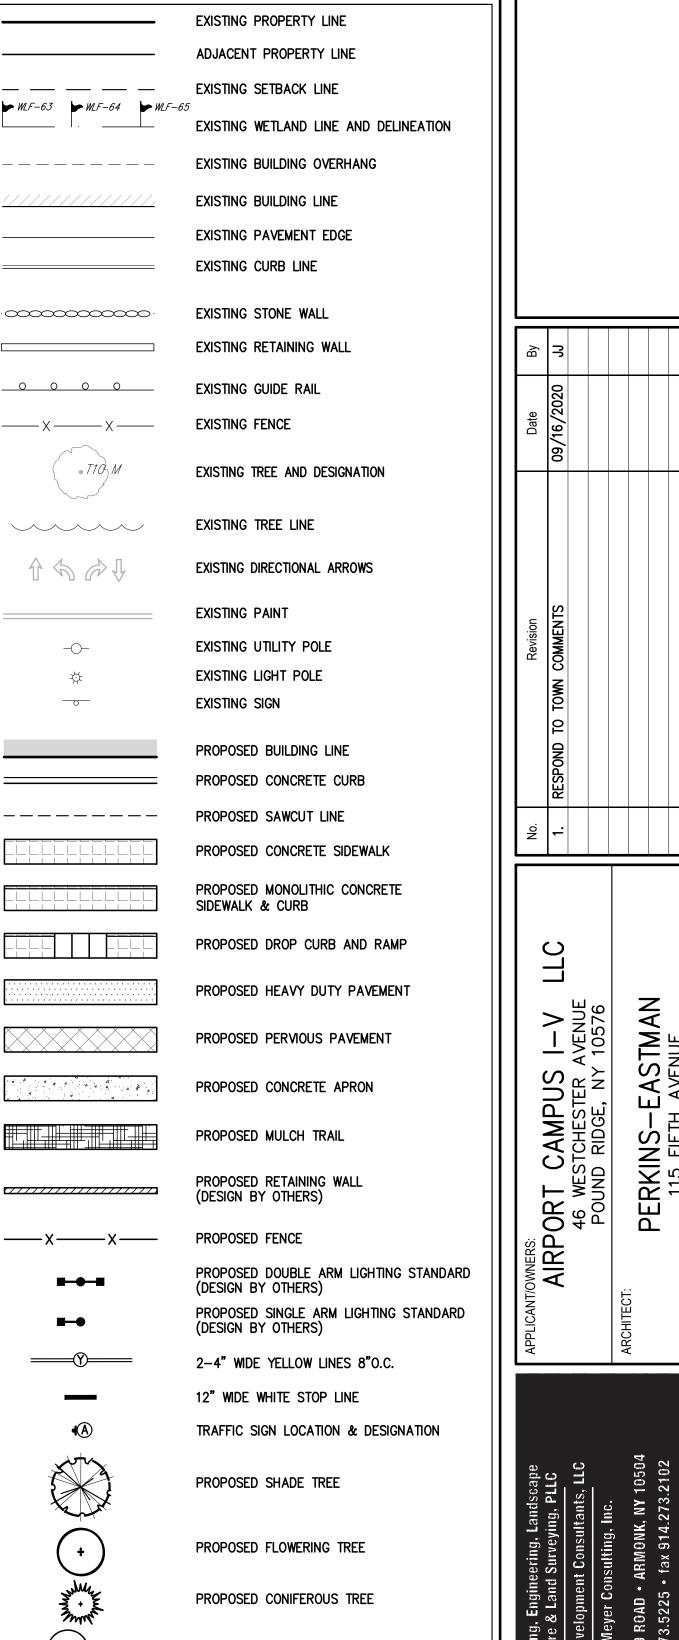

- 1. ALL PLANT MATERIAL SHALL BE FIRST QUALITY STOCK. PLANTED MATERIAL AND METHODS OF INSTALLATION SHALL CONFORM TO THE AMERICAN NURSERY AND LANDSCAPE ASSOCIATION, AMERICAN STANDARD FOR NURSERY STOCK,
- 2. ALL AREAS OF THE SITE NOT OCCUPIED BY BUILDING OR PAVEMENT AND NOT SPECIFIED AS BEING PLANTED WITH TREES, SHRUBS OR GROUND COVER SHALL

PROPOSED SHRUBS

PROPOSED SHRUB MASSING

EXISTING FEATURE TO BE REMOVED

- ALL PLANTING BEDS SHALL BE MULCHED WITH 3" OF BROWN MULCH. MULCH SHALL BE CLEAN, NON-DYED, TOXIC FREE, SHREDDED HARDWOOD.
- 4. PLANT MATERIALS AS SPECIFIED ON THE DRAWINGS AND DELIVERED TO THE SITE SHALL BE NURSERY GROWN AND CERTIFIED TRUE TO THEIR GENUS, SPECIES AND VARIETY. SUBSTITUTIONS ARE NOT PERMITTED WITHOUT THE PROJECT LANDSCAPE ARCHITECTS WRITTEN APPROVAL.
- 5. ALL LANDSCAPING SHALL CONTINUE TO BE MAINTAINED IN A HEALTHY GROWING CONDITION THROUGHOUT THE DURATION OF THE PROJECT. ANY PLANTING NOT SO MAINTAINED SHALL BE REPLACED WITH NEW PLANTS AT THE
- BEGINNING OF THE NEXT, IMMEDIATELY FOLLOWING, GROWING SEASON. 6. ALL TREES AND SHRUBS SHALL BE PRUNED AND SHAPED AND BE SUBJECT TO THE APPROVAL OF THE PROJECT LANDSCAPE ARCHITECT AND GOVERNMENTAL AUTHORITIES HAVING JURISDICTION.
- 7. PLANTING STOCK SHALL BE WELL-BRANCHED AND WELL-FORMED, SOUND, VIGOROUS, HEALTHY, FREE FROM DISEASE, SUN-SCALE, WINDBURN, ABRASION, AND HARMFUL INSECTS OR INSECTS EGGS; AND SHALL HAVE HEALTHY, NORMAL UNBROKEN ROOT SYSTEMS. DECIDUOUS TREES AND SHRUBS SHALL BE SYMMETRICALLY DEVELOPED, OF UNIFORM HABIT OF GROWTH, WITH STRAIGHT TRUNKS OR STEMS, AND FREE FROM OBJECTIONABLE DISFIGUREMENTS. EVERGREEN TREES AND SHRUBS SHALL HAVE WELL-DEVELOPED SYMMETRICAL TOPS WITH TYPICAL SPREAD OF BRANCHES FOR EACH PARTICULAR SPECIES OR VARIETY. ONLY VINES AND GROUND COVER PLANTS WELL ESTABLISHED IN REMOVAL CONTAINERS, INTEGRAL CONTAINERS, OR FORMED HOMOGENEOUS SOIL SECTIONS SHALL BE USED. PLANTS SHALL BE GROWN UNDER CLIMATIC CONDITIONS SIMILAR TO THOSE IN THE LOCALITY OF THE PROJECT.
- 8. ALL STOCK SHALL BE BALLED AND BURLAPPED OR CONTAINER GROWN STOCK, UNLESS OTHERWISE SPECIFIED. BAREROOT STOCK OF ANY KIND IS UNACCEPTABLE UNLESS SPECIFIED.
- 9. ALL PLANTING BEDS, LAWNS AND LANDSCAPED AREAS SHALL RECEIVE A MINIMUM 4" THICK LAYER OF TOPSOIL, UNLESS OTHERWISE SPECIFIED.

PRELIMINARY NDSCAPE PLAN	AIRPORT CAMPUS KING STREET (NY RT 120) OF NORTH CASTLE, NEW YORK
	AIRPOR 3 KING STE 1 OF NORTH

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Scale: 1" = 40' Date: 03/20/2020 Project No: 15072 15072-LAND | L-101 | LAND.scr

GRAPHIC SCALE

(IN FEET) 1 inch = 40 ft. L-101



(IN FEET)
1 inch = 40 ft.