

121A Montgomery Ave Scarsdale, NY 10583

914-713-4693 Phone 914-703-2378 Cell

March 3, 2020

To: Members of the planning board of the Town of North Castle, Adam Kaufman, Town Planner and Robert Melillo, Building Inspector.

RE: Work to be performed at 4 Ledgewood Rd, Armonk NY

To rebuild existing house in accordance with the plans submitted by Ken Okamoto, dated March 2, 2020.

Remove any and all debris where necessary. Remove any existing roof, siding, windows including but not limited to sheathing.

Reframe house as indicated. Install new windows, siding roofing and build new porch as designed and shown in elevations submitted.

Rewire all necessary electrical where necessary. All new rough plumbing where necessary. Install new HVAC system.

All new insulation according to R values as indicated in plans.

Sheetrock and finishes including new bathrooms, kitchen, staircase, flooring, doors and trim TBD by owner.

Removal of all stumps in disturbed areas as indicated in the site plan.

4 Ledgewood Place LLC



April 28, 2020

Adam Kaufman, AICP Director of Planning Town of North Castle

Re: Renovation/Alterations 4 Ledgewood Place Armonk, NY 10504 Tax ID: 107.02-2-46

### RPRC DETERMINATION LETTER 7/3/2019 RESPONSE RPRC DETERMINATION LETTER 11/6/2019 RESPONSE STAFF REPORT-TOWN OF NORTH CASTLE 3/20/2020 RESPONSE

Dear Mr. Kaufman:

Following is a point by point response to comments on the project made via the above listed memos. The comments from the RPRC Determination Letter, dated July 3, 2019 and Nov. 6, 2019 have been copied into this letter. Responses follow each RPRC comment in blue for clarity:

From the RPRC Determination Letter Dated 7/3/2019

- 1. The depicted expansion of the accessory structure requires approval by the Planning Board and a variance from the ZBA. The plans shall be revised to remove any modification of the accessory structure to the satisfaction of the Building Department. Modification to the accessory structure have been removed from the plans.
- The existing home is currently abandoned. It is recommended that a landscaping plan be submitted for review. In addition, the Applicant should clarify if any site improvements are proposed (patios, regrading, etc). If so, those improvements should be depicted on the site plan.

See Landscape Plan submitted by Yost Design (under separate cover).

- The submitted gross floor area and gross land coverage calculations worksheets shall be revised to remove GLC and GFA associated with garage modifications which are no longer part of the proposed action. A revised gross land coverage calculation worksheet has been submitted.
- The Building Department shall determine whether GLC and GFA backup data would be required to be submitted for review.
   GLC & GFA Backup is attached. See Drawing Z-100

- 5. The Town-wetland consultant shall confirm the wetland delineation on the property. The proposed porch requires the issuance of an administrative wetlands permit. Civil Engineer has submitted the application and drawings for a Wetland Permit.
- 6. The submitted site plan shall depict the location of the existing well and septic system. The site plan has been revised to include the location of the existing septic system.
- 7. The Building Department should give consideration to requiring Health Department review of the adequacy of the existing septic system. The Building Department has reviewed the submission and has determined that the project will be referred to the health department.
- 8. The submitted Gross Land Coverage Calculations Worksheet indicates 912 square feet of gross land coverage for driveway being proposed; however, the submitted site plan does not depict any proposed driveway expansions. The Applicant should provide additional information. A revised gross land coverage calculation worksheet has been submitted.
- 9. The plans shall include a north arrow. North arrows have been added to plans.
- 10. The plan shall include a Bulk Zoning Compliance Table. A Bulk Zoning Compliance Table has been added to the title page.
- 11. The Building Department shall determine the need to refer the application to the Westchester County Department of Health (WCHD) for review of the proposed bedroom count and/or additional floor area and whether modifications or upgrades to the existing septic system are required. Same as point 7.
- 12. The plan shall illustrate and quantify the limits of disturbance. The plan shall note that disturbance limits shall be staked in the field prior to construction. The site plan has been revised to show the limits of disturbance. The site plan has been revised to illustrate and quantify the limits of disturbance. Note re: field staking has been added to the site plan S-1.0.
- 13. Include erosion control measures on the plan, including, but not limited to, temporary construction access, silt fence, inlet protection, tree protection, erosion control blankets, construction sequence, etc. Provide details. Erosion control measures have been added to the plans.
- 14. It appears that disturbances are proposed within the locally-regulated 100-foot wetland buffer. A local Wetland Permit may be required. The applicant shall illustrate the local wetland boundary and regulated 100-foot buffer on the plan for verification by the Town Wetland Consultant. Notify this office once the wetland boundary has been established in the field so that a determination regarding the need for a Wetland Permit can be made. Wetland application and drawings has been submitted. 100 ft buffers are shown on the site plan S-1.0.
- 15. The Wetland Mitigation Plan shall illustrate and quantifying the proposed disturbance areas to the wetland and/or wetland buffer. The plan shall include a summary table that quantifies the total wetland and wetland buffer area on site, total disturbance areas within each, and total pervious and impervious cover pre and post development.

Mitigation shall be provided at a ratio of 2:1 minimum. UES has provided updated information on revised drawing to show table and limit of disturbances.

- 16. An Existing Conditions Plans should be submitted to help clarify the comparison between existing and proposed improvements. Existing conditions plans have been added to the drawing set.
- 17. The plans note design alternatives throughout. The alternatives shall be removed and a final set of drawings should be submitted for review. Design alternatives have been removed from the drawing set.
- 18. The applicant shall perform deep and percolation soil testing in the vicinity of the proposed mitigation system to be witnessed by the Town Engineer. The test locations and results shall be shown on the plan. Contact this office to schedule the testing. Testing was completed on November 26, 2019 with the Town Consulting Engineer and shown on drawings already.
- 19. Provide stormwater mitigation and design calculations for the runoff generated by the net increase in impervious surface for the 25-year, 24-hour design storm event. Provide details of the stormwater mitigation system. Storm water mitigation and design calculations and details have been added to the drawing set.

As per RPRC Determination Letter November 6, 2019 the following have been addressed:

- 1. Limit of Disturbance shall be expanded to include tree removal. Revised drawing shows updated Limit of disturbance of tree removal.
- 2. The plan proposed disturbances within the locally-regulated 100-foot wetland buffer. A local Wetland Permit is required. The applicant shall illustrate the local wetland boundary and regulated 100-foot buffer on the plan for verification by the Town Wetland Consultant. Notify this office once the wetland boundary has been established in the field so that a determination regarding the need for a Wetland Permit can be made. Wetland application and drawings has been submitted.100 ft buffers have been shown on drawings. We show note on drawings to stake out in field prior to construction.
- 3. All previous comments issued in the July 3, 2019 RPRC Determination Letter shall be addressed prior to final approval. Please see comments above and Revised drawings.
- 4. The Applicant should submit a restoration/Landscape plan for review. See Landscape Plan submitted by Yost Design (under separate cover).
- 5. The Applicant should submit a tree survey showing trees designated for removal, other trees within 50 ft of trees proposed for removal and the location of trees removed within the past 12 months. The survey should indicate size, species and any special condition of the tree. Where other activities are proposed in conjunction with this application, all tress within and adjacent (50 feet) to the proposed work should be shown. Revised site plan shows tree removal list.
- 6. A detailed statement of the proposed action includes a description of the trees proposed to be removed, an explanation of why the trees must be removed, an evaluation of

alternatives for relocating improvements in an effort to reduce tree removal and an explanation of the relationship of the tree removal to neighboring properties. Submitted under separate cover.

### Per Staff Report-dated 3/20/2020


Item #5- Gross Land Cover Worksheet and Backup information is attached. See Drawing Z-100


Item #6- Gross Floor Area Calculation Worksheet and Back up Data is attached. See Drawing Z-100

Item #7- Building Height Exhibit is attached. See Drawing Z-101

Item #8- Maximum Exterior Wall Height Exhibit is attached. See Drawing Z-101

Item #9- Same as point 7 on the RPRC determination letter.

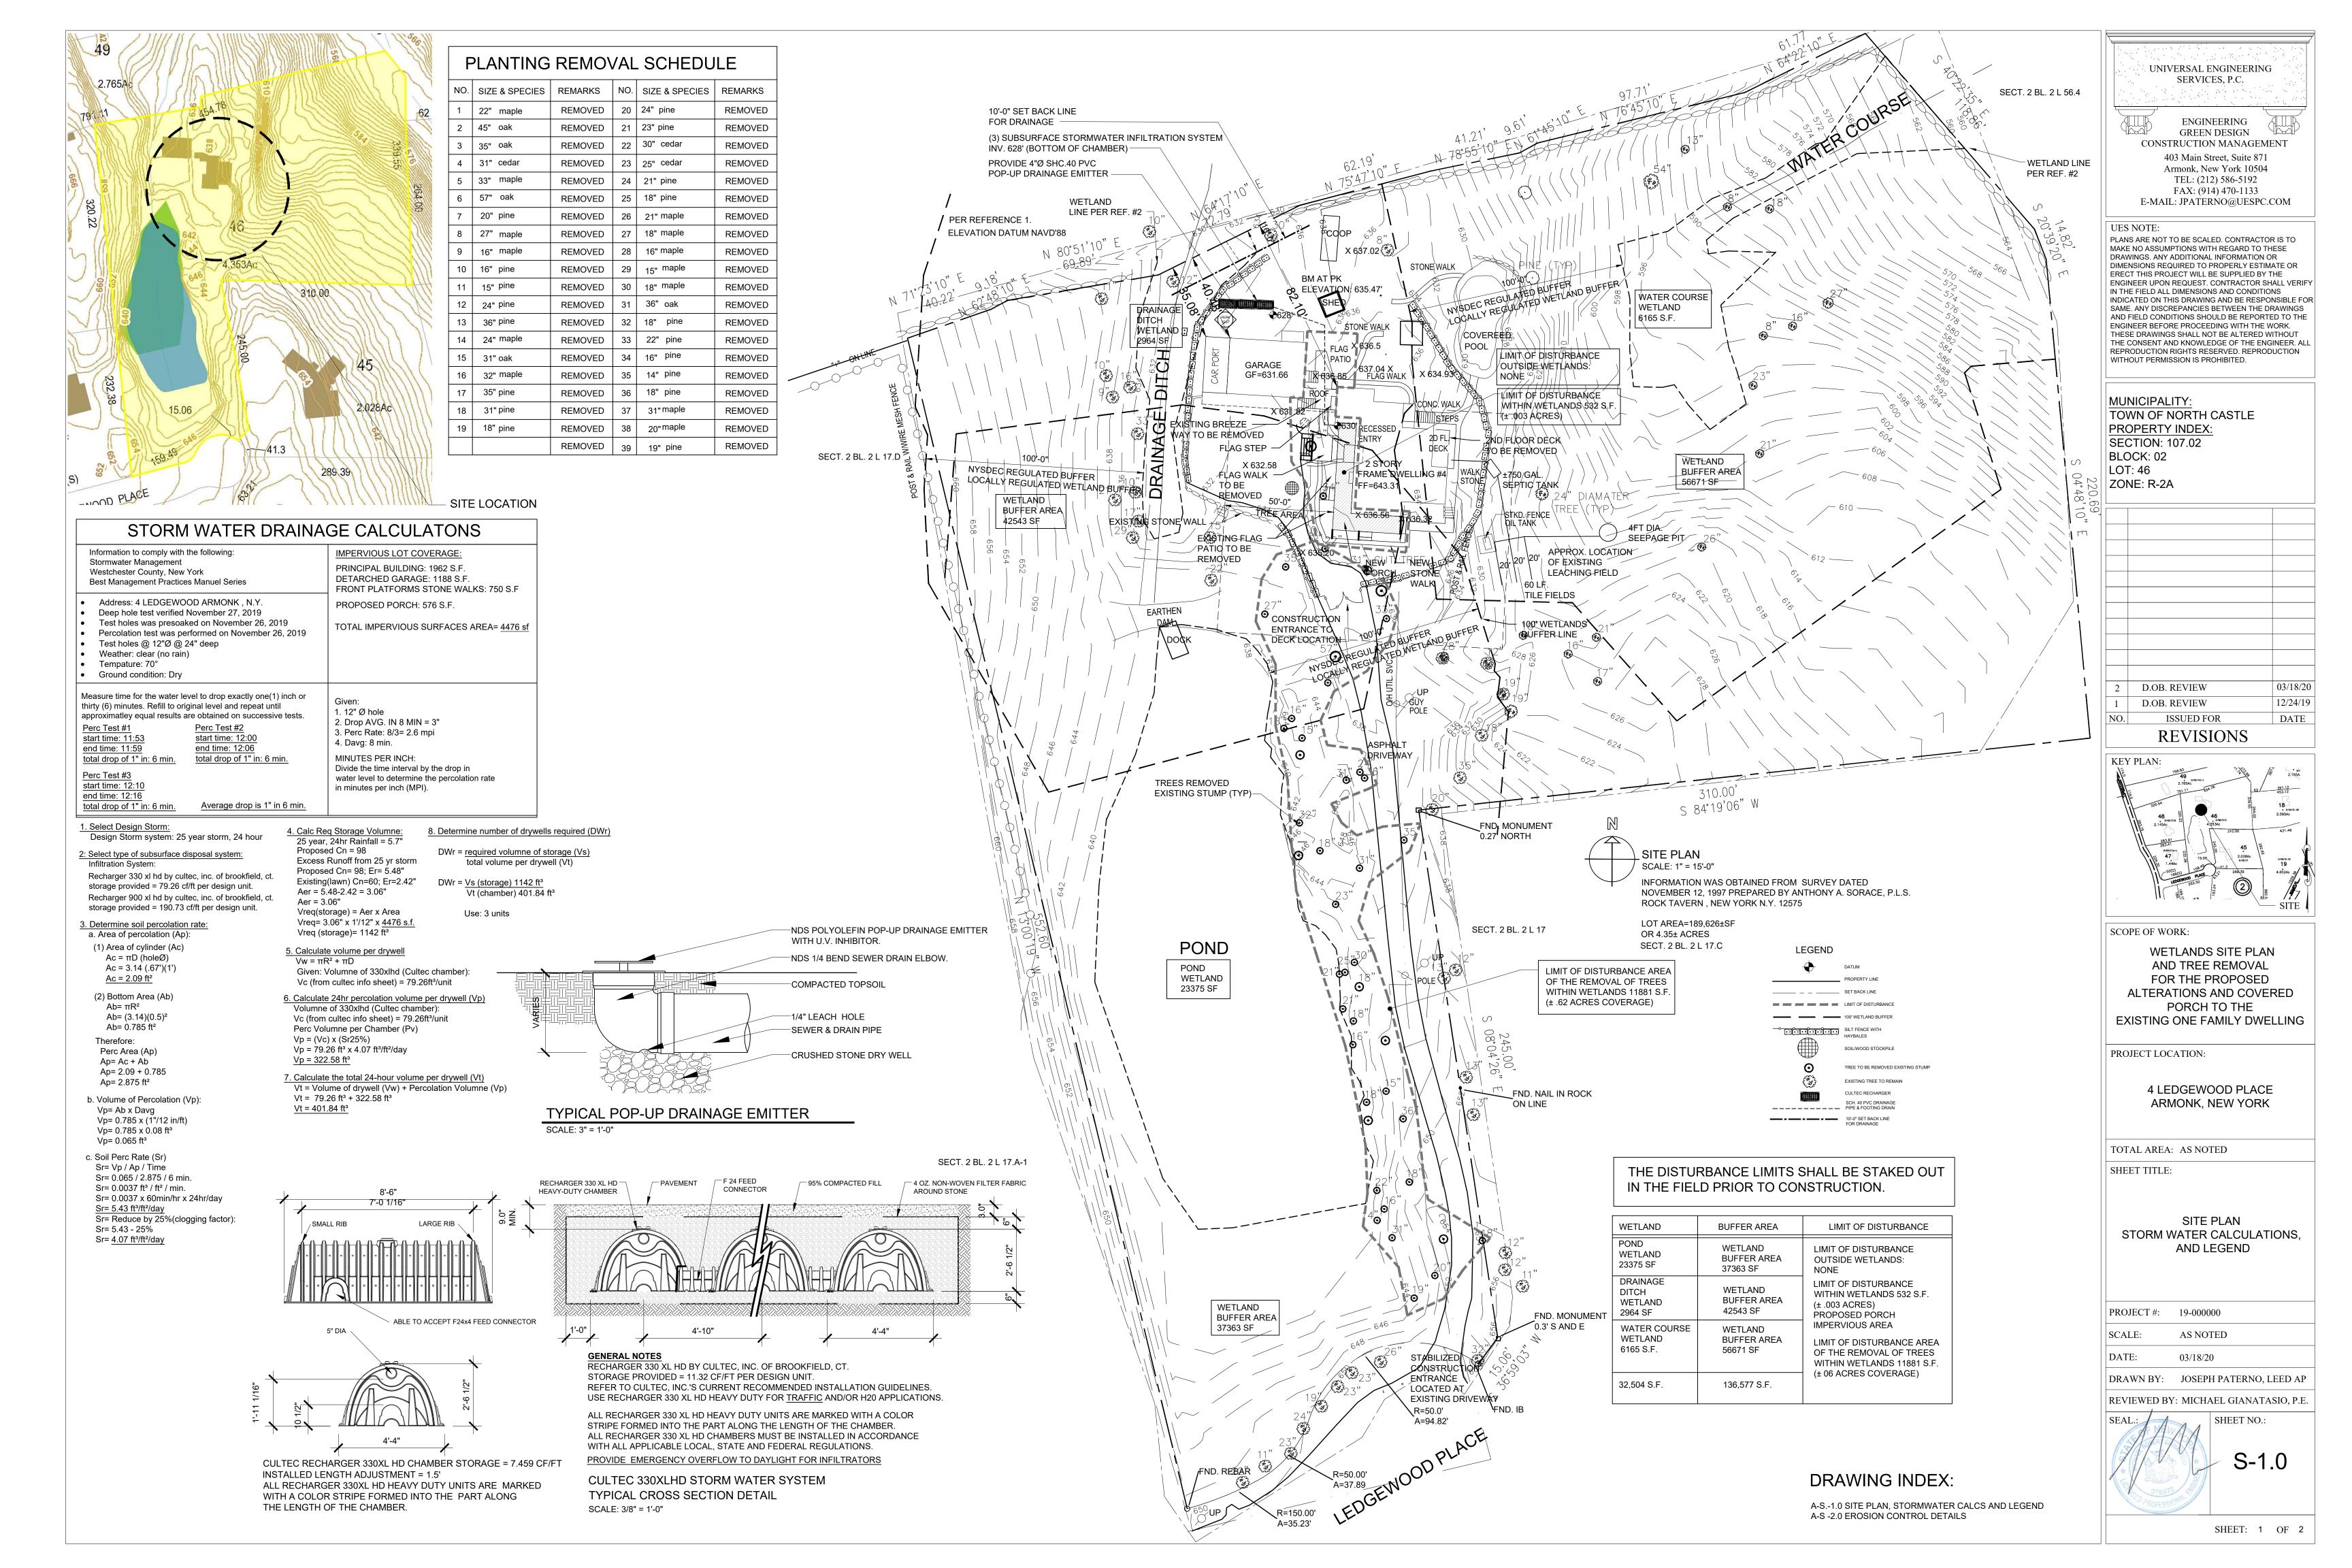

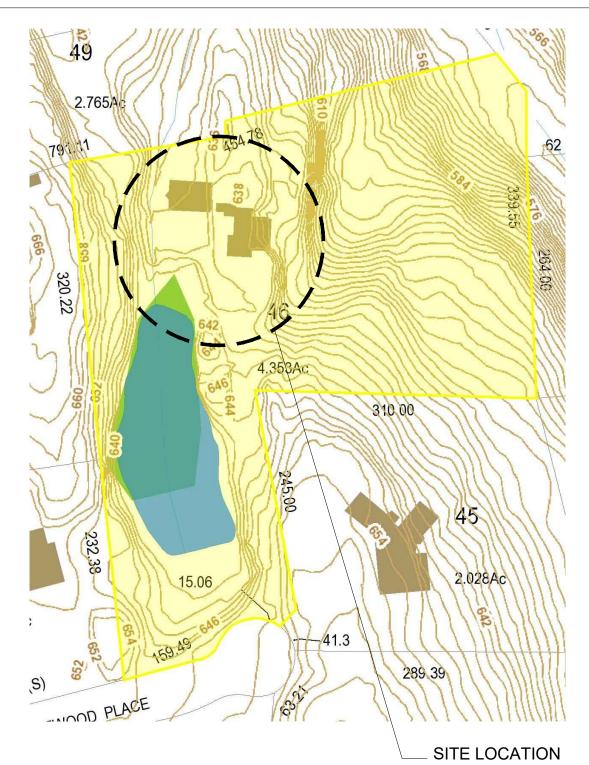

# EROSION AND SEDIMENT CONTROL INSPECTIONS:

1) AN INITIAL INSPECTION PRIOR TO THE PLAN APPROVAL 2) AN EROSION AND SEDIMENT CONTROL INPSECTION TO ENSURE THAT EROSION AND SEDIMENT CONTROL PRACTICES ARE IN ACCORD WITH THE APPROVED PLAN.

3) AN INSPECTION PRIOR TO BACKFILLING ANY UNDERGROUND DRAINAGE OR STORMWATER CONVEYANCE STRUCTURES. 4) A FINAL INSPECTION WHEN ALL WORK, INCLUDING CONSTRUCTION OF STORMWATER

MANAGEMENT FACILITIES AND PERMANENT SOIL STABILIZATION, HAS BEEN COMPLETED.

CONSTRUCTION INSPECTION SCHEDULE:

1) PRE INSPECTION OF THE LAND AREA TO BE AFFECTIVE

2) INSPECTION OF THE HAYBALES, SILT FENCE AND ETC.

3) FOOTING INSPECTION

4) STOCKPILE INSPECTION 5) FINAL GRADE & VEGETATION INSPECTION

SPECIFICATIONS:

# CONDITIONS:

1. ALL WORK MUST BE PERFORMED IN ACCORDANCE W/ THE TOWN OF NORTH CASTLE BUILDING CODE, & THE NEW YORK STATE UFPBC AND ALL OTHER APPLICABLE ORDINANCES,

REGULATIONS, AND STANDARDS REQUIRED 2. ALL MANUFACTURED ITEMS SHALL BE INSTALLED OR APPLIED AS DIRECTED BY THE MANUFACTURERS RECOMMENDATIONS.

3. CONTRACTOR TO INCLUDE ALL MATERIALS, LABOR, INCIDENTALS AND SERVICES FOR SATISFACTORYS COMPLETION OF THE WORK.

4. CONTRACTOR SHALL VERIFY ALL EXISTING CONDITIONS IN THE FIELD AND SHALL NOTIFY THE ARCHITECT OF ANY DISCREPANCIES BEFORE STARTING THE WORK.

5. CONTRACTOR SHALL PERFORM ALL WORK REQUIRED FOR THE TOTAL COMPLETION OF THE PROJECT, WHETHER OR NOT INDICATED ON THE DRAWINGS. THE INTENTION OF THE DRAWINGS IS FOR A COMPLETE AND PROPER FUNCTIONING OF THE ENTIRE PROJECT.

### INSURANCE:

1. CONTRACTOR, AND HIS SUBCONTRACTORS, SHALL MAINTAIN WORKMEN'S CONPENSATION INSURANCE AS WELL AS ADEQUATE LIABILITY INSURANCE DURING THE ENTIRE LENGTH OF THE JOB. 2. OWNER SHALL PROVIDE ADEQUATE PROPERTY INSURANCE ON VALUE OF THE CONSTRUCTION, INCLUDING FIRE & VANDALISM.

## PERMITS & SURVEYS

1. CONTRACTOR SHALL FURNISH ALL PERMITS, LICENSES AND APPROVALS NECESSARY TO

COMPLETE THE WORK. 2. BUILDING SHALL BE STAKED OUT BY A LICENSED SURVEYOR WHO SHALL FILE A FINAL SURVEY AT THE COMPLETION OF WORK.

3. CONTRACTOR SHALL PROVIDE TEH OWNER WITH A CERTIFICATE OF OCCUPANCY UPON COMPLETION OF WORK.

## SITE MAINTENANCE:

1. JOB SITE TO BE KEPT CLEAN AT ALL TIMES, TRASH TO BE REMOVED FROM THE SITE WEEKLY OR STORED IN APPROVED DUMPSTER UNTIL FULL THAN THAN CARTED AWAY FROM THE SITE. 2. CARE SHALL BE TAKEN TO PROTECT THE TREES ON THE PROPERTY FROM THE METHODS AND MANNERS OF CONSTRUCTION. TRAFFICKING AND STORAGE OF MATERIALS. RETURN THOSE AREAS DAMAGED BY SUCH TO THEIR ORIGINAL CONDITION.

## EXCAVATION:

1. STOCKPILE ALL EXCAVATED SOIL FOR FUTURE REUSE AS FILL MATERIAL OR REMOVE AND DISPOSE OF AS REQUIRED.

## **EROSION CONTROL NOTES:**

1. CONTRACTOR SHALL BE RESPONSIBLE FOR COMPLIANCE WITH ALL SEDIMENT AND EROSION CONTROL PRACTICES. THE SEDIMENT AND EROSION CONTROL PRACTICES ARE TO BE INSTALLED PRIOR TO ANY MAJOR SOIL DISTURBANCES, AND MAINTAINED UNTIL PERMANENT PROTECTION IS ESTABLISHED.

2. TIMELY MAINTENANCE OF SEDIMENT CONTROL STRUCTURES IS THE RESPONSIBILITY OF THE CONTRACTOR. ALL STRUCTURES SHALL BE MAINTAINED IN GOOD WORKING ORDER AT ALL TIMES. THE SEDIMENT LEVEL IN ALL SEDIMENT TRAPS SHALL BE CLOSELY MONITORED AND SEDIMENT REMOVED PROMPTLY WHEN MAXIMUM LEVELS ARE REACHED OR AS ORDERED BY THE ENGINEER. ALL SEDIMENT CONTROL STRUCTURES SHALL BE INSPECTED ON A REGULAR BASIS, AND AFTER EACH HEAVY RAIN TO INSURE PROPER OPERATION AS DESIGNED. AN INSPECTION SCHEDULE SHALL BE SET FORTH PRIOR TO THE START OF CONSTRUCTION.

3. THE LOCATIONS AND THE INSTALLATION TIMES OF THE SEDIMENT CAPTURING STANDARDS SHALL BE AS ORDERED BY THE ENGINEER, AND IN ACCORDANCE WITH THE STANDARDS SET FORTH IN THIS MANUAL.

4. ALL TOPSOIL NOT TO BE USED FOR FINAL GRADING SHALL REMOVED FROM THE SITE IMMEDIATELY AND PLACED IN A STABILIZED STOCKPILE OR FILL AREA. ALL TOPSOIL REQUIRED FOR FINAL GRADING AND STORED ON SITE SHALL BE LIMED, FERTILIZED, TEMPORARILY SEEDED AND MULCHED WITH 14 DAYS.

5. ANY DISTURBED AREAS THAT WILL BE LEFT EXPOSED MORE THAN 21 DAYS AND NOT SUBJECT TO CONSTRUCTION TRAFFIC, SHALL IMMEDIATELY RECEIVE TEMPORARY SEEDING. MULCH SHALL BE USED IF THE SEASON PREVENTS THE ESTABLISHMENT OF A TEMPORARY


6. ALL DISTURBED AREAS WITHIN 500 FEET OF AN INHABITED DWELLING SHALL BE WETTED AS NECESSARY TO PROVIDE DUST CONTROL.


7. THE CONTRACTOR SHALL KEEP THE ROADWAYS WITHIN THE PROJECT CLEAR OF SOIL AND DEBRIS AND IS RESPONSIBLE FOR ANY STREET CLEANING NECESSARY DURING THE COURSE OF THE PROJECT.

8. SEDIMENT AND EROSION CONTROL STRUCTURES SHALL BE REMOVED AND THE AREA STABILIZED WHEN THE DRAINAGE AREA HAS BEEN PROPERLY STABILIZED BY PERMANENT MEASURES.


9. ALL SEDIMENT AND EROSION CONTROL MEASURES SHALL BE INSTALLED IN ACCORDANCE WITH CURRENT EDITION OF "WESTCHESTER COUNTY BEST MANAGEMENT PRACTICES MANUAL FOR EROSION AND SEDIMENT CONTROL".

10. ALL DESIGNATED TREES SHALL BE PROTECTED DURING THE CONSTRUCTION PERIOD, EXCEPT THOS DESIGNATED TO BE REMOVED. TREE PROTECTION SHALL BE IN ACCORDANCE WITH THE WESTCHESTER COUNTY BEST MANAGEMENT PRACTICES MANUAL

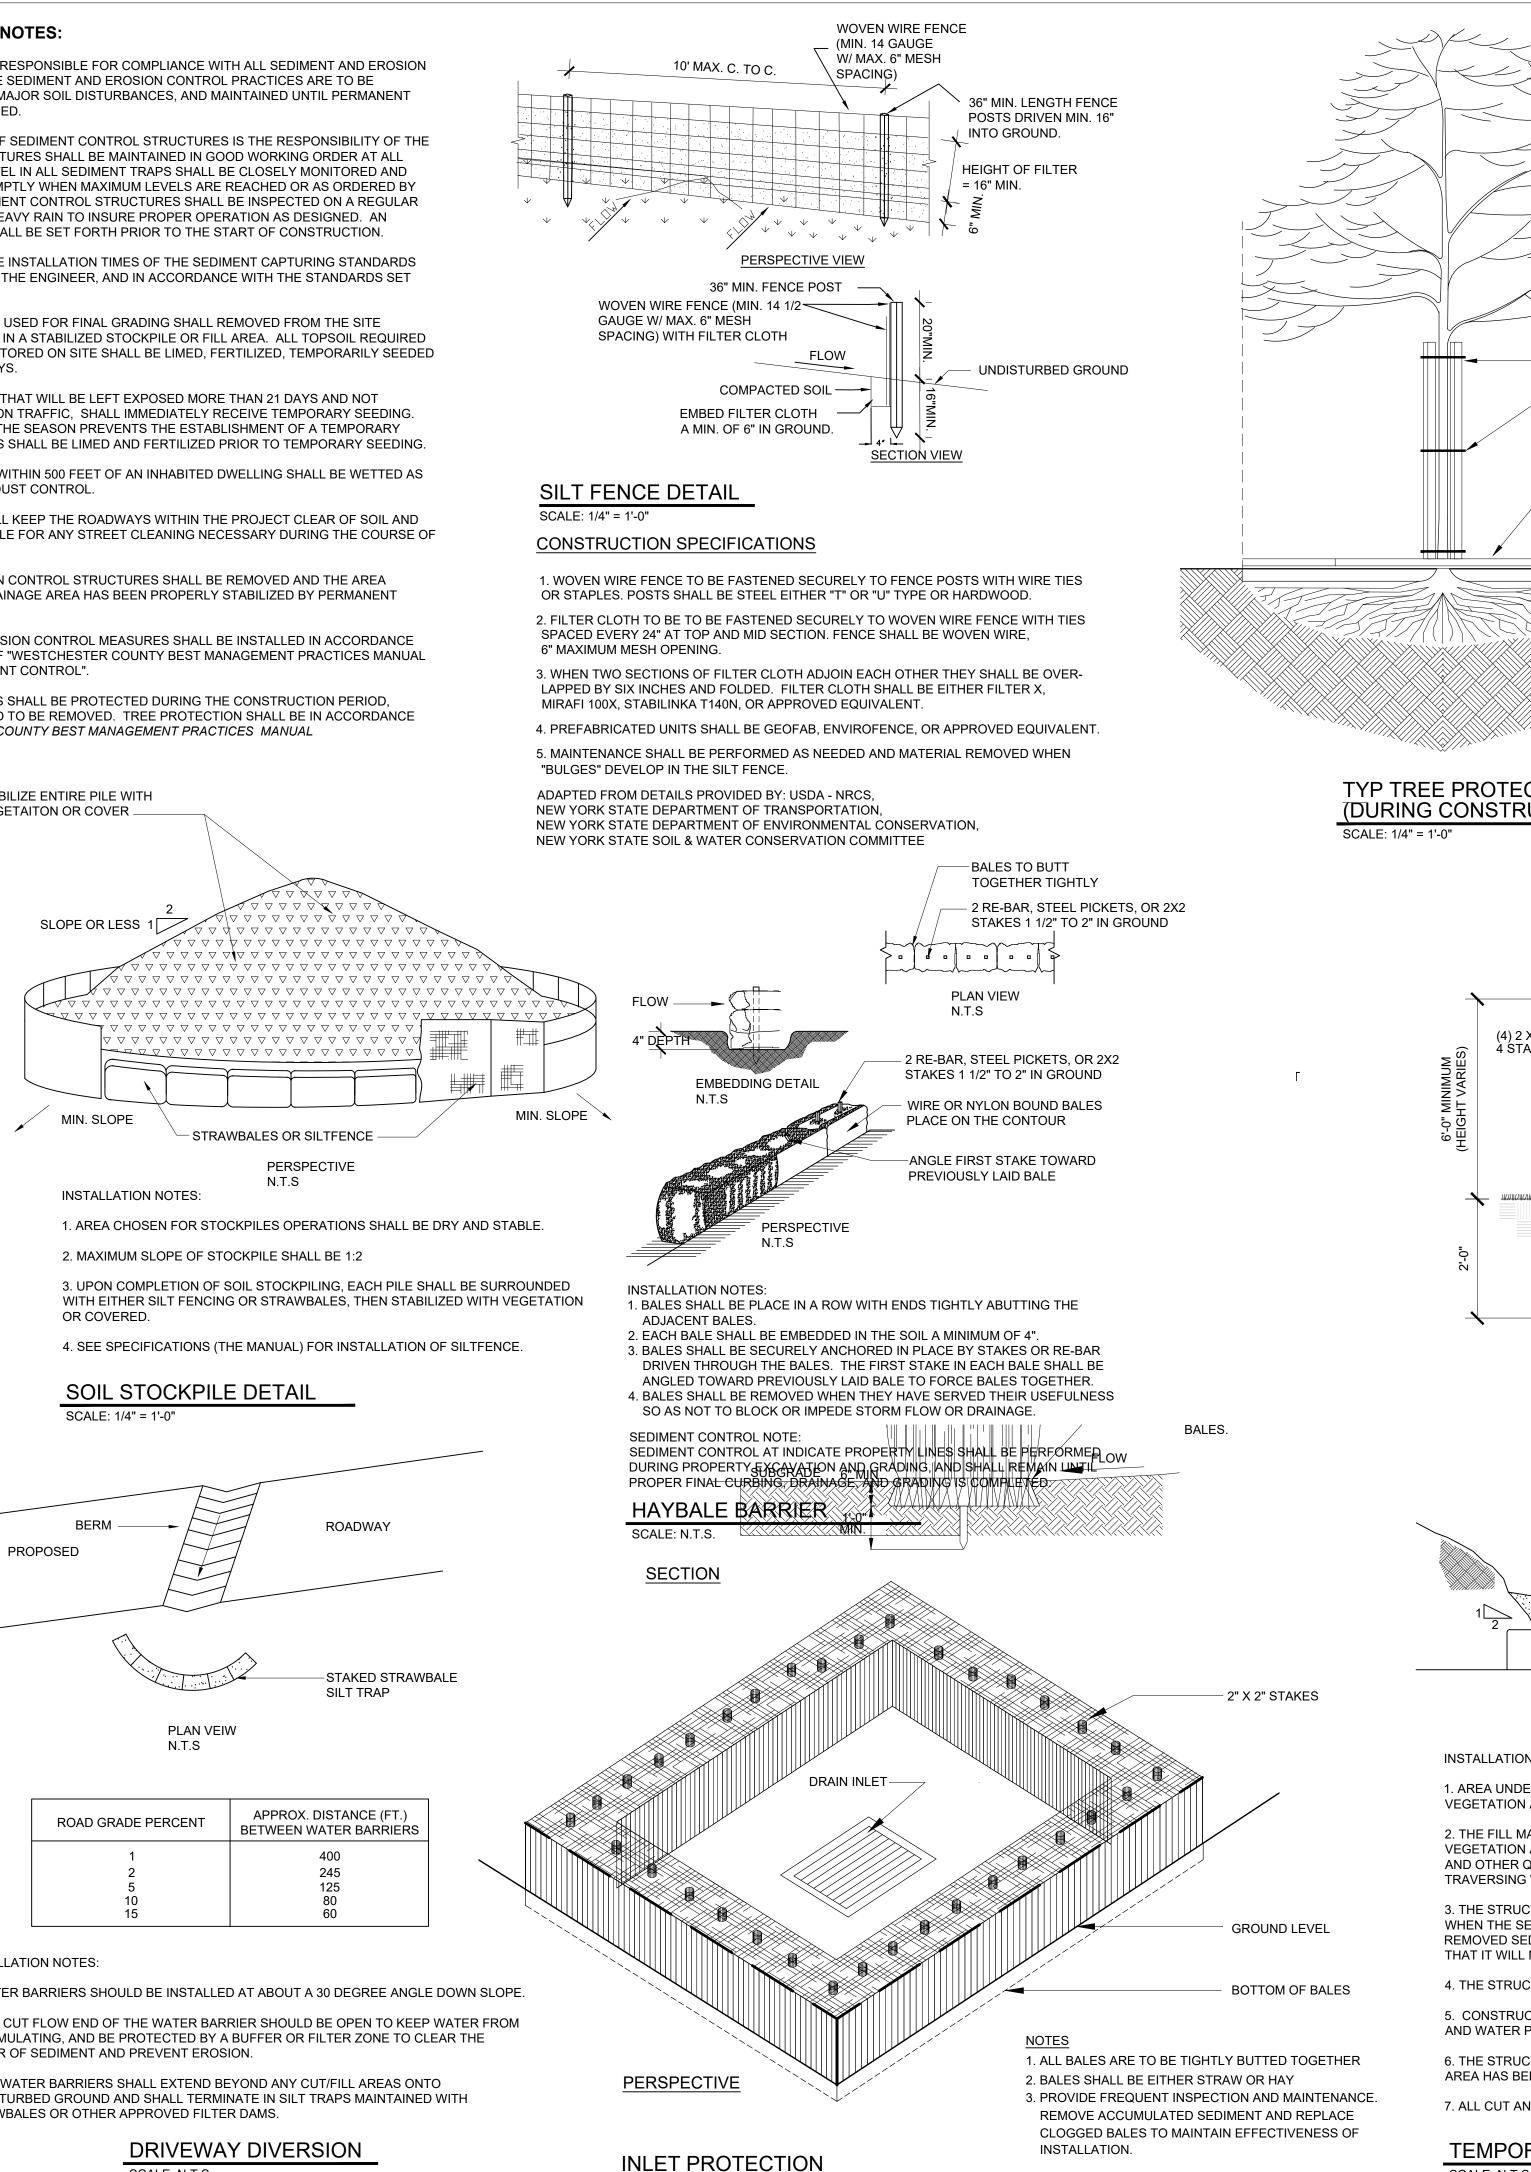

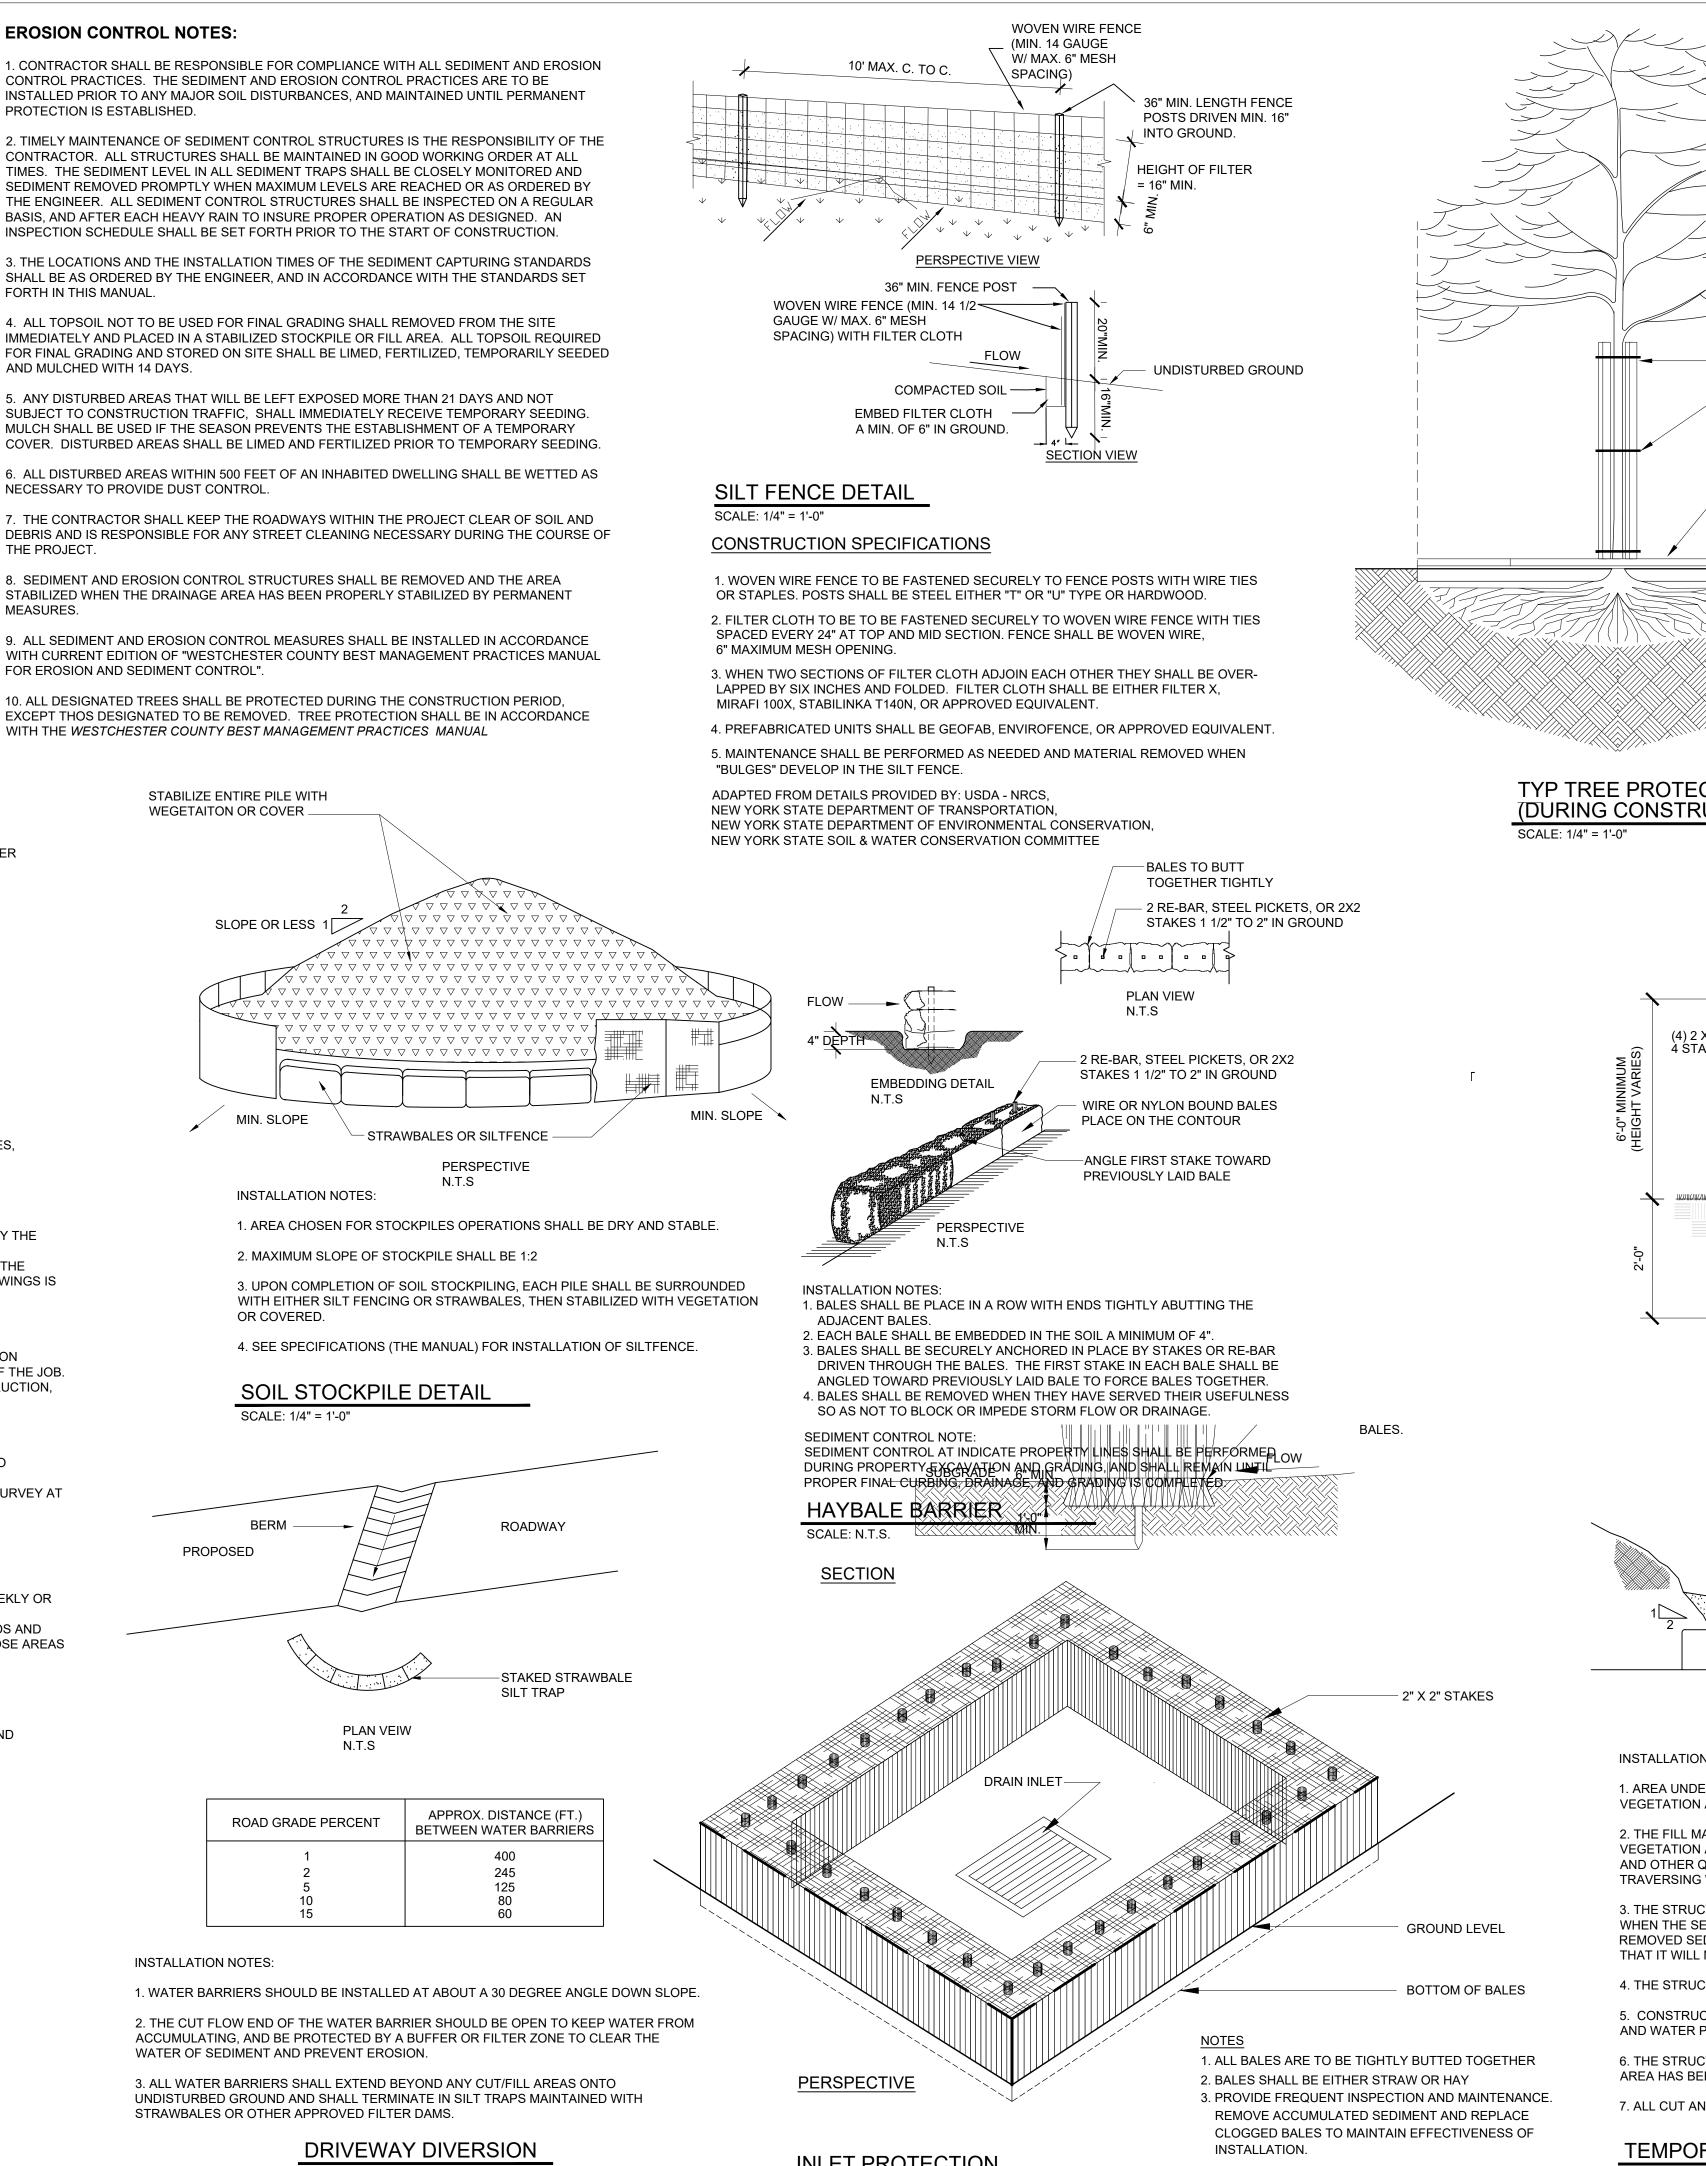



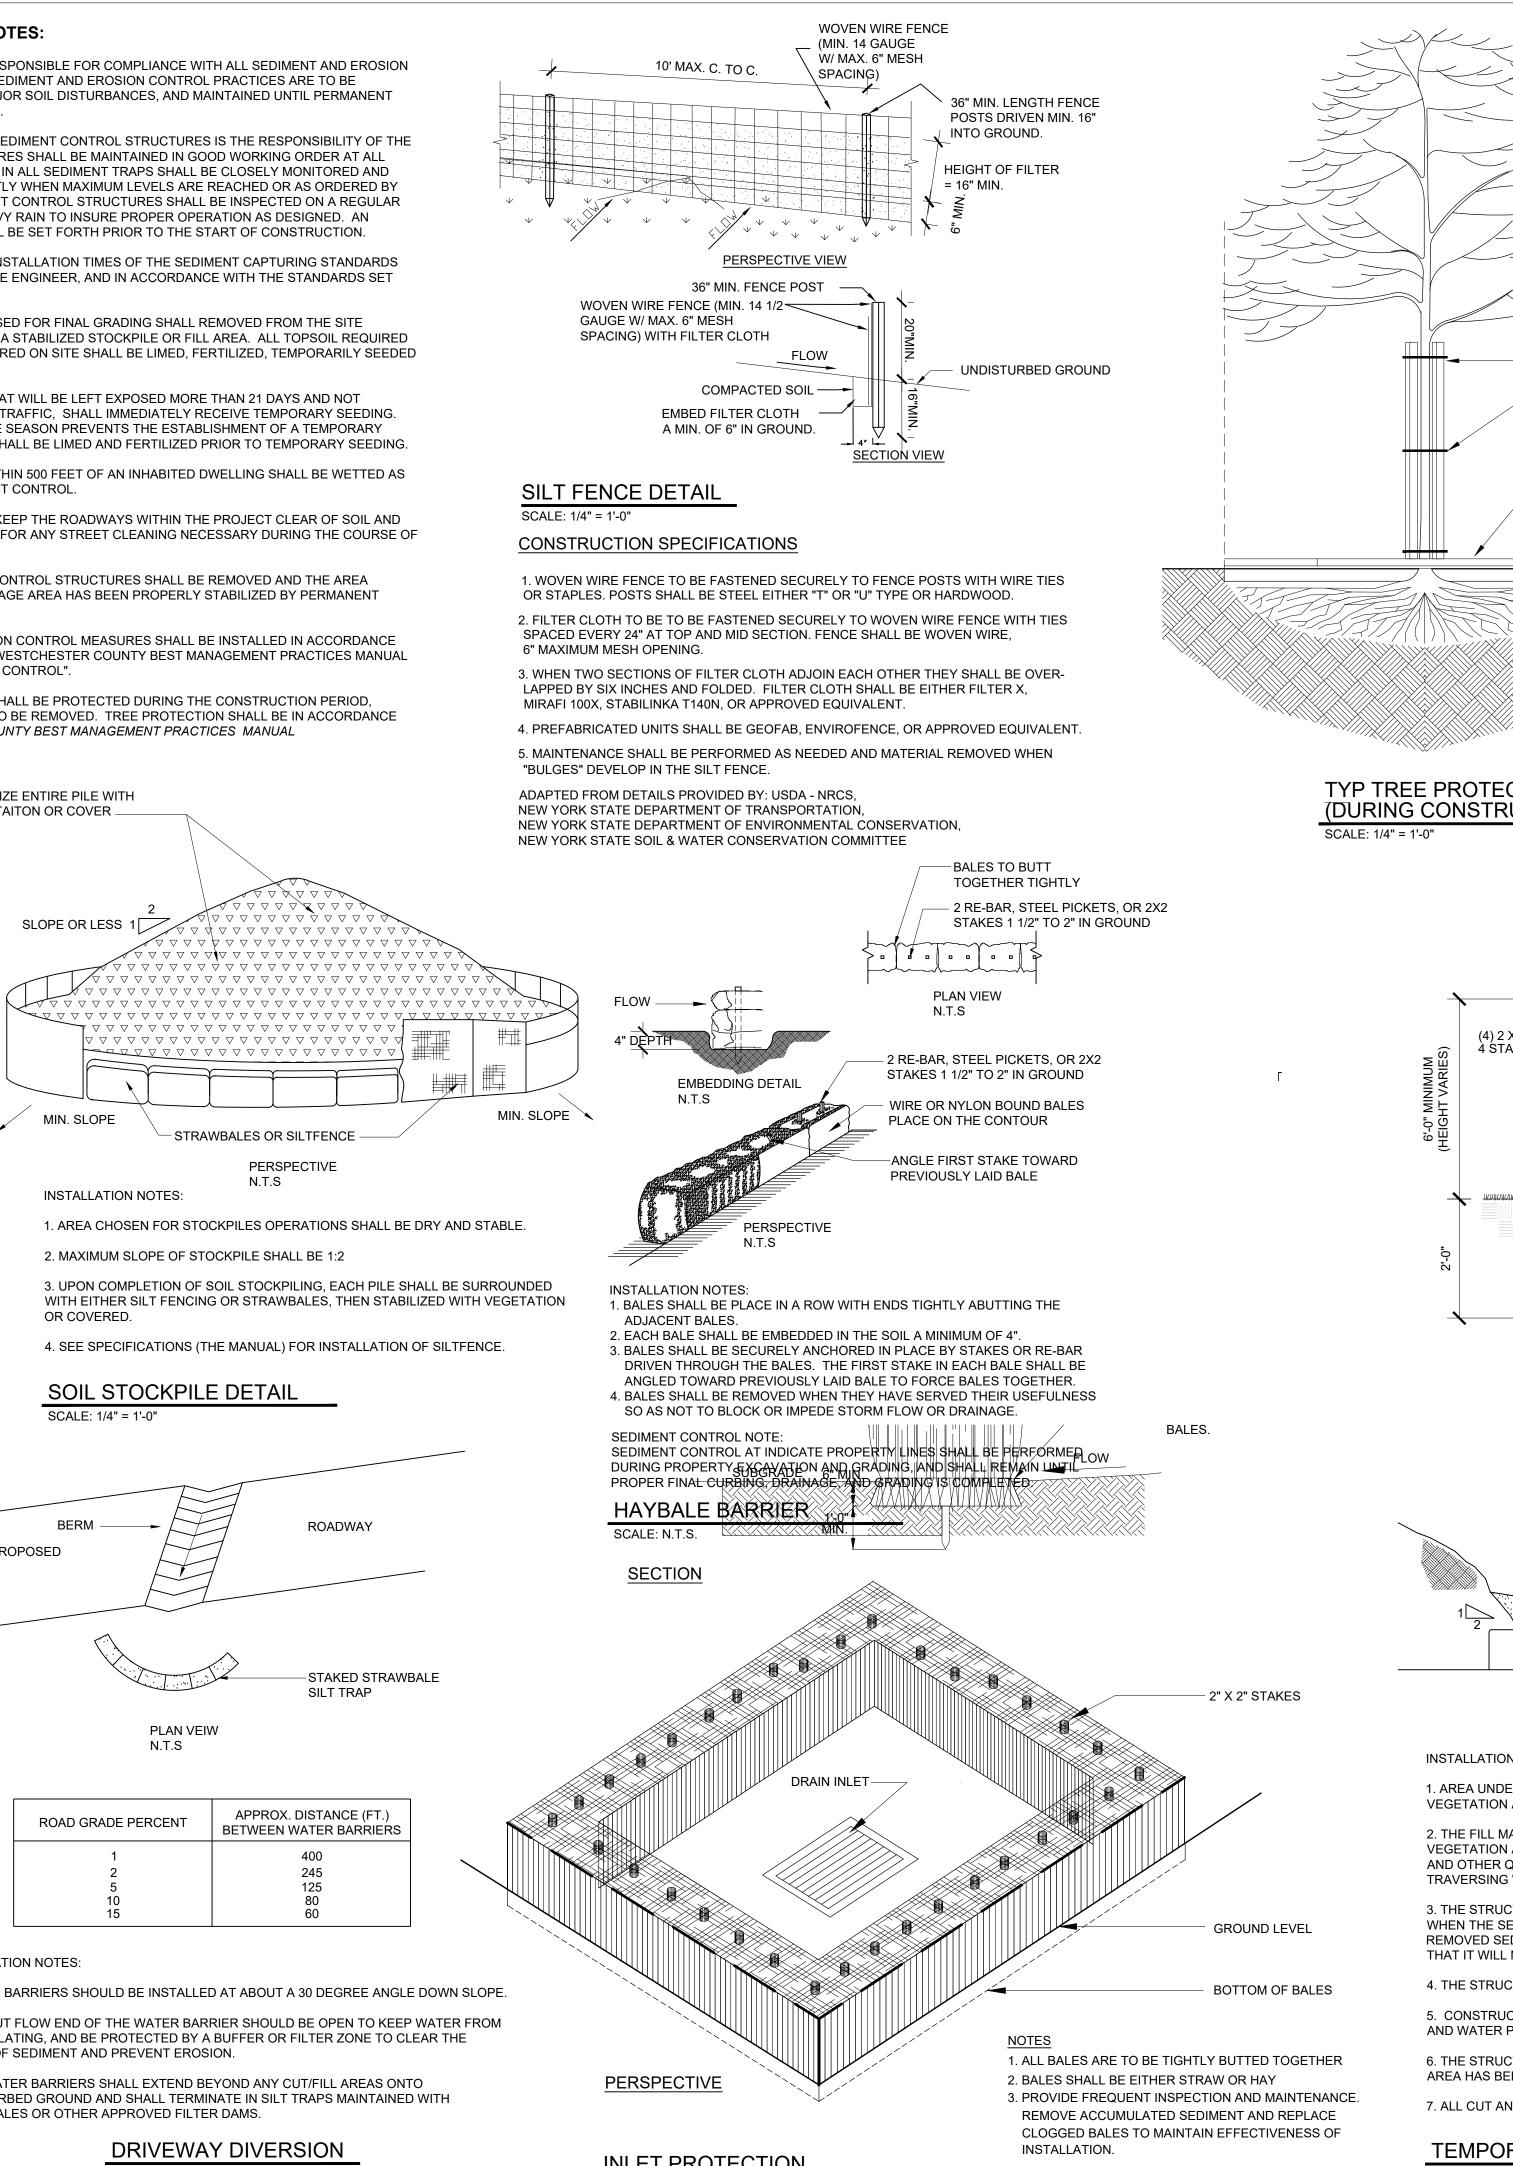


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NOTE: 1. USE THIS DETAIL WHERE USE OF PROTECTIVE FENCING DOES NOT ALLOW FOR SUFFICIENT CONSTRUCTION MANEUVERING ROOM 2. REMOVE ALL CHOKERS, BOARDS, ROPES, FILL AND PLYWOOD IMMEDIATELY AFTER COMPLETION OF CONSTRUCTION. IF CONSTRUCTION TIME IS EXTENDED, DO NOT ALLOW THESE MATERIALS TO STRANGULATE TREE OR DAMAGE BARK. 3. IF LOWER LIMBS INTERFERE WITH WORK, TIE UP WITH HEAVY DUTY JUTE CORD. 4. TIE UP LIMBS IN WARM WEATHER IF POSSIBLE 5. ADJUST HEIGHT OF PROTECTIVE BOARDS TO PREVENT ANTICIPATED DAMAGE BY EQUIPMENT. OUTLINE OF TREE CROWN (EDGE OF DRIPLINE) CORRESPONDS WITH ROOT SPREAD TRUNK PROTECTION BOARDS (2" THK) BENEATH BOARDS ARE 3.4 LAYERS OF BURLAP AROUND TRUNK TIE BOARDS SECURELY AT TOP, BOTTOM AND CENTER WITH HEAVY DUTY CORD, WIRE, OR CABLE CHOKERS. COVER PLYWOOD LAYER WITH (3'-6") FILL SPREAD (3/4") THICK (USED) PLYWOOD SHEETS OR EQUAL AT TREE BASE TO ABSORB OR SPREAD ANY VEHICULAR LOADS OVER ROOT AREA WITHIN DRIPLINE ZONE.	UNIVERSAL ENGINEERING SERVICES, P.C. ENGINEERING GREEN DESIGN CONSTRUCTION MANAGEMENT 403 Main Street, Suite 871 Armonk, New York 10504 TEL: (212) 586-5192 FAX: (914) 470-1133 E-MAIL: JPATERNO@UESPC.COM UES NOTE: PLANS ARE NOT TO BE SCALED. CONTRACTOR IS TO MAKE NO ASSUMPTIONS WITH REGARD TO THESE DRAWINGS. ANY ADDITIONAL INFORMATION OR DIMENSIONS REQUIRED TO PROPERLY ESTIMATE OR ERECT THIS PROJECT WILL BE SUPPLIED BY THE ENGINEER UPON REQUEST. CONTRACTOR SHALL VERIFY IN THE FIELD ALL DIMENSIONS AND BE RESPONSIBLE FOR SAME. ANY DISCREPANCIES BETWEEN THE DRAWINGS AND FIELD CONDITIONS SHOULD BE REPORTED TO THE ENGINEER BEFORE PROCEEDING WITH THE WORK. THESE DRAWINGS SHALL NOT BE ALTERED WITHOUT THE CONSENT AND KNOWLEDGE OF THE ENGINEER. ALL REPRODUCTION RIGHTS RESERVED. REPRODUCTION WITHOUT PERMISSION IS PROHIBITED.
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ELEVATION N.T.S	PROJECT LOCATION:         4 LEDGEWOOD PLACE         ARMONK, NEW YORK         TOTAL AREA: AS NOTED         SHEET TITLE:
ON NOTES: DER EMBANKMENT SHALL BE CLEARED, GRUBBED, AND STRIPPED OF ANY IN AND ROOT MAT. THE POOL AREA SHALL BE CLEARED AS WELL. MATERIAL FOR THE EMBANKMENT SHALL BE FREE OF ROOTS OR OTHER WOODY IN AS WELL AS OVER SIZED STONES, ROCKS, ORGANIC MATERIAL R QUESTIONABLE MATERIAL. THE EMBANKMENT SHALL BE COMPACTED BY	EROSION CONTROL DETAILS
R QUESTIONABLE MATERIAL. THE EMBANKMENT SHALL BE COMPACTED BY IG WITH EQUIPMENT WHILE IT IS BEING CONSTRUCTED. JCTURE SHALL BE REMOVED AND TRAP RESTORED TO ITS ORIGINAL DIMENSIONS SEDIMENT HAS ACCUMULATED TO 1/2 THE DESIGN DEPTH OF THE TRAP. SEDIMENT SHALL BE DEPOSITED IN A SUITABLE AREA AND IN SUCH A MANNER L NOT ERODE. JCTURE SHALL BE INSPECTED AFTER EACH RAIN REPAIRS MADE AS NEEDED. UCTION OPERATIONS SHALL BE CARRIED OUT IN SUCH A MANNER THAT EROSION R POLLUTION IS MINIMIZED. JCTURE SHALL BE REMOVED AND THE AREA STABILIZED WHEN THE DRAINAGE BEEN PROPERLY STABILIZED. AND FILL SLOPES SHALL BE 1:2 OR FLATTER. DRARY SEDIMENT BASIN TS.	PROJECT #: 19-000000 SCALE: AS NOTED DATE: 03/18/20 DRAWN BY: JOSEPH PATERNO, LEED AP REVIEWED BY: MICHAEL GIANATASIO, P.E. SEAL.: SHEET NO.: SHEET NO.: SHEET NO.:
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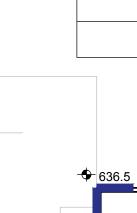


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WALKWAY 73 SF	
WALKWAY 75 SF	
WALKWAY 217 SF REMOVE 40 F	REVISIONS:         NO.       DATE       DESCRIPTION         1       03/16/2020       BLDG DEPT REVIEW#2
DRIVEWAY 6812 SF 9. TOTAL DRIVEWAY , WALKWAYS 6812 SF	
	TO THE BEST OF THE SIGNING PROFESSIONAL'S KNOWLEDGE, THE PLANS AND SPECIFICATIONS COMPLY WITH THE APPLICABLE MINIMUM BUILDING CODES. THE ENTIRE CONTENTS OF THIS DOCUMENT, INCLUDING ALL SKETCHES, PLANS, STUDIES, DRAWINGS, SCHEDULES, AND SPECIFICATIONS, AND ALL COPYRIGHTS THEREIN, ARE AND SHALL REMAIN THE SOLE AND EXCLUSIVE PROPERTY OF N2KStudio. THE DOCUMENTS AND THEIR CONTENTS MAY NOT BE
	USED, PHOTOCOPIED OR REPRODUCED DIGITALLY, ELECTRONICALLY OR IN ANY OTHER MANNER WITHOUT THE EXPRESS WRITTEN CONSENT OF N2KStudio. PROJECT: 4 LEDGEWOOD PLACE ARMONK, NY 10504 LOT & BUILDING COVERAGE DIAGRAMS
	ORIGINAL DRAWING IS 24"X36", SCALE ENTITIES ACCORDINGLY IF REDUCED. SEAL AND SIGNATURE:
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LOT COVERAGE: DRIVEWAY AND WALKWAYS	PLACE B-SCAN STICKER HERE





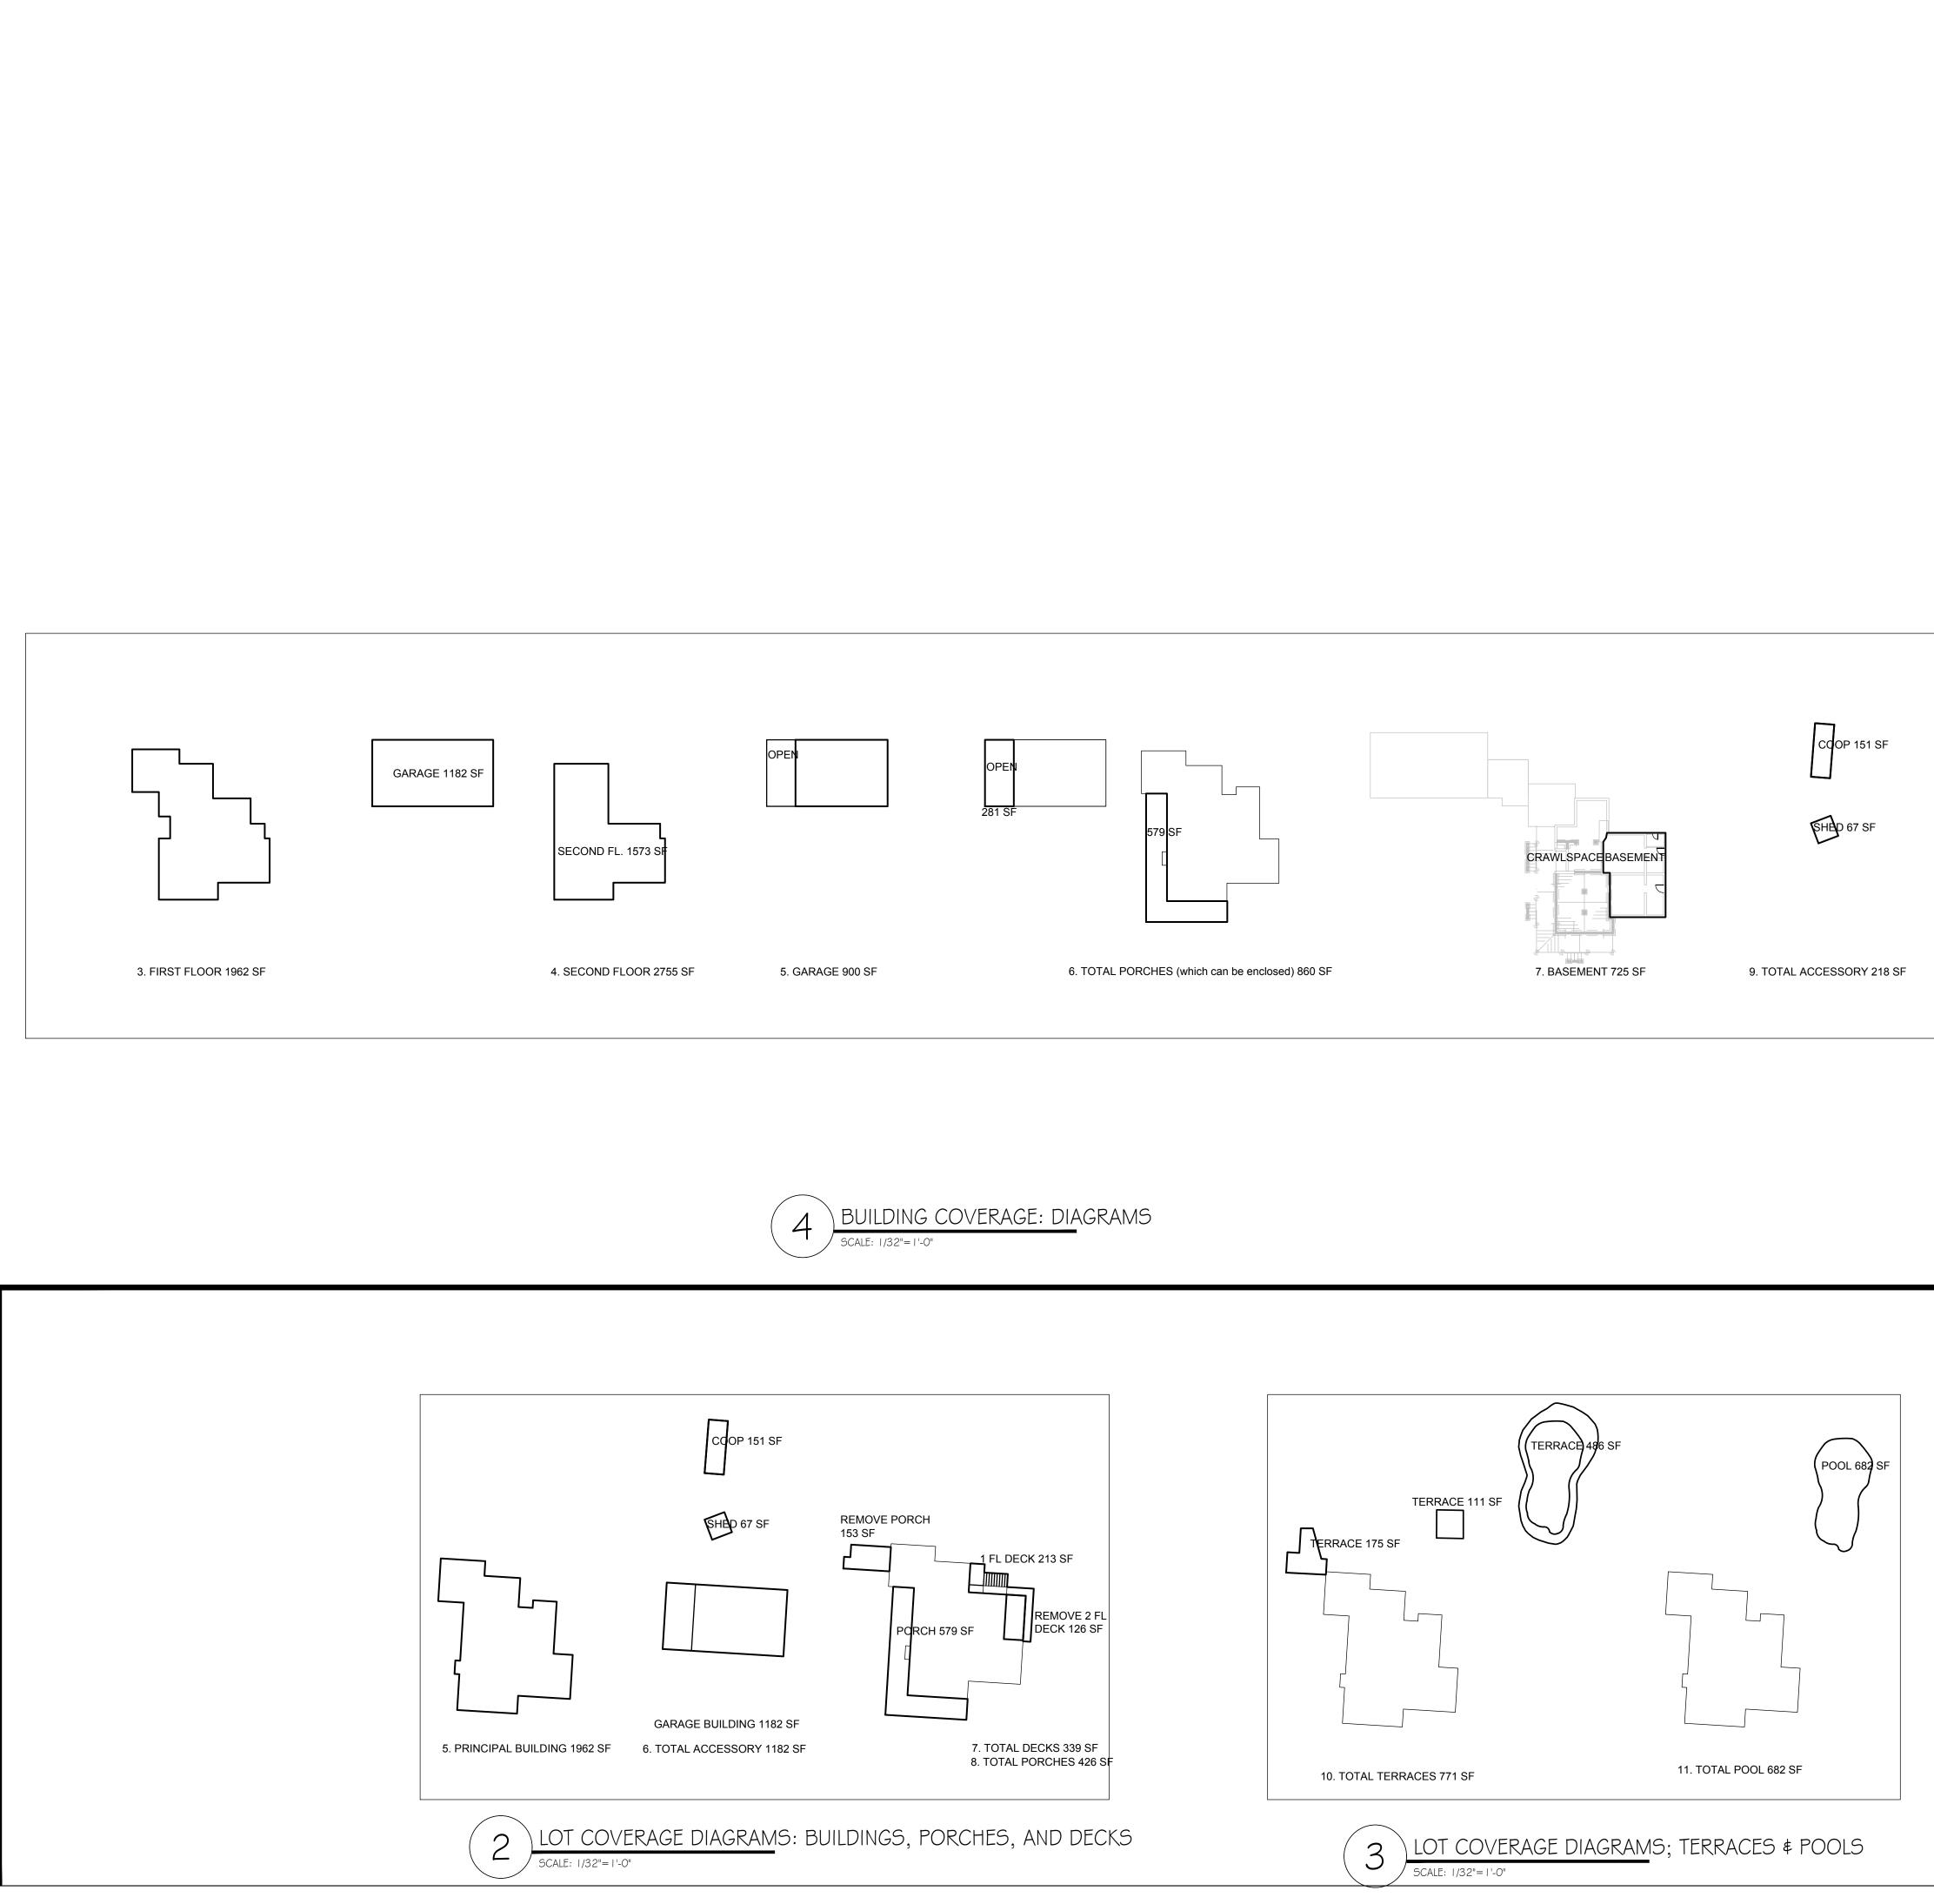




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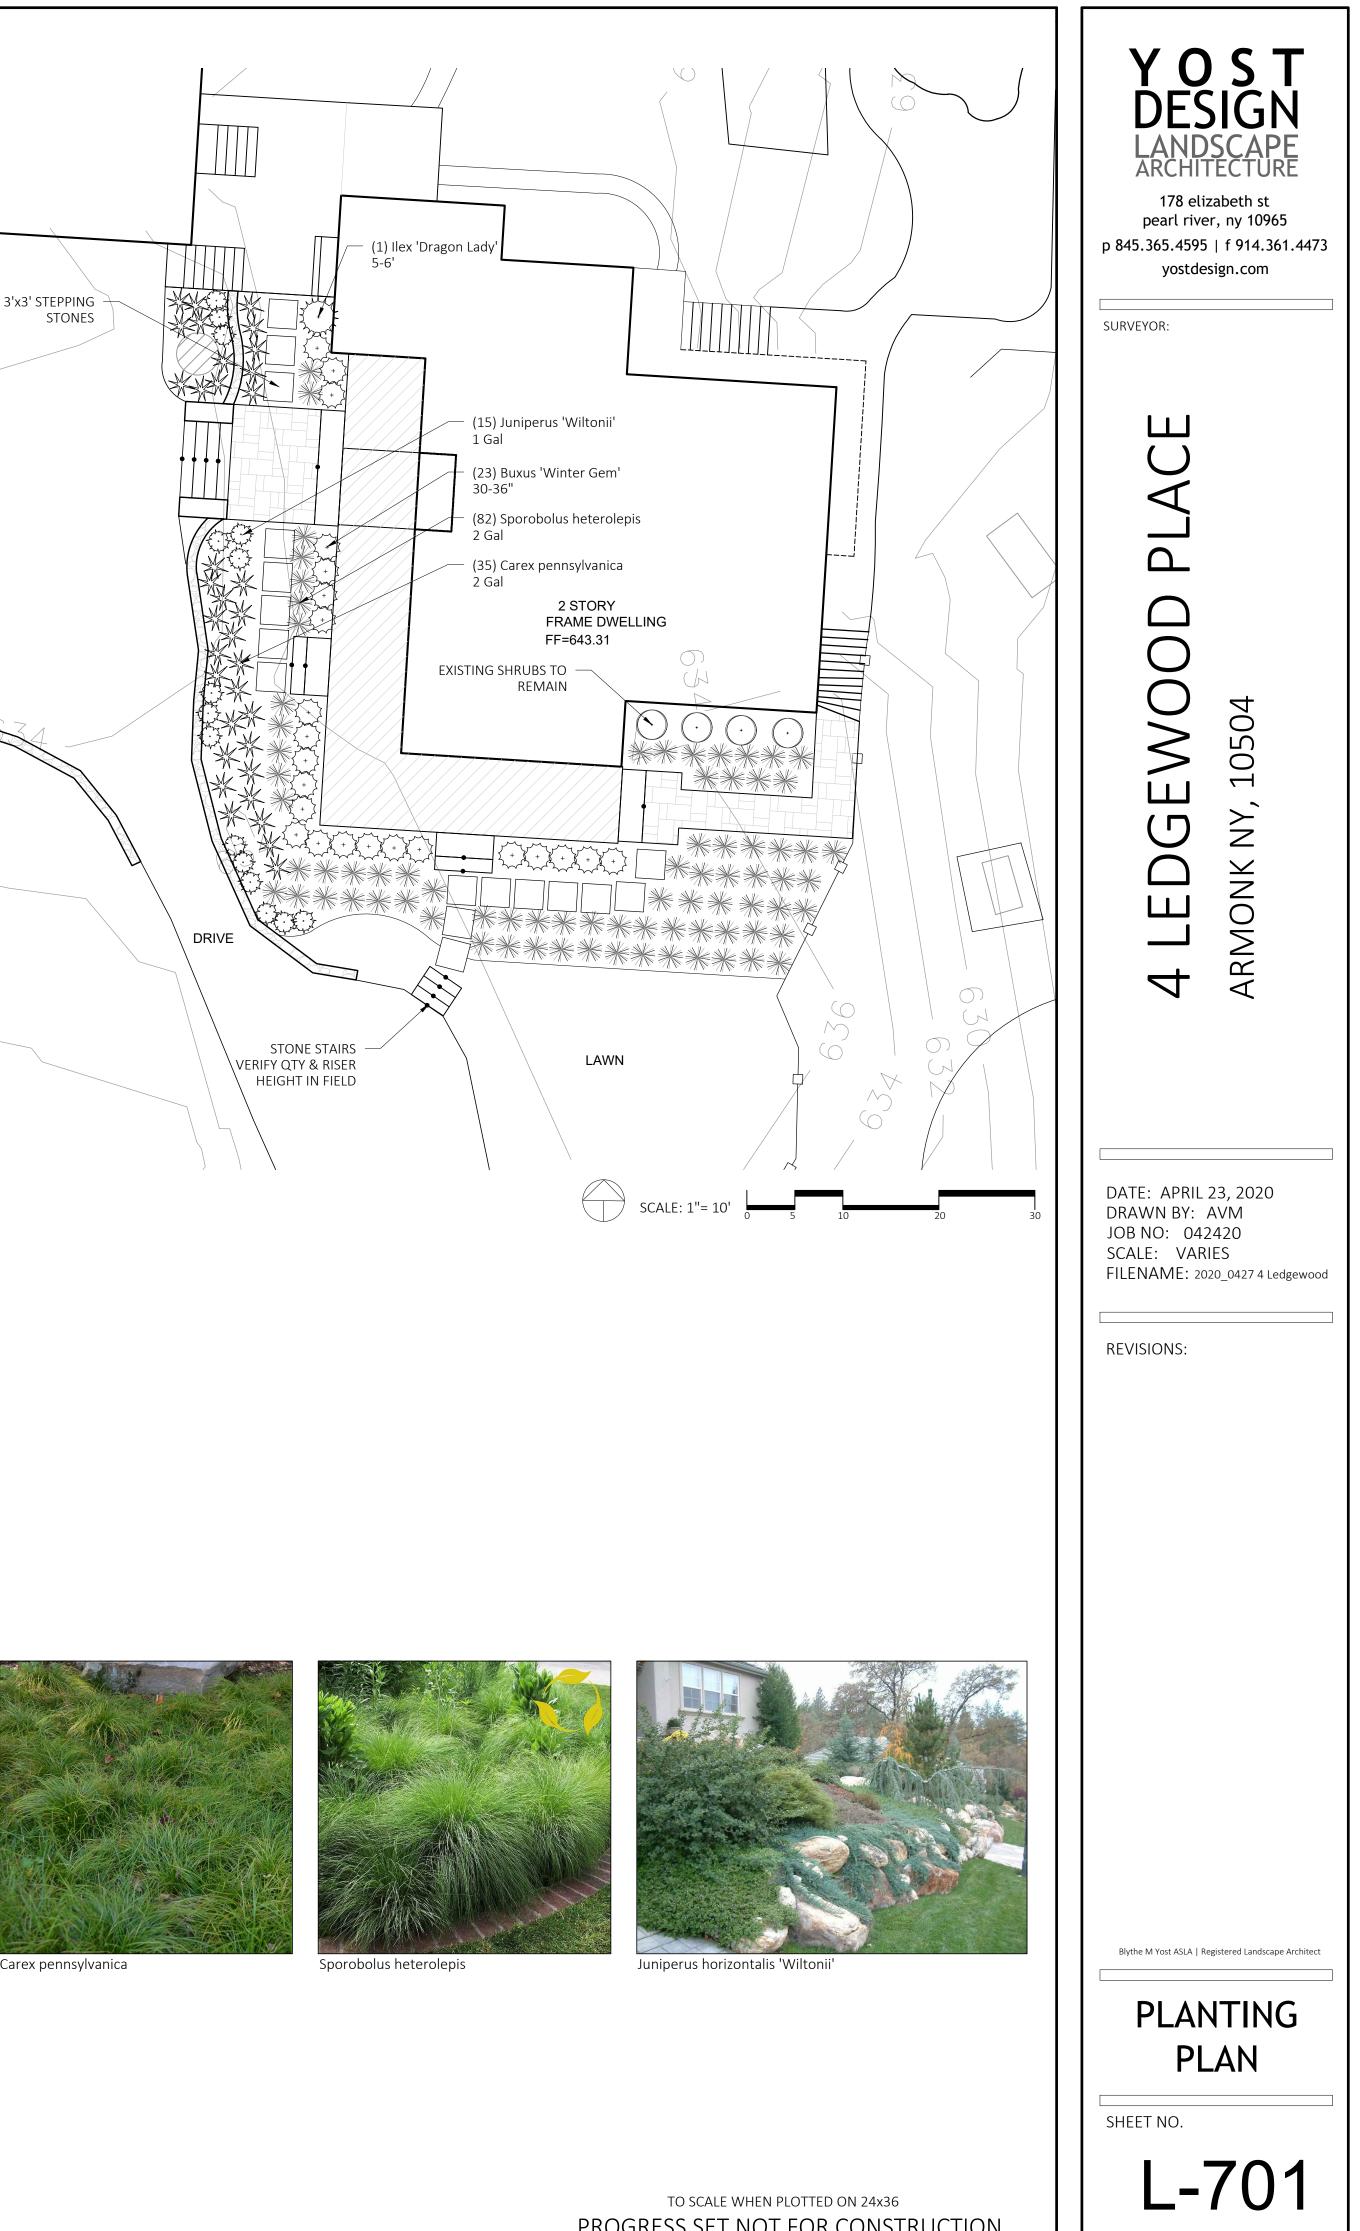
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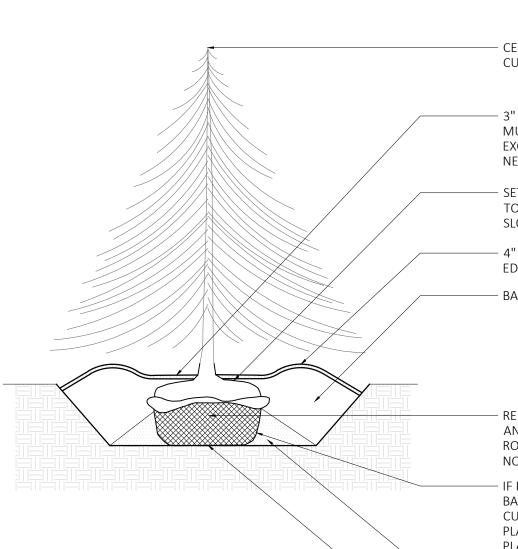






PROGRESS SET NOT FOR CONSTRUCTION

SHEET: 1 of 2

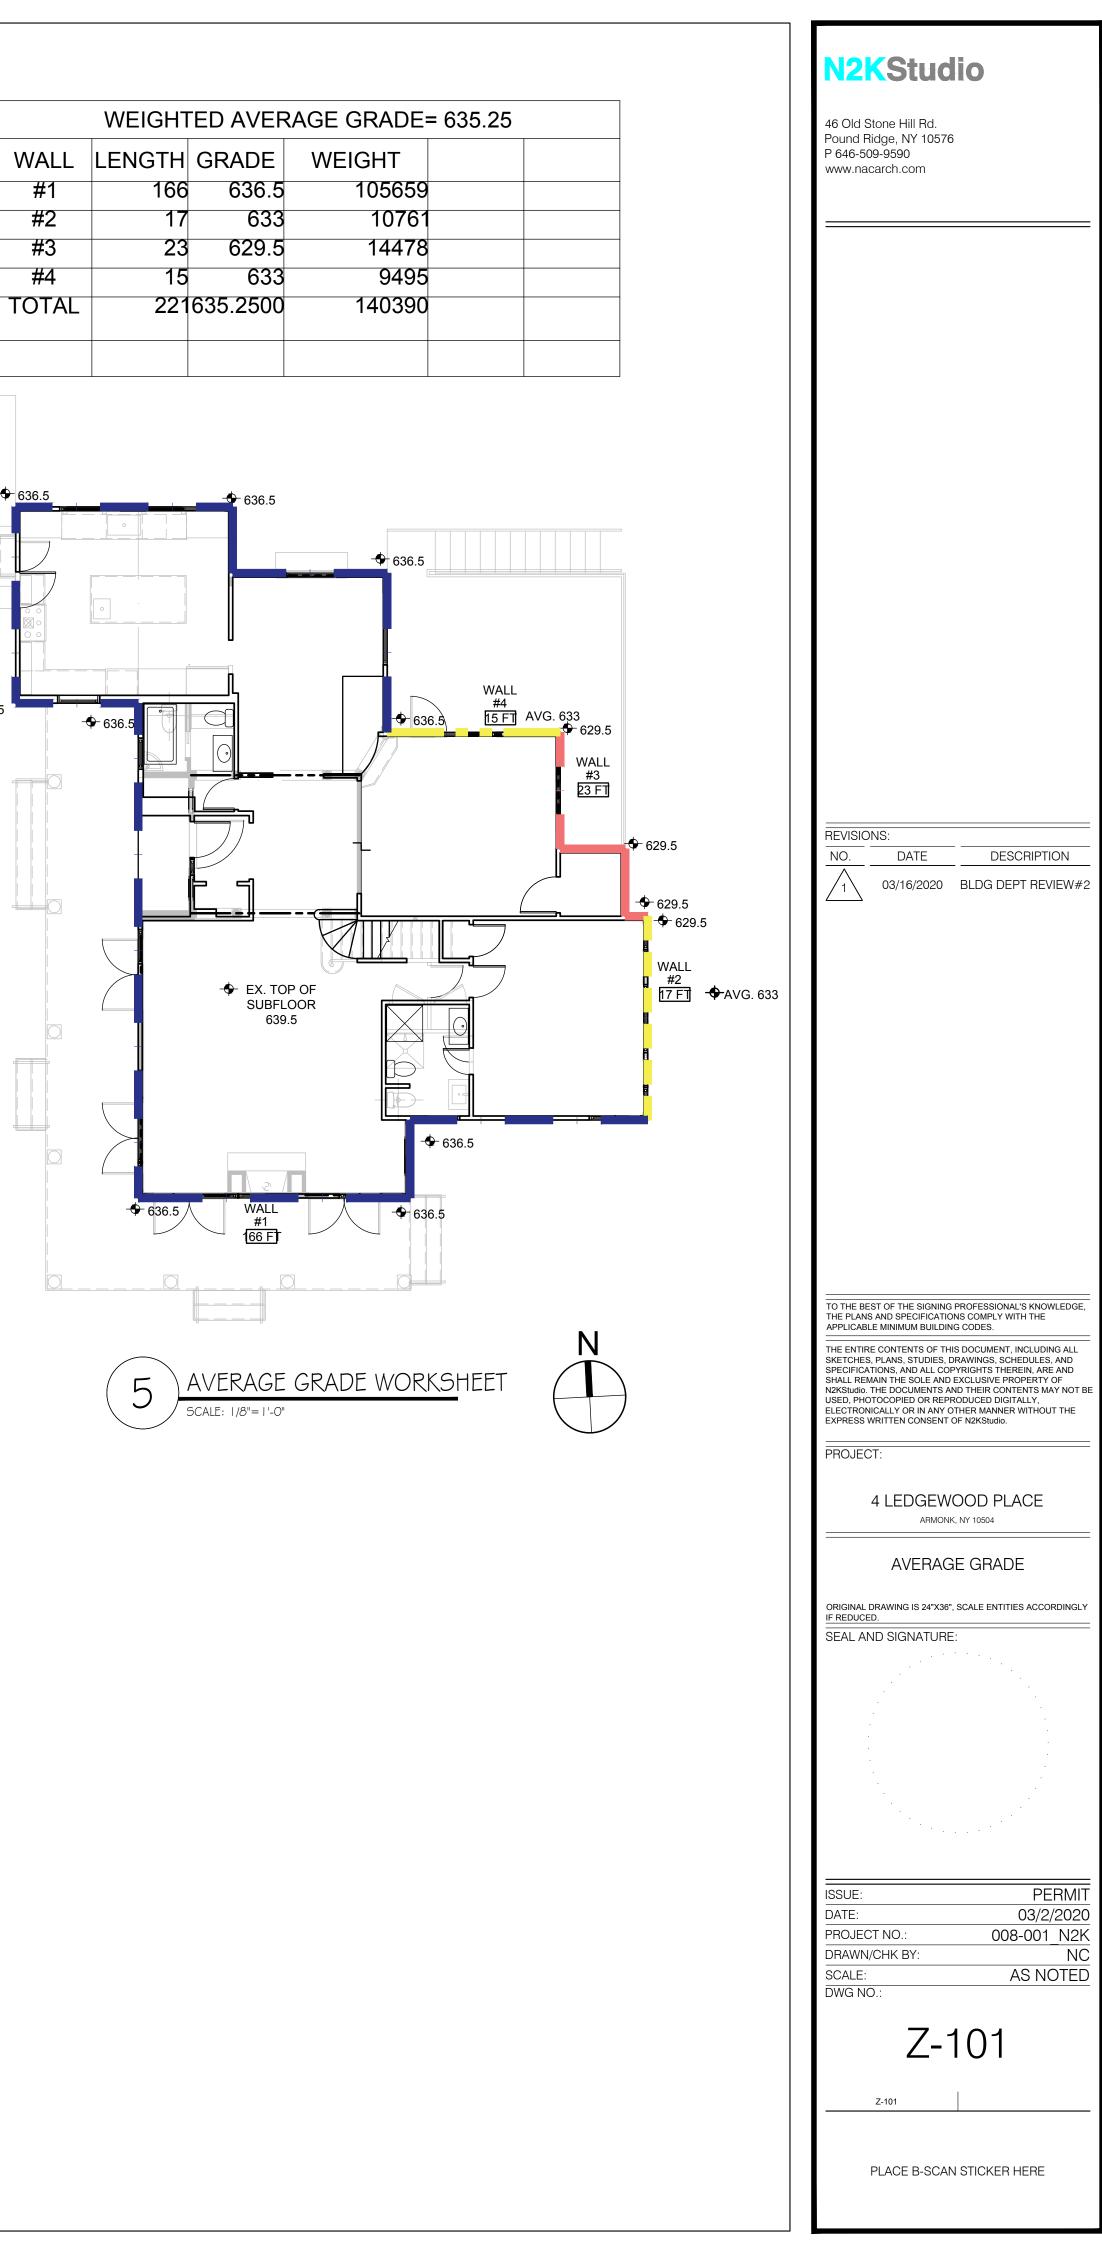

- CENTRAL LEADER SHALL NOT BE CUT OR DAMAGED

- 3" MULCH LAYER, DO NOT PLACE MULCH IN CONTACT WITH TREE TRUNK. EXCAVATE TO LOCATE FLARE IF NECESSARY.

- SET TOP OF ROOT BALL FLUSH TO GRADE OR 1-2" HIGHER IN SLOWLY DRAINING SOILS

– 4" HIGH EARTH SAUCER BEYOND EDGE OF ROOT BALL


BACKFILL WITH TOPSOIL

- REMOVE ALL TWINE, ROPE, WIRE, AND BURLAP FROM TOP HALF OF ROOT BALL AND ALL NON-BIODEGRADABLE MATERIAL

IF PLANT IS SHIPPED IN WIRE
 BASKET AROUND THE ROOT BALL,
 CUT THE WIRE BASKET IN FOUR
 PLACES AND FOLD DOWN 8" INTO
 PLANTING HOLE
 TAMP SOIL AROUND ROOT BALL BASE

FIRMLY WITH FOOT PRESSURE SO THAT ROOT BALL DOES NOT SHIFT

- SET ROOT BALL ON UNEXCAVATED OR TAMPED SOIL

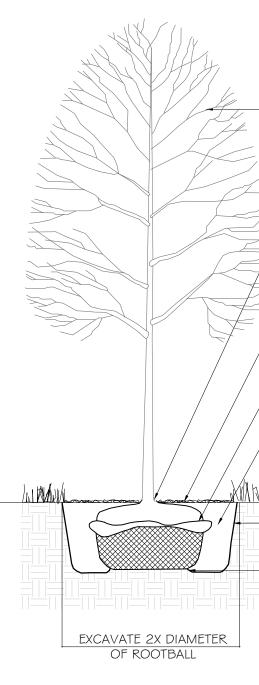

2 DECIDUOUS TREE PLANTING L-801 SCALE: 1/4"=1'

# 1 EVERGREEN TREE PLANTING L-801 SCALE: 1/4"=1'

# PLANTING NOTES

1. PLANT MATERIAL SHALL BE FURNISHED AND INSTALLED AS INDICATED; INCLUDING ALL LABOR, MATERIALS, PLANTS, EQUIPMENT, INCIDENTALS, AND CLEAN-UP.

2. THE CONTRACTOR SHALL BE RESPONSIBLE FOR PLANTING AT CORRECT GRADES AND ALIGNMENT. LAYOUT TO BE APPROVED BY LA PRIOR TO INSTALLATION.

3. PLANTS SHALL BE TYPICAL OF THEIR SPECIES AND VARIETY; HAVE NORMAL GROWTH HABITS; WELL DEVELOPED BRANCHES, DENSELY FOLIATED, VIGOROUS ROOT SYSTEMS AND BE FREE FROM DEFECTS AND INJURIES.

4. CONTRACTOR SHALL REPORT ANY SOIL OR DRAINAGE CONDITIONS CONSIDERED DETRIMENTAL TO THE GROWTH OF PLANT MATERIAL.

5. ALL PLANT MATERIAL SHALL BE GUARANTEED BY THE CONTRACTOR TO BE IN VIGOROUS GROWING CONDITION. PROVISIONS SHALL BE MADE FOR A GROWTH GUARANTEE OF AT LEAST TWO YEARS FROM THE DATE OF ACCEPTANCE FOR TREES AND SHRUBS. REPLACEMENTS SHALL BE MADE AT THE BEGINNING OF THE FIRST SUCCEEDING PLANTING SEASON. ALL REPLACEMENTS SHALL HAVE A GUARANTEE EQUAL TO THAT STATED ABOVE.

6. INSOFAR AS IT IS PRACTICABLE, PLANT MATERIAL SHALL BE PLANTED ON THE DAY OF DELIVERY. IN THE EVENT THIS IS NOT POSSIBLE, THE CONTRACTOR SHALL PROTECT, IRRIGATE & CARE FOR STOCK NOT PLANTED.

7. QUALITY AND SIZE OF PLANTS, SPREAD OF ROOTS, AND SIZE OF BALLS SHALL BE IN ACCORDANCE WITH ANSI 260 (REV. 1980) "AMERICAN STANDARD FOR NURSERY STOCK" AS PUBLISHED BY THE AMERICAN ASSOCIATION OF NURSERYMEN, INC.

8. ALL PLANTS SHALL BE PLANTED IN AMENDED TOP SOIL THAT IS THOROUGHLY WATERED AND TAMPED AS BACK FILLING PROGRESSES. PLANTING MIX TO BE AS SHOWN ON PLANTING DETAILS. LARGE PLANTING AREAS TO INCORPORATE FERTILIZER AND SOIL CONDITIONERS AS STATED IN PLANTING SPECIFICATIONS.

9. PLANTS SHALL NOT BE BOUND WITH WIRE OR ROPE AT ANY TIME SO AS TO DAMAGE THE BARK OR BREAK BRANCHES. PLANTS SHALL BE HANDLED FROM THE BOTTOM OF THE BALL ONLY.

10. PLANTING OPERATIONS SHALL BE PERFORMED DURING PERIODS WITHIN THE PLANTING SEASON WHEN WEATHER AND SOIL CONDITIONS ARE SUITABLE AND IN ACCORDANCE WITH ACCEPTED LOCAL PRACTICE. PLANTS SHALL NOT BE INSTALLED IN TOPSOIL THAT IS IN A MUDDY OR FROZEN CONDITION.

11. NO PLANT, EXCEPT GROUND COVERS, SHALL BE PLANTED LESS THAN TWO FEET FROM EXISTING STRUCTURES AND SIDEWALKS.

12. SET ALL PLANTS PLUMB AND STRAIGHT. SET AT SUCH LEVEL THAT A NORMAL OR NATURAL RELATIONSHIP TO THE CROWN OF THE PLANT WITH THE GROUND SURFACE WILL BE ESTABLISHED. LOCATE PLANT IN THE CENTER OF THE PIT.

13. ALL INJURED ROOTS SHALL BE PRUNED UTILIZING CLEAN, SHARP TOOLS TO MAKE CLEAN ENDS BEFORE PLANTING.

14. EACH TREE AND SHRUB SHALL BE PRUNED IN ACCORDANCE WITH STANDARD HORTICULTURAL PRACTICE TO PRESERVE NATURAL CHARACTER OF PLANT. PRUNING SHALL BE DONE WITH CLEAN, SHARP TOOLS.

16. ALL PLANTING BEDS SHALL BE MULCHED WITH 2" LAYER OF DOUBLE SHREDDED HARDWOOD BARK MULCH.

17. ALL DISTURBED AREAS TO BE TREATED WITH 3" TOP SOIL & SEEDED IN ACCORDANCE WITH PERMANENT STABILIZATION METHODS.

TREE AS SPECIFIED

TRUNK FLARE SHALL BE 1-2" ABOVE GRADE. EXCAVATE TO LOCATE FLARE IF NECESSARY.

18" DIAMETER ORGANIC MULCH RING, 2" DEPTH

REMOVE TWINE FROM TRUNK AND FOLD DOWN BURLAP TO EXPOSE TOP 1/3 OF ROOTBALL

BACKFILL WITH EXCAVATED SOIL

— SCORE WALLS OF TREE PIT

SET ROOTBALL ON 2" HIGH SOIL BASE NOTES: 1. SET TREE PLUMB.

2. DO NOT STAKE UNLESS DIRECTED TO DO SO BY LANDSCAPE ARCHITECT


3. REMOVE COMPLETELY ANY NON-BIODEGRADABLE MATERIALS BINDING THE ROOTBALL.

4. REMOVE WIRE BASKET COMPLETELY IF ROOTBALL WILL BARE. OTHERWISE, CLIP AND PEEL BACK WIRE BASKET AT LEAST ONE THIRD OF THE WAY FROM THE TOP OF THE ROOTBALL.

5. SATURATE SOIL WITHIN SIX (6) HOURS OF PLANTING AND WATER AS NECESSARY UNTIL IRRIGATION IS INSTALLED.


6. DO NOT ADD ANY SOIL AMENDMENTS OTHER THAN COMPOST UNLESS DIRECTED TO BY LANDSCAPE ARCHITECT.

7. DO NOT ADD ANY SOIL OR MULCH AGAINST TRUNK OF TREE. IF ROOT FLARE IS NOT EXPOSED, REMOVE SOIL AND EXPOSE.

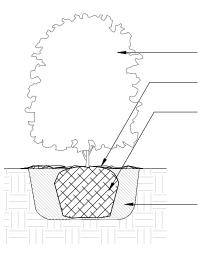

BACKFILL WITH TOPSOIL

# 3 SHRUB PLANTING L-801 SCALE: 1/2"=1'

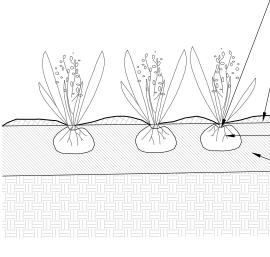

4 GROUNDCOVER PLANTING L-801 SCALE:1/2"=1'

# SHRUB, AS SPECIFIED 2" DEEP ORGANIC MULCH RING SET PLANT PLUMB IN EXCAVATED HOLE

# NOTES:

POSITION ROOT CROWN

AT FINISHED GRADE

2" MULCH

 FOR B & B PLANT MATERIAL, REMOVE ALL TWINE AND ROLL BACK BURLAP FROM TOP 1/2 OF BALL. IF ANY MATERIALS USED TO BIND THE ROOTBALL ARE NON-BIODEGRADEABLE, REMOVE COMPLETELY INCLUDING WIRE BASKET.

2. FOR CONTAINER GROWN PLANT MATERIAL, REMOVE CONTAINER. TO HELP PREVEN LOOSENING OF SOIL AND SCARIFY BALL TO HELP PREVENT GIRDLING ROOTS.

3. SATURATE SOIL WITHIN SIX (6) HOURS OF PLANTING, AND WATER AS NECESSARY UNTIL IRRIGATION INSTALLED.

4. NO MULCH OR SOIL SHOULD BE PLACED AGAINST THE PLANT'S TRUNK.

 REMOVE CONTAINER AND GENTLY LOOSEN ROOTS
 ROTOTILL 2" TOPSOIL AND 2" OF COMPOST INTO NATIVE SOIL UNLESS LANDSCAPE ARCHITECT SPECIFIES OTHERWISE




178 elizabeth st pearl river, ny 10965 p 845.365.4595 | f 914.361.4473 yostdesign.com

Blythe M Yost ASLA | Registered Landscape Architect

SURVEYOR:

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# Ο ഗ > Ο -Z J $\searrow$ Ζ Ο $\geq$ $\sim$ $\triangleleft$ DATE: APRIL 23, 2020 DRAWN BY: AVM JOB NO: 042420 SCALE: VARIES FILENAME: 2020\_0427 4 Ledgewood **REVISIONS:**



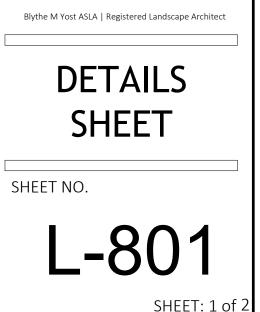

PLANNING DEPARTMENT

Adam R. Kaufman, AICP

**Director of Planning** 

TOWN OF NORTH CASTLE

WESTCHESTER COUNTY 17 Bedford Road Armonk, New York 10504-1898

January 29, 2019 Telephone: (914) 273-3542 Fax: (914) 273-3554 www.northcastleny.com

# FLOOR AREA CALCULATIONS WORKSHEET

Application Name or Identifying Title:	4 LEDGEWOOD PLACE	Date: 4.29-26
Tax Map Designation or Proposed Lot No	/07.02-2-46	
Floor Area		
1. Total Lot Area (Net Lot Area for	Lots Created After 12/13/06):	<u> </u>
2. <b>Maximum</b> permitted floor area	per Section 355-26.B(4)):	13,607+461 SF
3. Amount of floor area contained $\frac{1962}{0}$ existing +0		1962 SF
4. Amount of floor area contained v <u>/573</u> existing + <u>o</u>	vithin second floor: proposed = GARAGE //82 SF	2755 SF
5. Amount of floor area contained where $900$ existing $+$ 0		900 SF
6. Amount of floor area contained where $434$ existing + $426$	vithin porches capable of being enclosed: proposed =	860 SF
7. Amount of floor area contained w 725 existing + 0	vithin basement (if applicable – see definition): proposed =	725 SF
8. Amount of floor area contained v o existing + o	vithin attic (if applicable – see definition): proposed =	0_
9. Amount of floor area contained v <u>2/8</u> existing + <u>o</u>		7420
10. Proposed floor area: Total of Li	1 = 3 - 9 = 1	

If Line 10 is less than or equal to Line 2, your proposal **complies** with the Town's maximum floor area regulations and the project may proceed to the Residential Project Review Committee for review. If Line 10 is greater than Line 2 your proposal does not comply with the Town's regulations.



4-29-20 Date