

TOWN OF NORTH CASTLE, NEW YORK

WATER DISTRICT No. 1


NORTH BROADWAY ULTRAVIOLET DISINFECTION



86-16786


CONTRACT No. 1 - GENERAL

2015

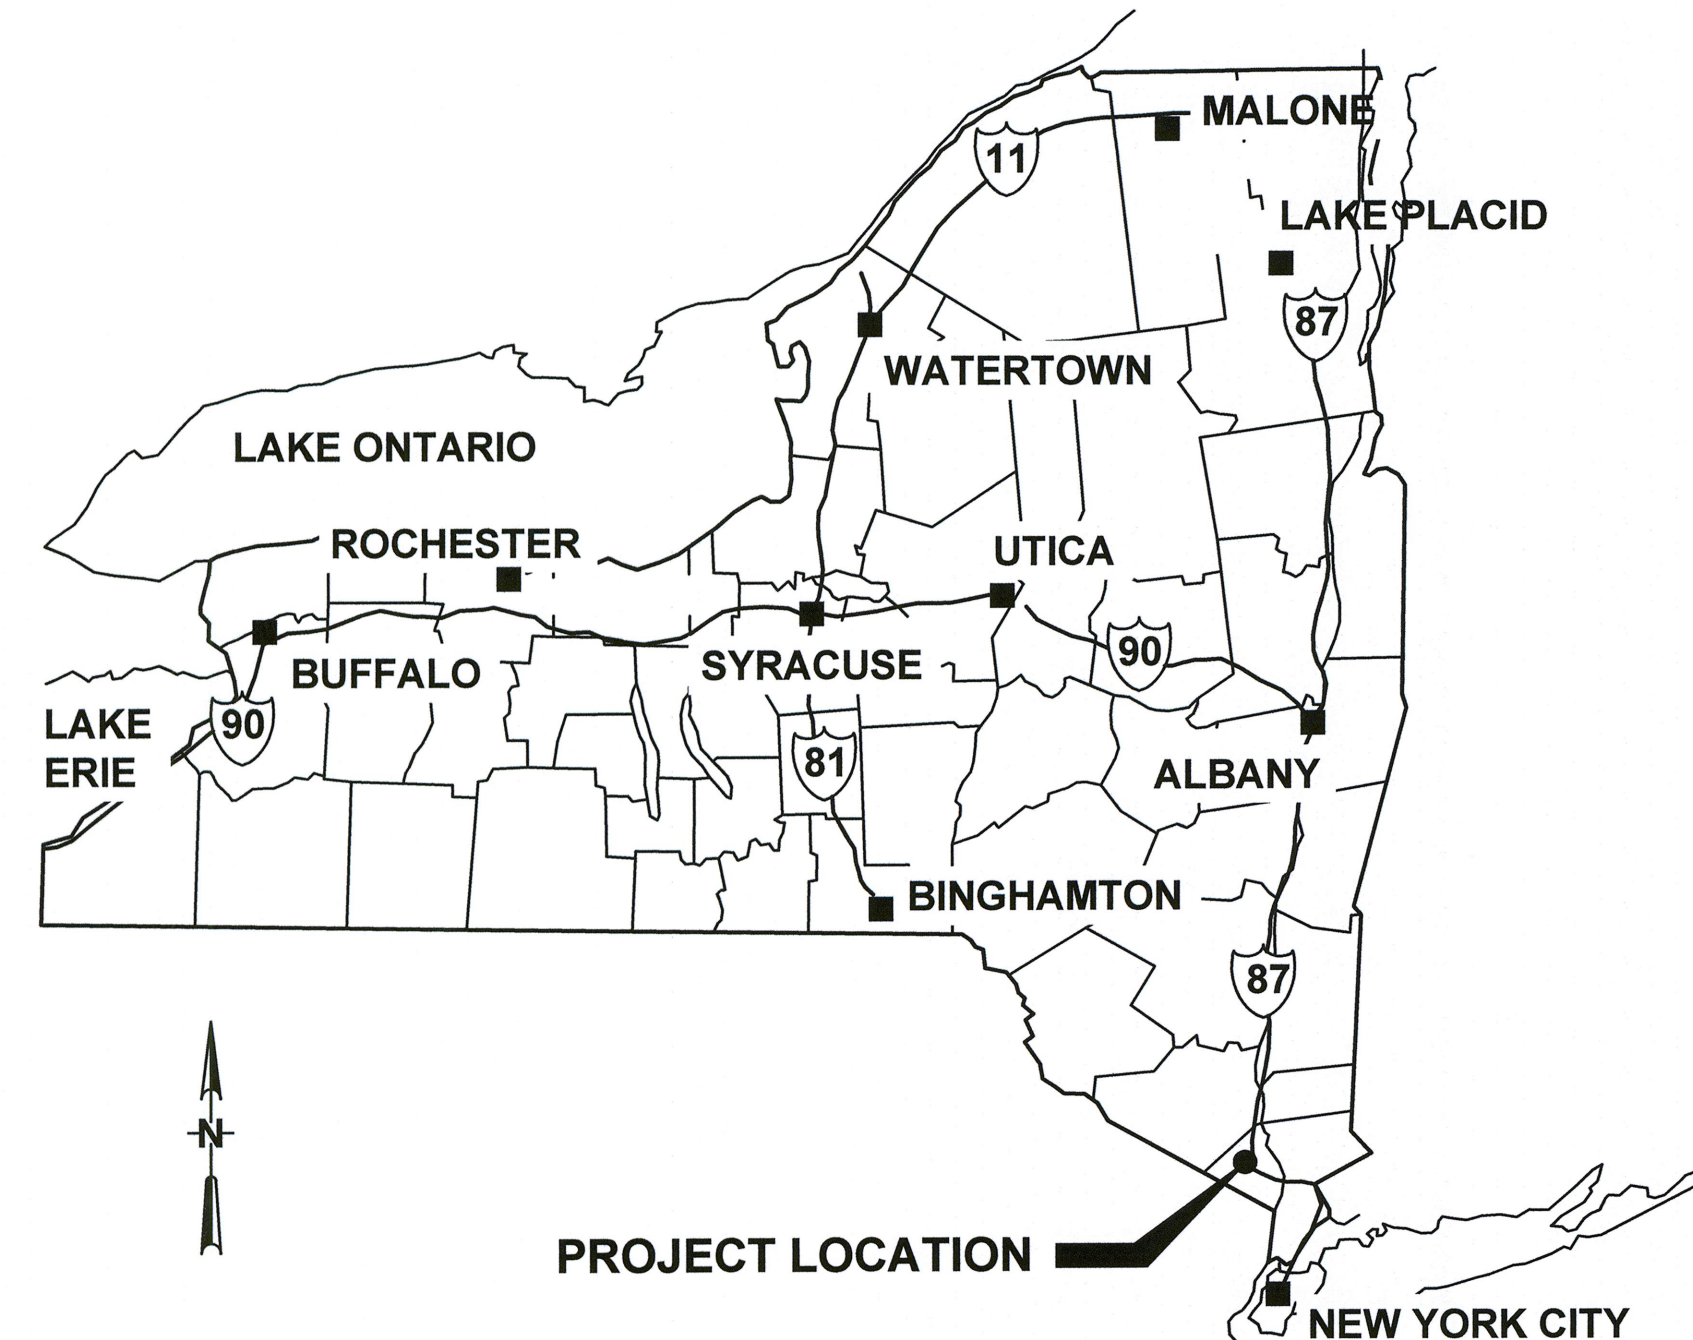

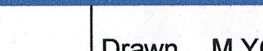
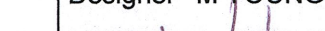





PROJECT LOCATION

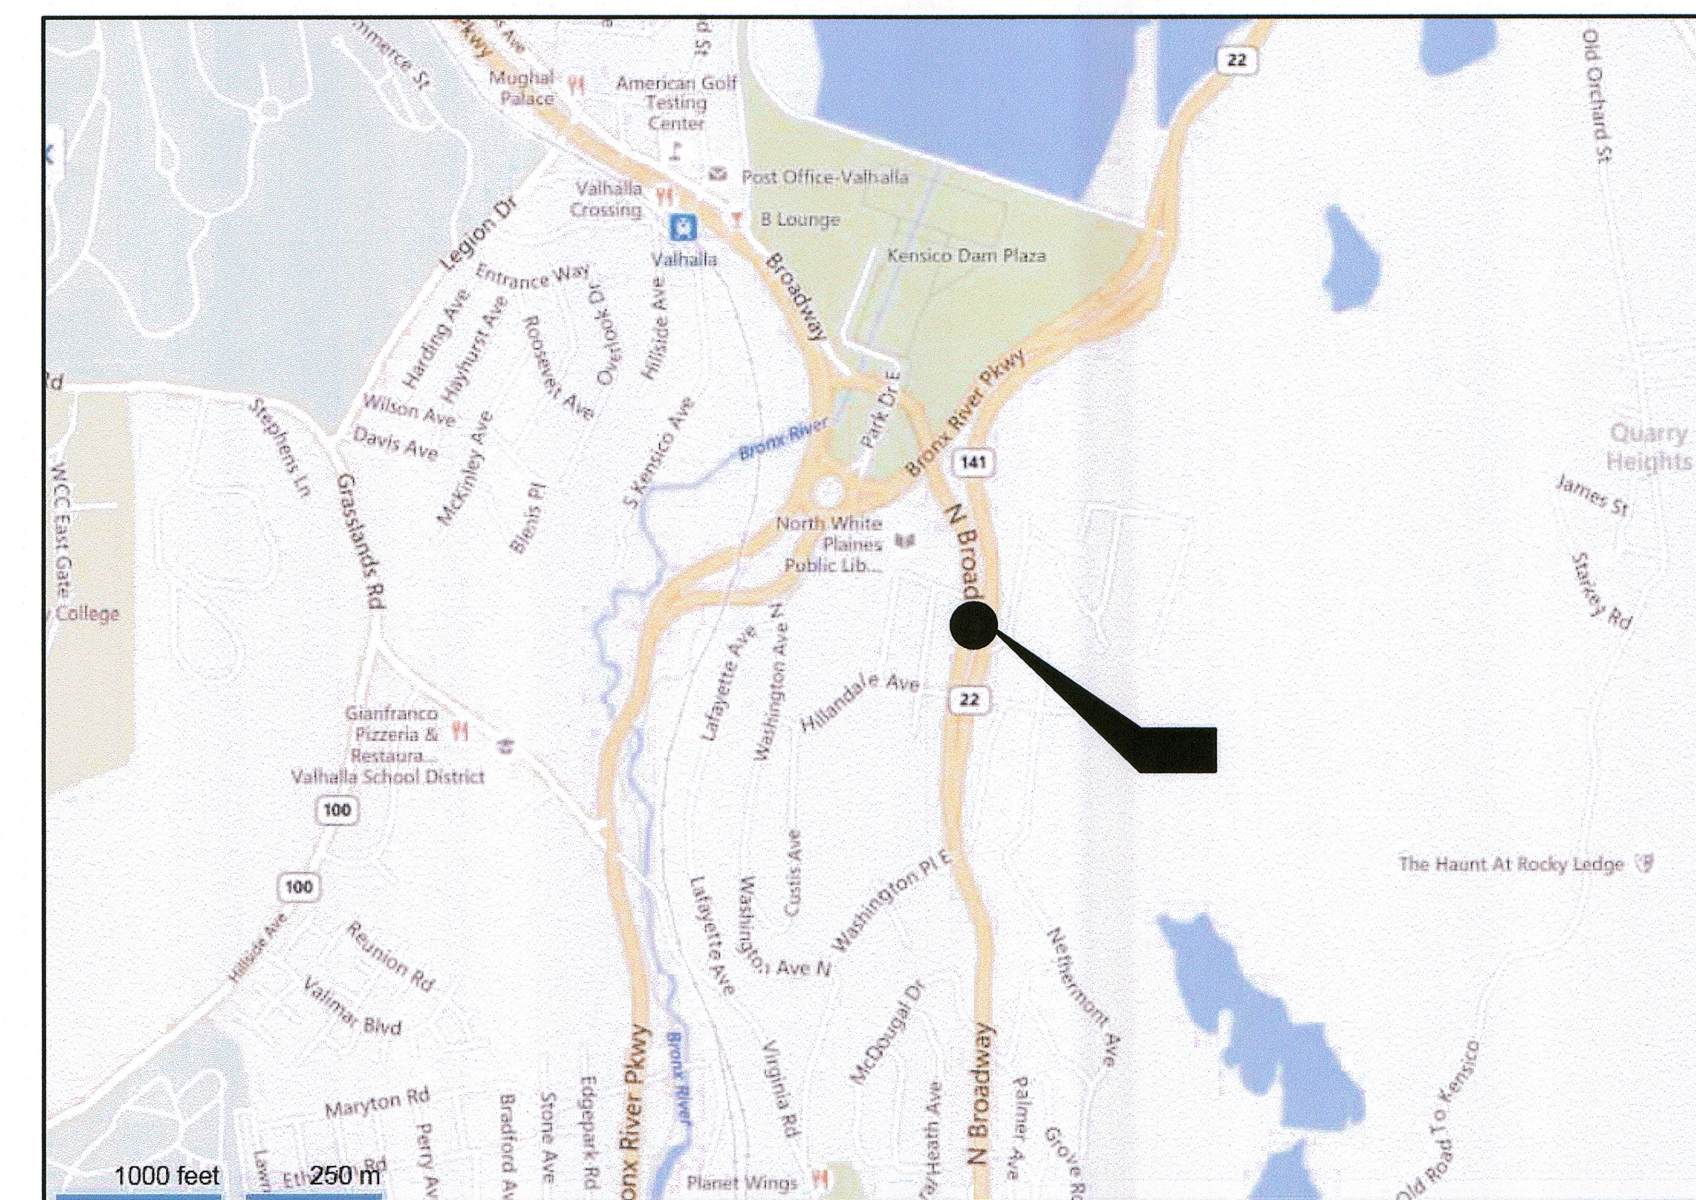LOCATION PLAN

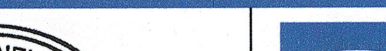


AREA MAP

				NOTES: UNDERGROUND FACILITIES, STRUCTURES, AND UTILITIES HAVE BEEN PLOTTED FROM AVAILABLE SURVEYS AND RECORDS, AND THEREFORE THEIR LOCATIONS MUST BE CONSIDERED APPROXIMATE ONLY. THERE MAY BE OTHERS, THE EXISTENCE OF WHICH IS PRESENTLY NOT KNOWN.				 				 GHD Consulting Services, Inc. One Remington Park Drive Cazenovia NY 13035 USA T 1 315 679 5800 F 1 315 679 5801 E cazmail@ghd.com W www.ghd.com				Drawn M YOUNG		Designer M YOUNG		Client TOWN OF NORTH CASTLE, NEW YORK	
												Drafting Check 		Design Check 		Project NORTH BROADWAY ULTRAVIOLET DISINFECTION COVER					
												Approved (Project Director) 		Contract No. 1		Title					
0 FOR CONSTRUCTION				MRY		NJH		KC		10/15						Original Size					
No		Revision		Note: * indicates signatures on original issue of drawing or last revision of drawing				Drawn		Job Manager		Project Director		Date		Arch D					
																Drawing No: 86-16786-G001					
Plot Date: 28 October 2015 - 3:24 PM				Plotted by: Jay DeLapp				Cad File No: G:\86\16786\CADD\Drawings\Gen\86-16786-G001_Cover.dwg								Rev: 0					

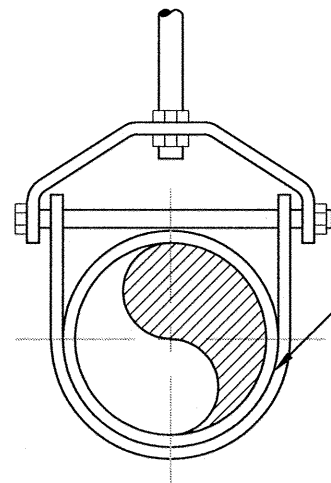


TYPE "A" PIPE SUPPORT
(REFER TO SECTION 15150)

NOT TO SCALE

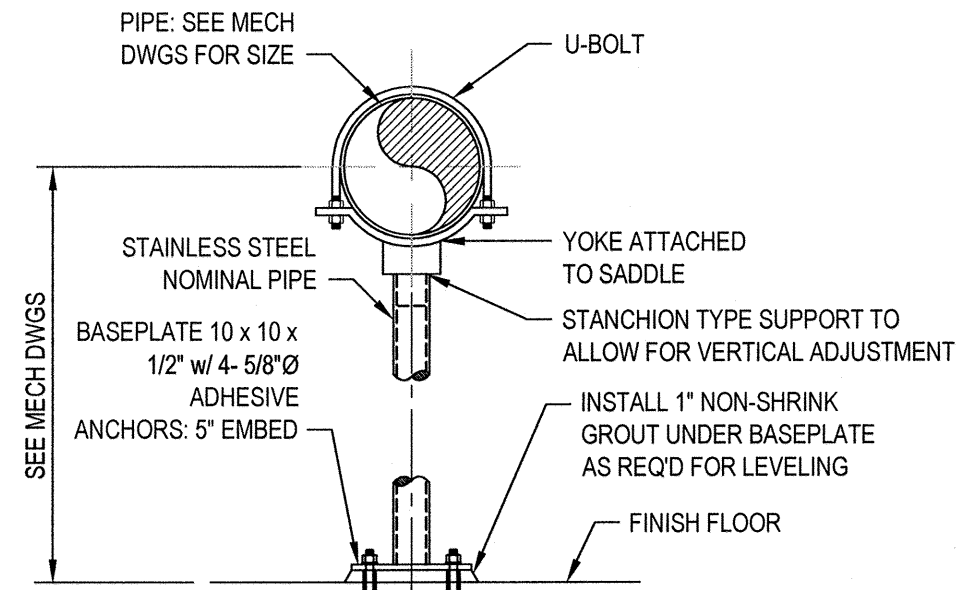


TYPE "B" PIPE SUPPORT

NOT TO SCALE

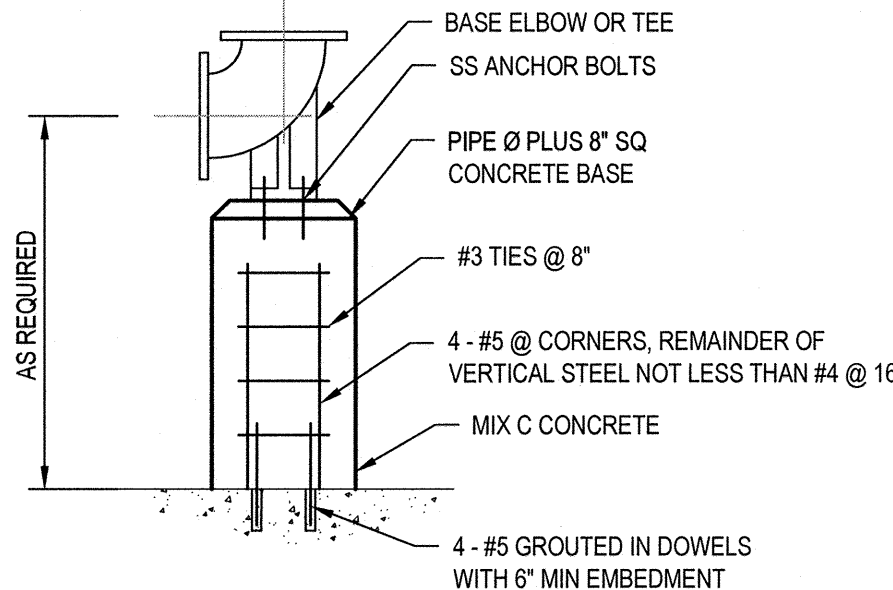


TYPE "F" PIPE SUPPORT

NOT TO SCALE

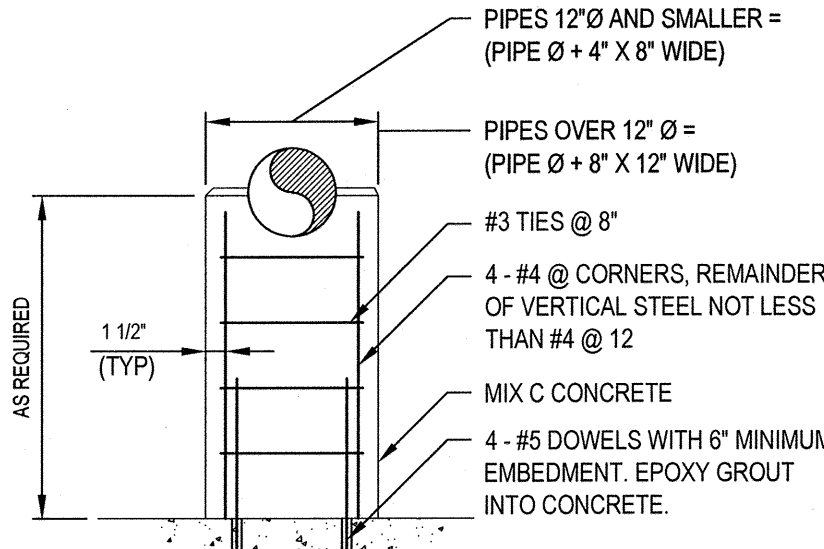

TYPE "G" PIPE SUPPORT


NOT TO SCALE

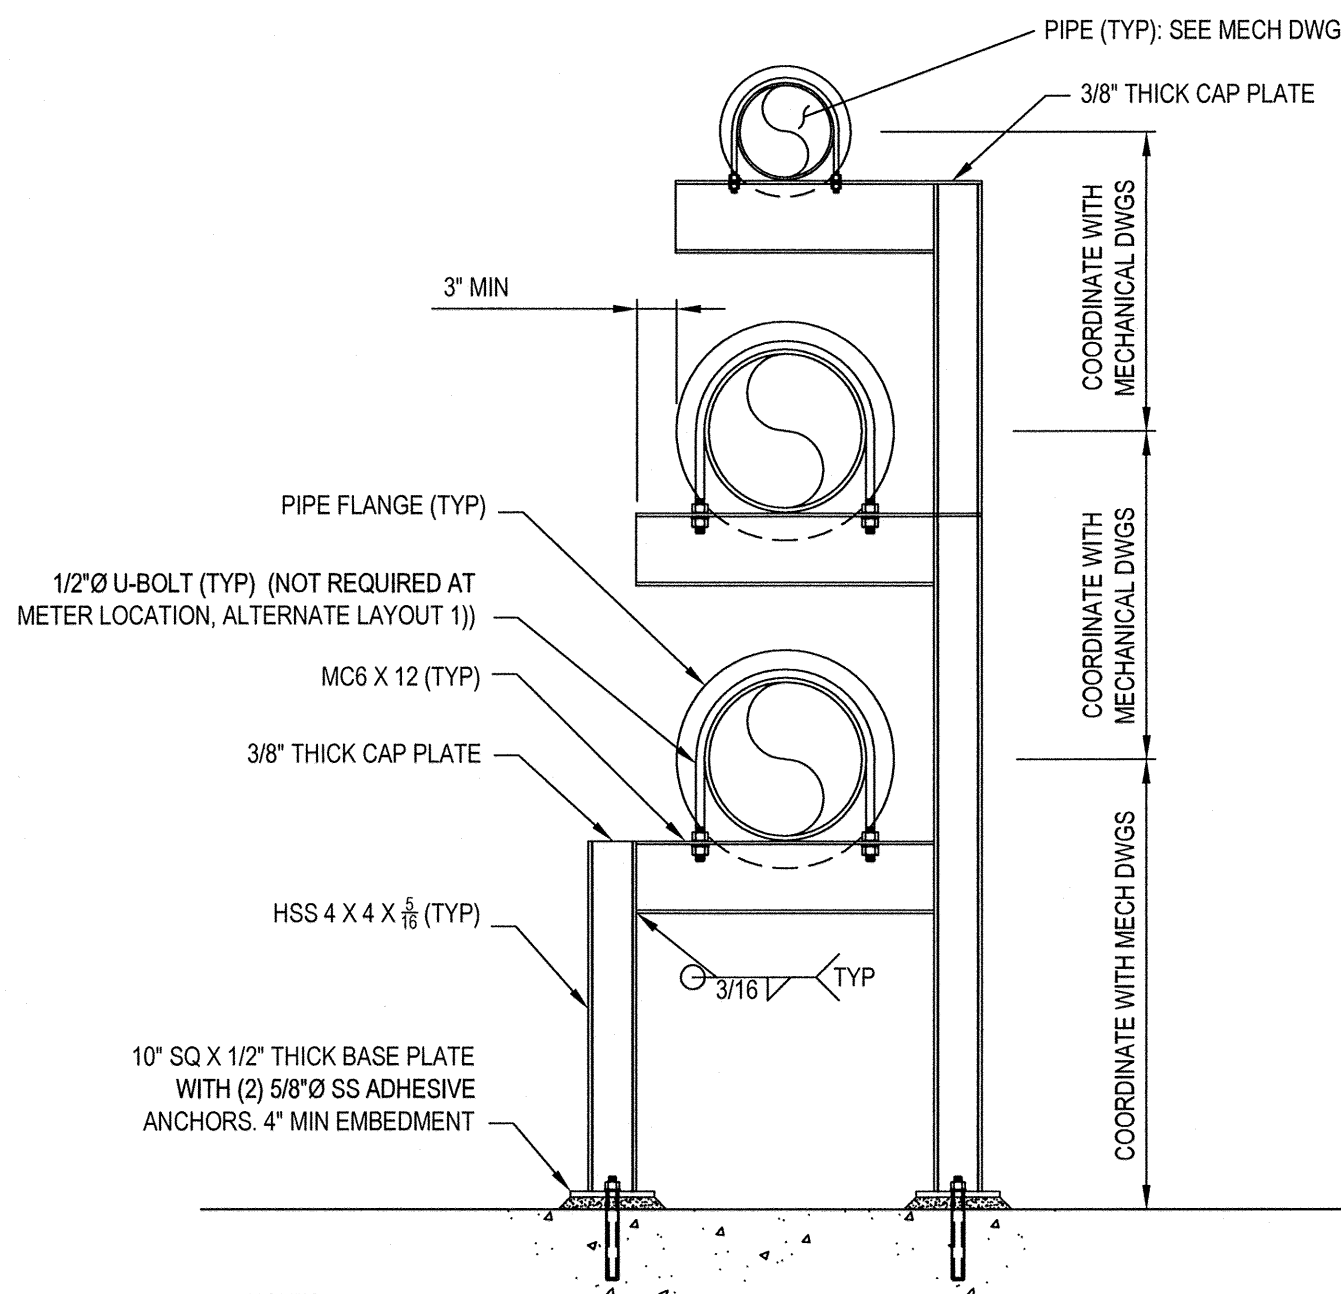

TYPE "H" PIPE SUPPORT


NOT TO SCALE

- NOTES:
- PIPE SUPPORT ASSEMBLY SHALL BE SHOP WELDED THEN HOT DIP GALVANIZED.
 - ALL BOLTS AND U-BOLTS SHALL BE STAINLESS STEEL.
 - SEE MECHANICAL PLAN AND SECTIONS FOR SUPPORT LOCATIONS.

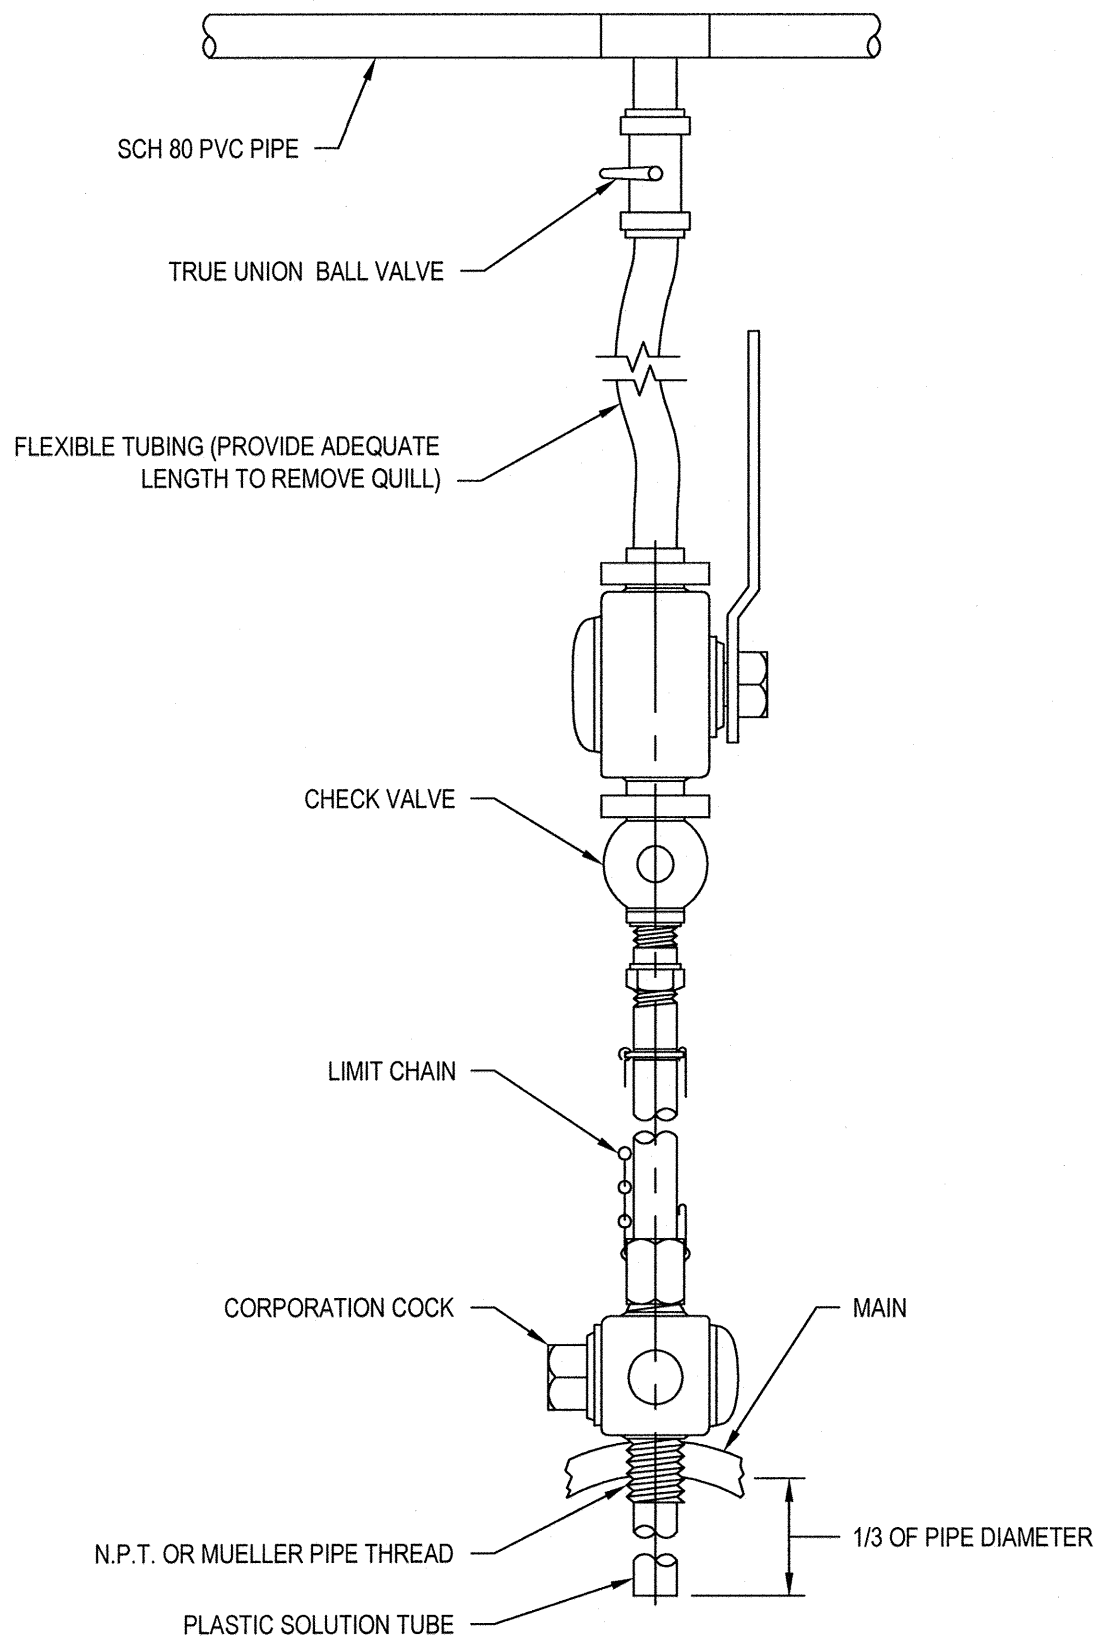

TYPICAL CHEMICAL FEED
CONNECTION DETAIL


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PIPE DRAIN DETAIL

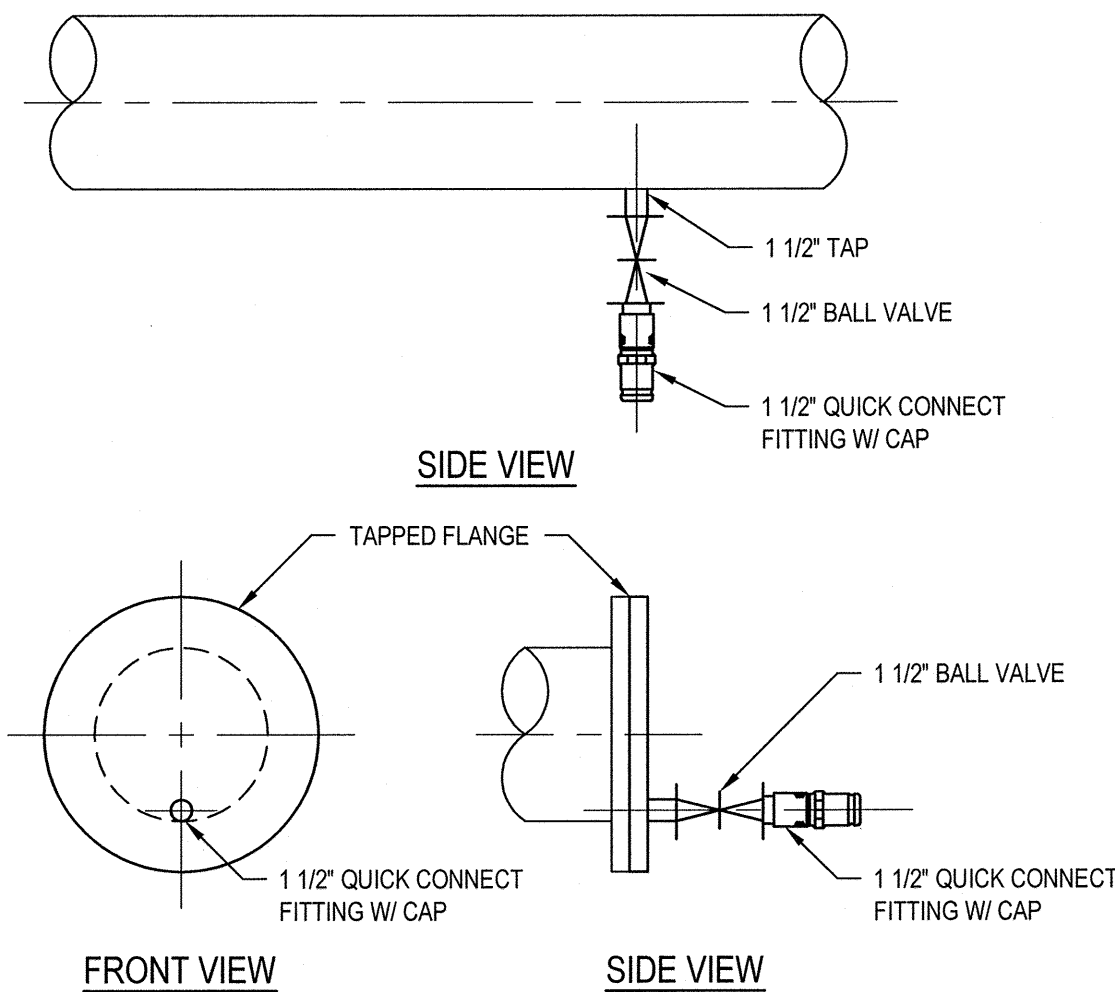
NOT TO SCALE

- NOTES:
- ALL TAPS UTILIZED FOR DRAINS SHALL BE 1 1/2" UNLESS NOTED OTHERWISE.
 - PROVIDE TAPPING SADDLE WHERE SHOWN ON DRAWINGS.



CHLORINE ANALYZER DETAIL

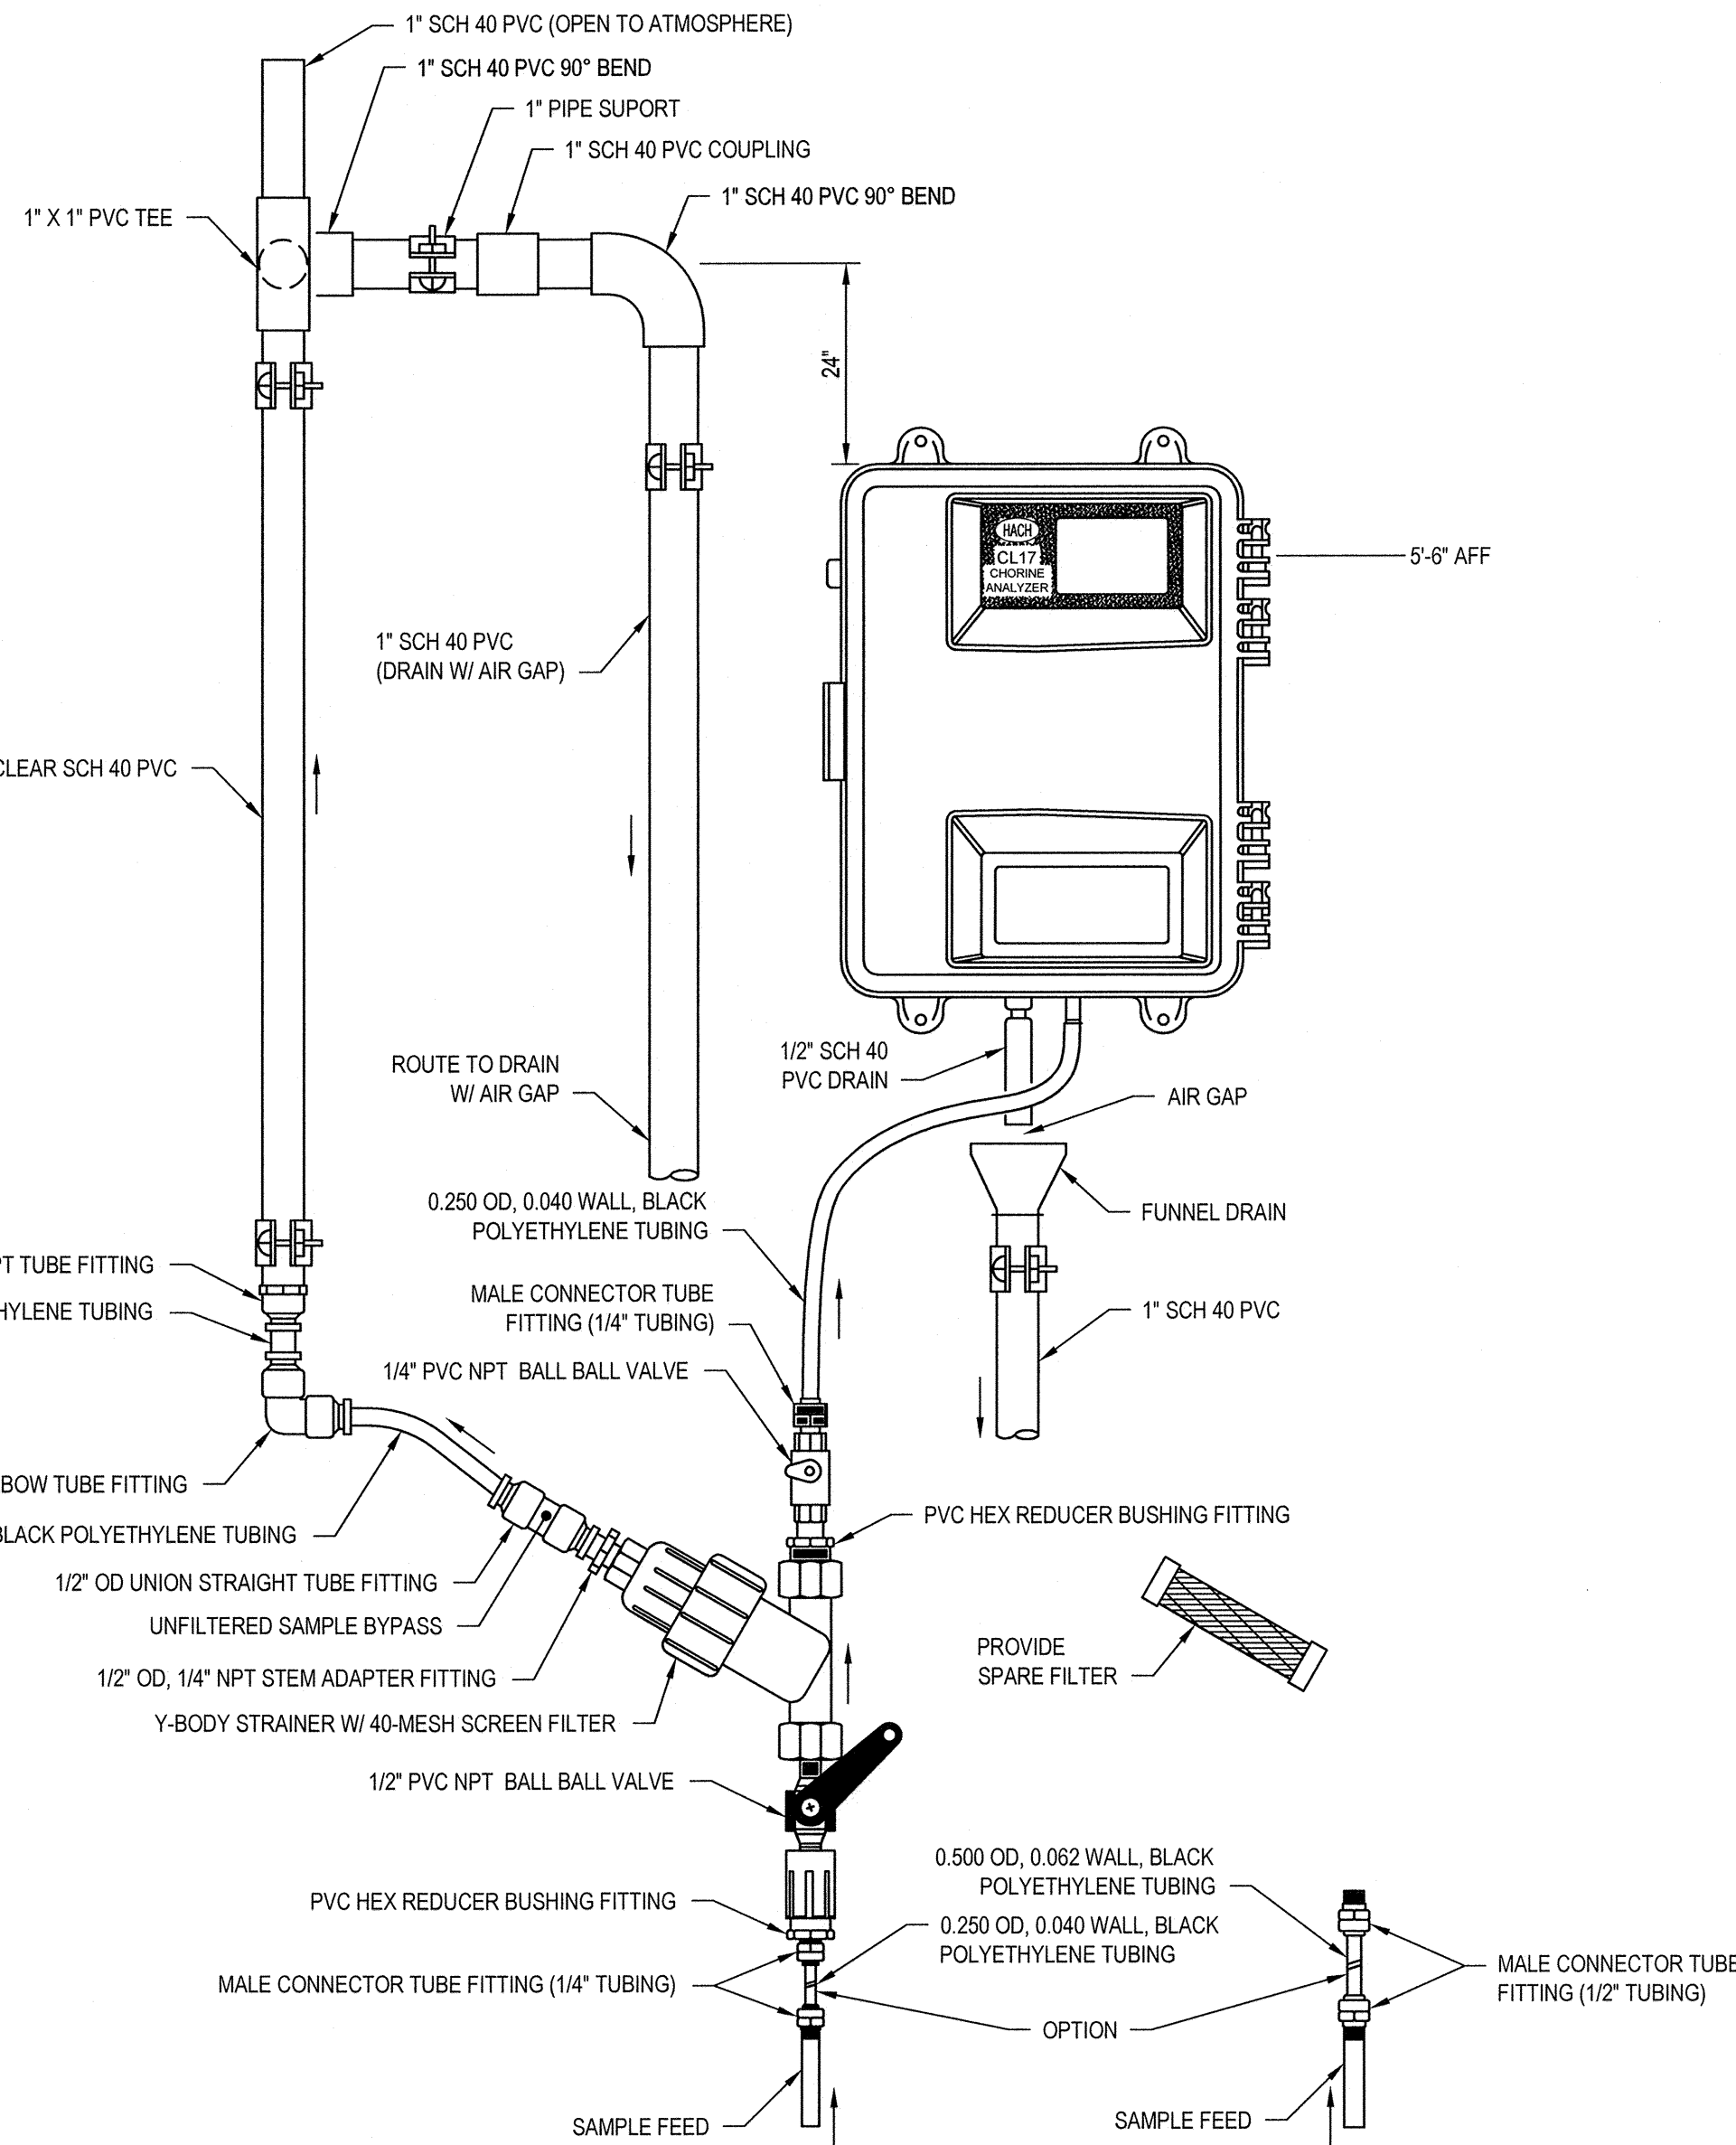NOT TO SCALE

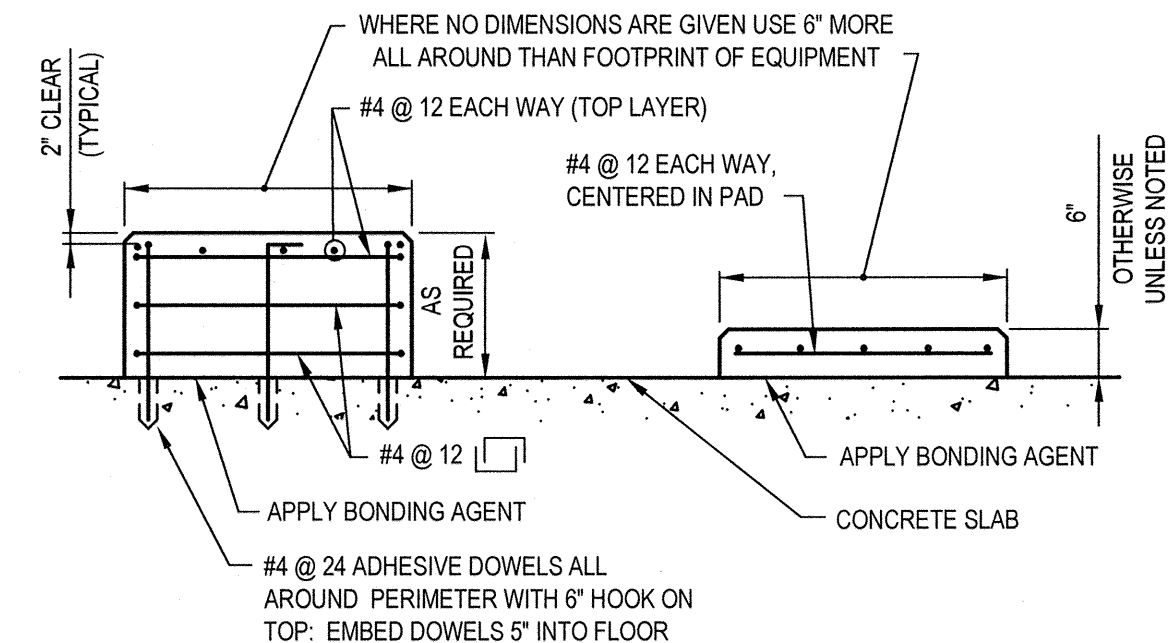


TYPICAL EQUIPMENT/PUMP PAD

HOUSEKEEPING PAD


REINFORCEMENT FOR CONCRETE PADS

NOT TO SCALE

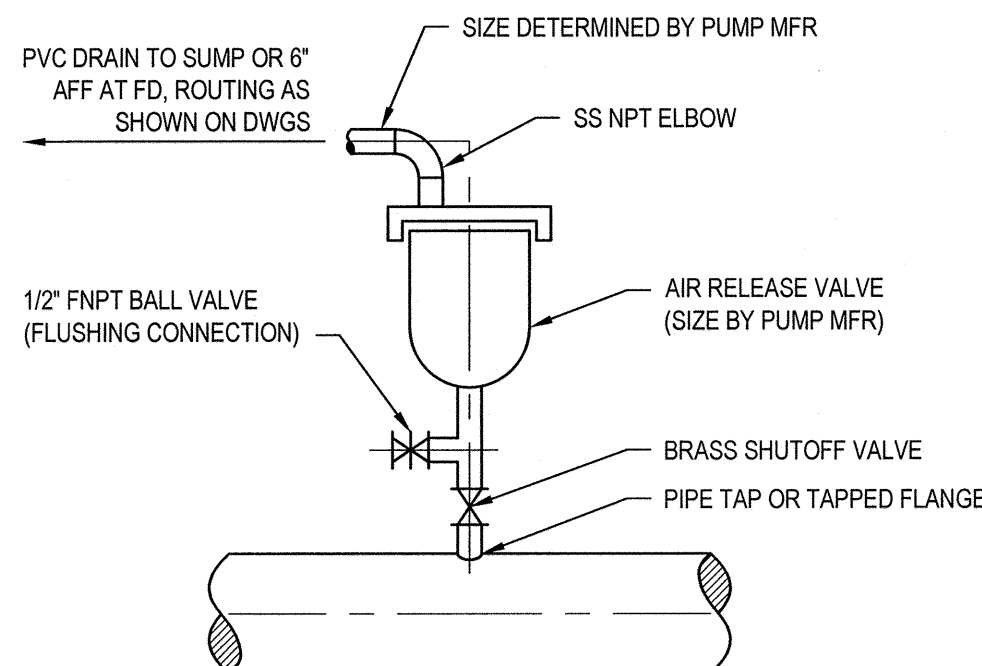

AIR RELEASE VALVE DETAIL


NOT TO SCALE

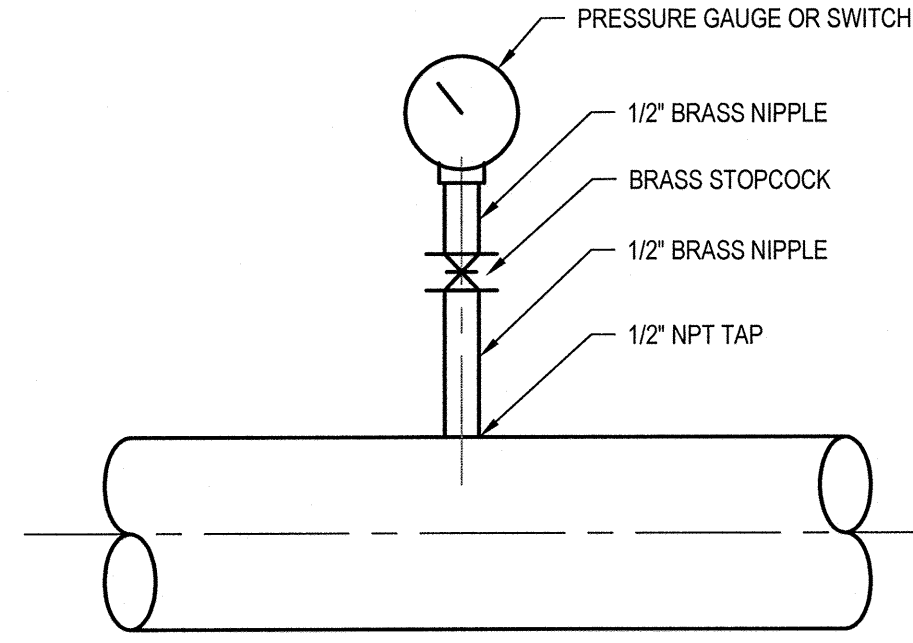

PRESSURE DEVICE MOUNTING DETAIL




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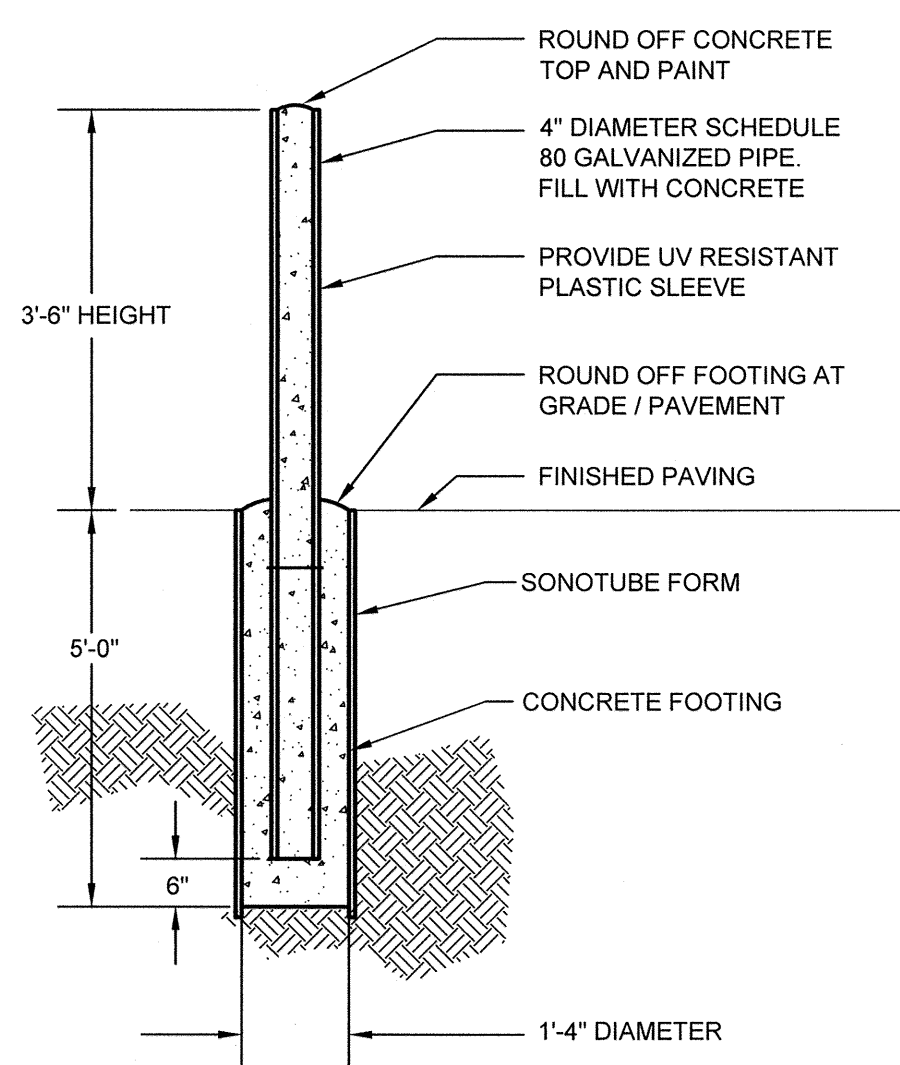
NOTE:
ALL TAPS UTILIZED FOR GAUGES SHALL BE 1/2" UNLESS NOTED OTHERWISE.

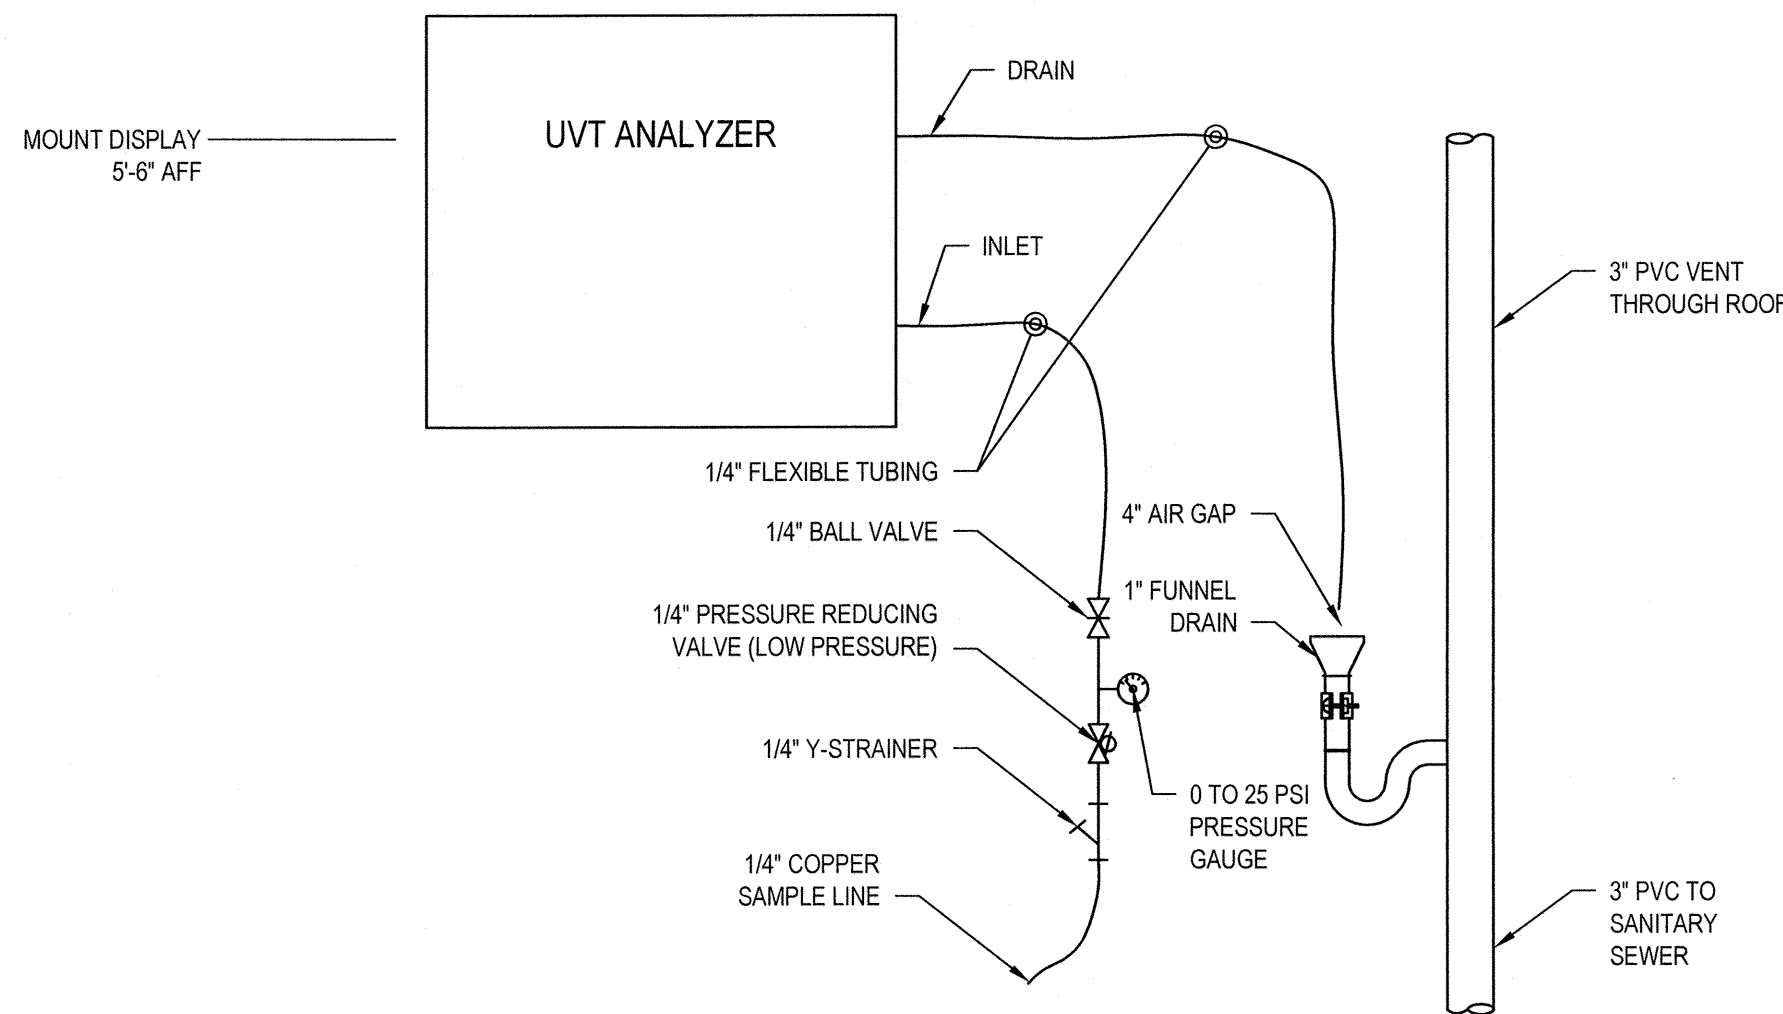



UVT ANALYZER SCHEMATIC

NOT TO SCALE


				NOTES:						GHD Consulting Services, Inc. One Remington Park Drive Cazenovia NY 13035 USA T 1 315 679 5800 F 1 315 679 5801 E cazmail@ghd.com W www.ghd.com	Drawn M YOUNG	Designer M YOUNG	Client TOWN OF NORTH CASTLE, NEW YORK			
				UNDERGROUND FACILITIES, STRUCTURES, AND UTILITIES HAVE BEEN PLOTTED FROM AVAILABLE SURVEYS AND RECORDS, AND THEREFORE THEIR LOCATIONS MUST BE CONSIDERED APPROXIMATE ONLY. THERE MAY BE OTHERS, THE EXISTENCE OF WHICH IS PRESENTLY NOT KNOWN.							Drafting Check <i>M. Young</i>	Design Check <i>M. Young</i>	Project NORTH BROADWAY ULTRAVIOLET DISINFECTION MISCELLANEOUS DETAILS			
0 FOR CONSTRUCTION				MRY	NJH	KC	10/15	IT IS VIOLATION OF NEW YORK STATE EDUCATION LAW FOR ANY PERSON UNLESS ACTING UNDER THE DIRECTION OF A LICENSED PROFESSIONAL ENGINEER, TO ALTER AN ITEM ON THIS DRAWING IN ANYWAY. IF AN ITEM IS ALTERED, THE ALTERING ENGINEER SHALL AFFIX TO THE ITEM HIS/HER SEAL AND THE NOTATION "ALTERED BY" FOLLOWED BY HIS/HER SIGNATURE AND DATE OF SUCH ALTERATION AND A SPECIFIC DESCRIPTION OF THE ALTERATION.		Approved (Project Director) <i>Kevin Castelli</i>	Contract No. 1	Title				
No	Revision	Note: * indicates signatures on original issue of drawing or last revision of drawing			Drawn	Job Manager	Project Director			Date	Date 10/30/15	Scale NONE	This Drawing shall not be used for Construction unless Signed and Sealed For Construction	Original Size Arch D	Drawing No: 86-16786-G004	Rev: 0
Plot Date: 28 October 2015 - 3:26 PM					Plotted by: Jay DeLapp					Cad File No: G:\86\16786\CADD\Drawings\Gen\86-16786_Misc Details.dwg						




TYPICAL BOLLARD DETAIL
NOT TO SCALE

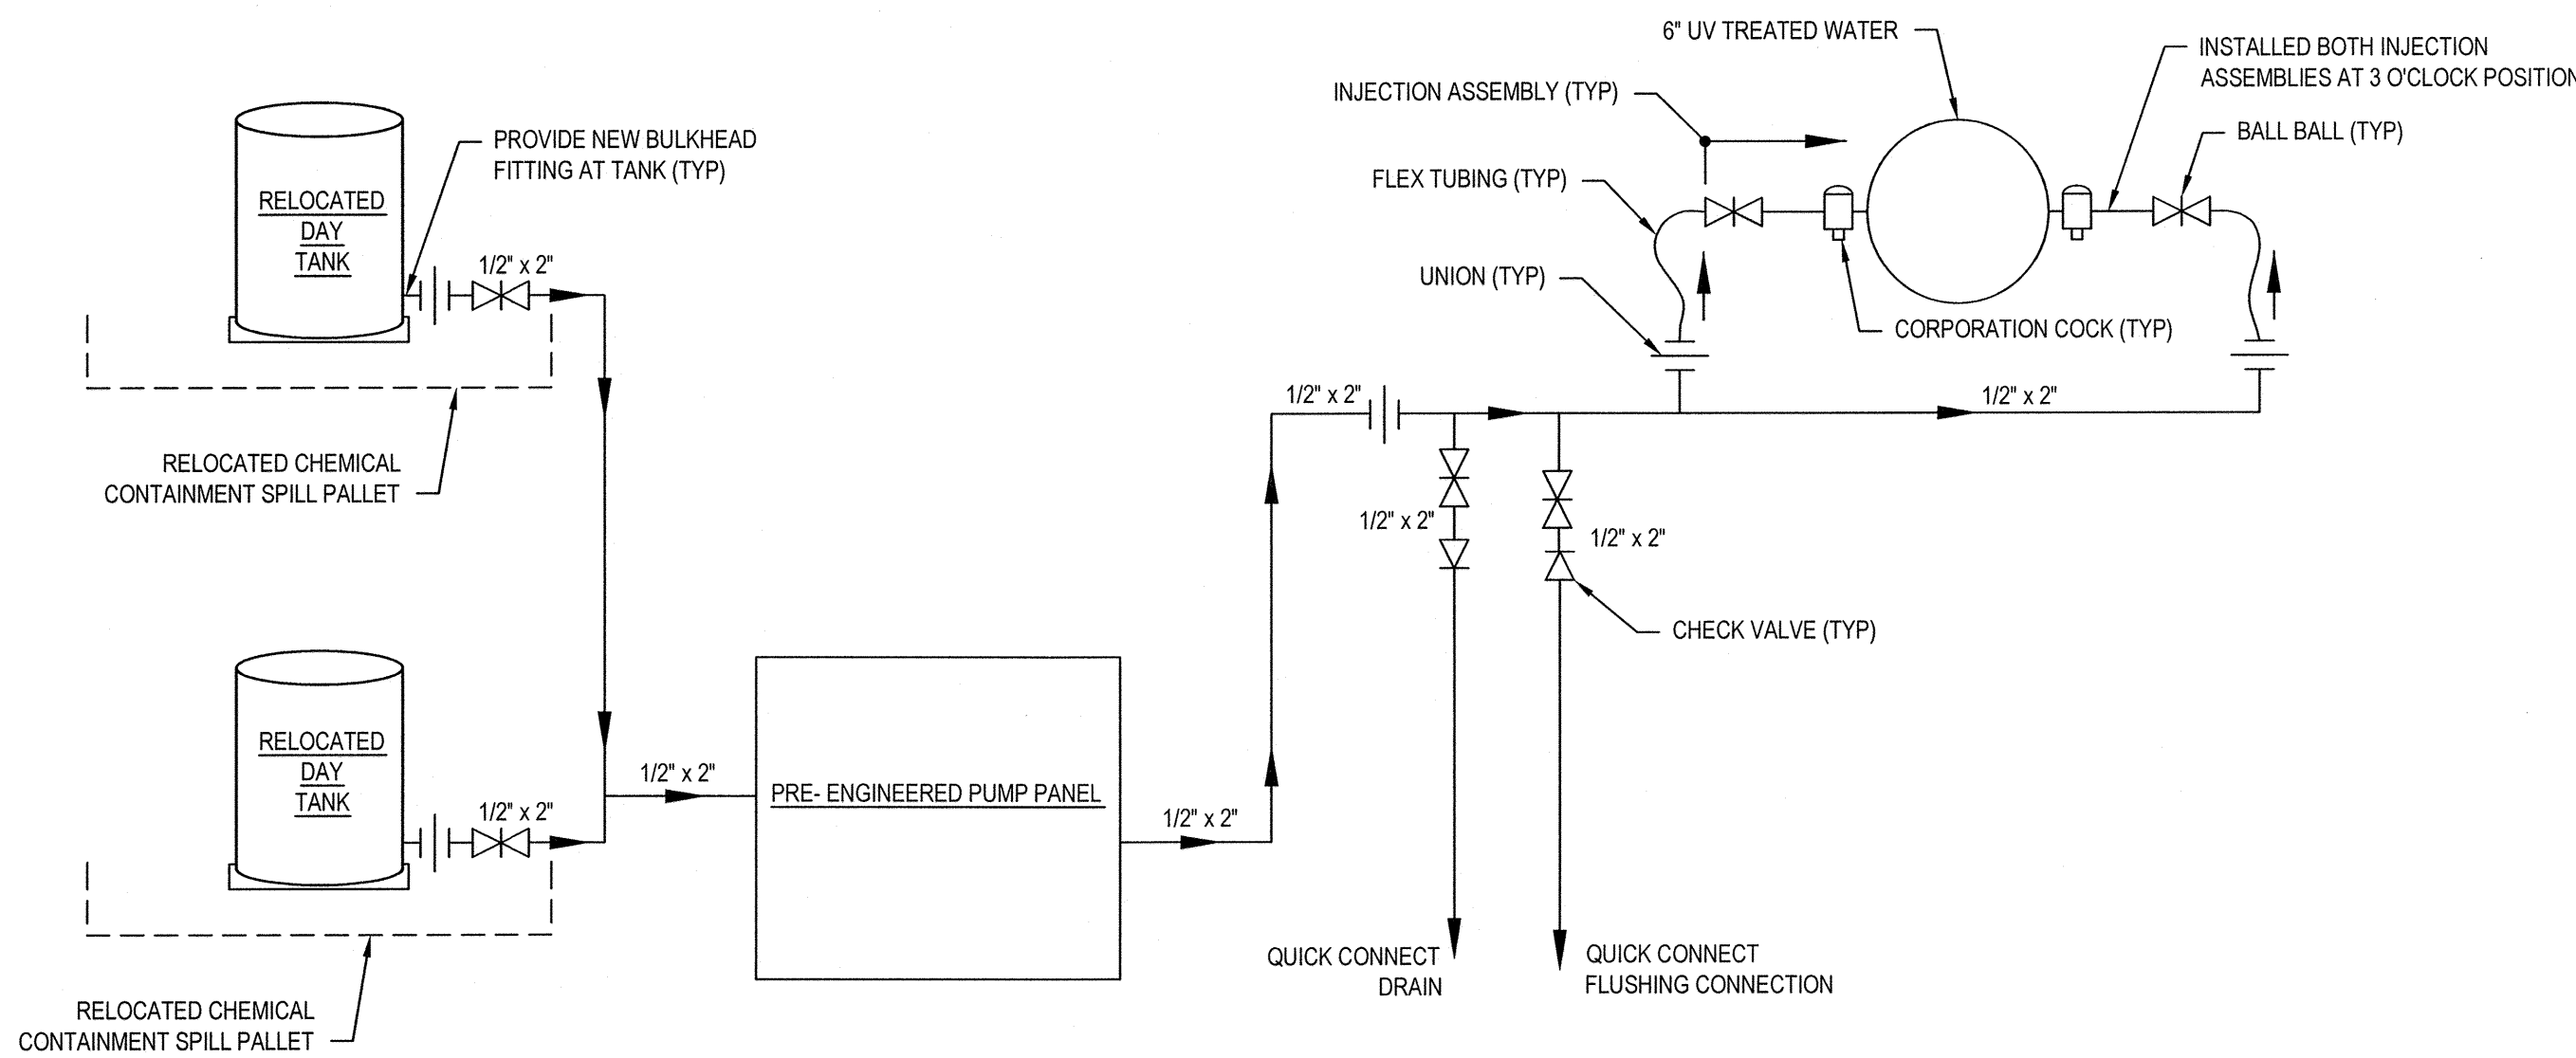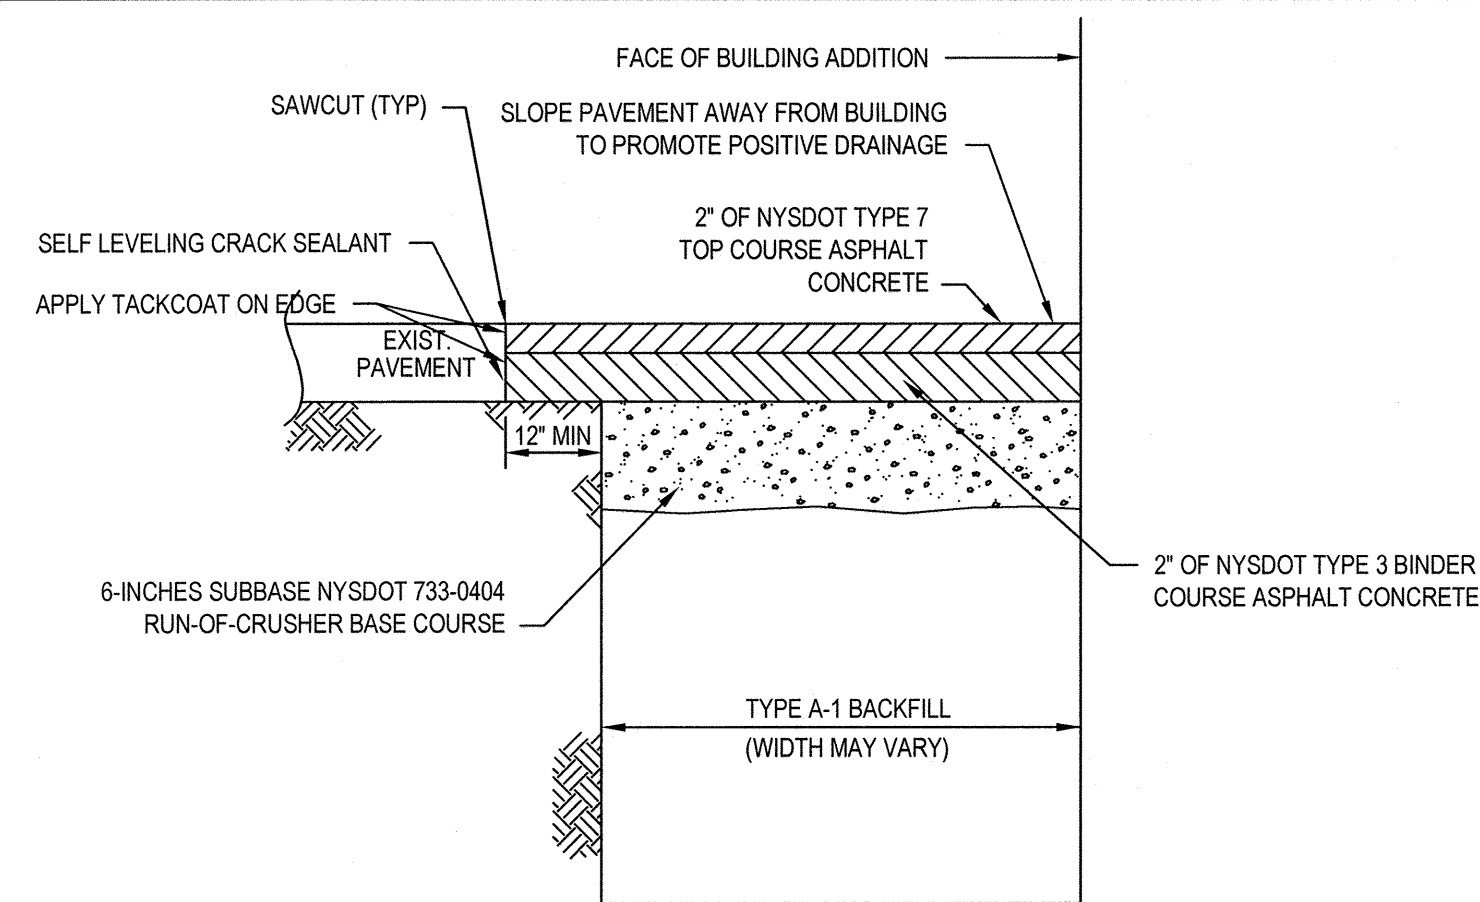

CHLORINE FEED SCHEMATIC
NOT TO SCALE

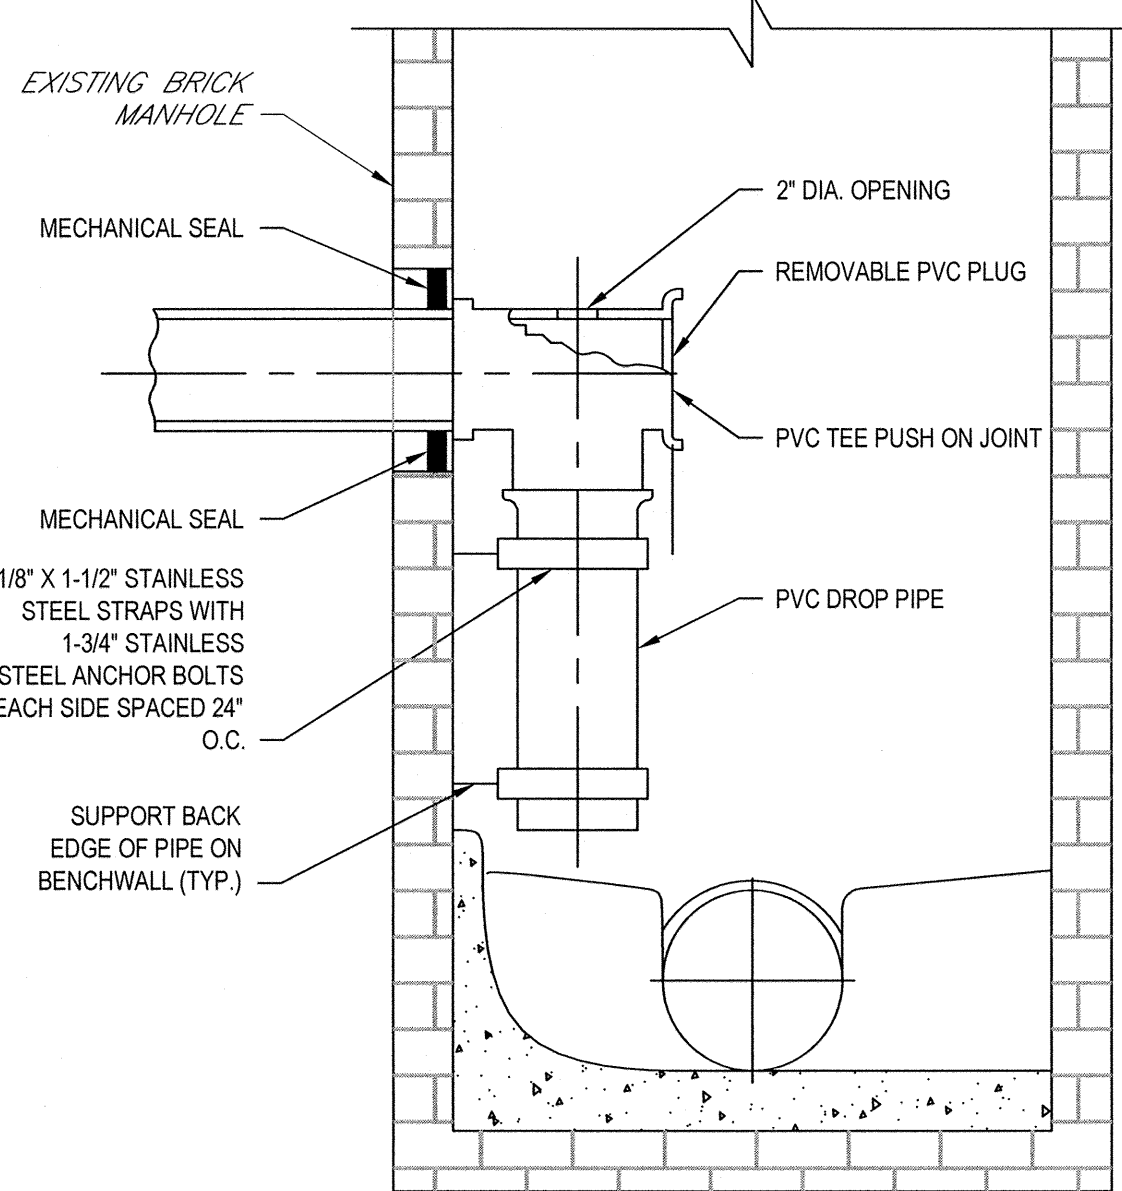


DROP MANHOLE DETAIL
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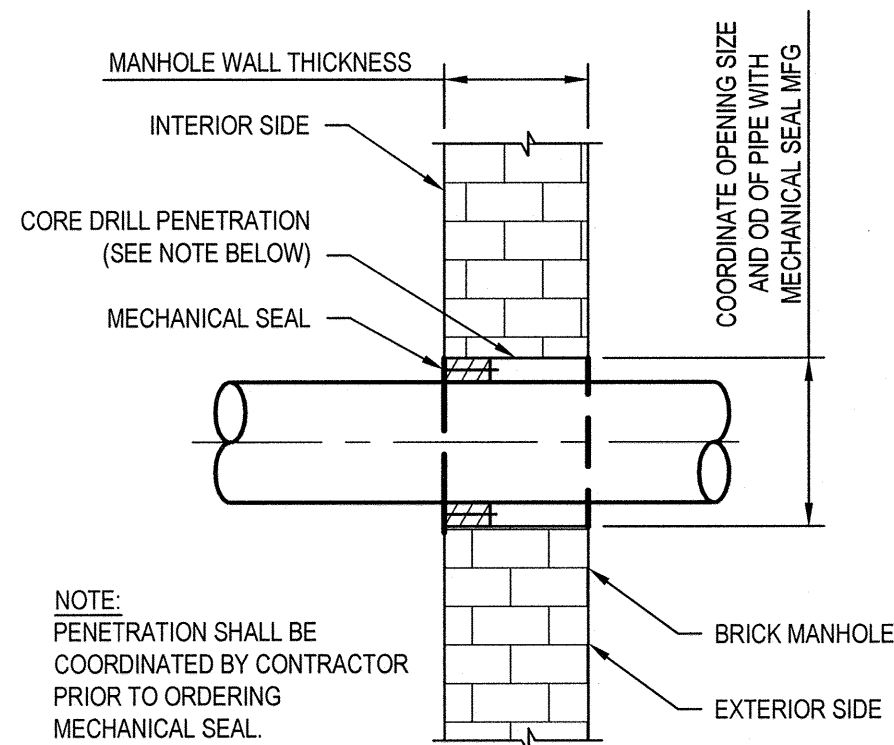


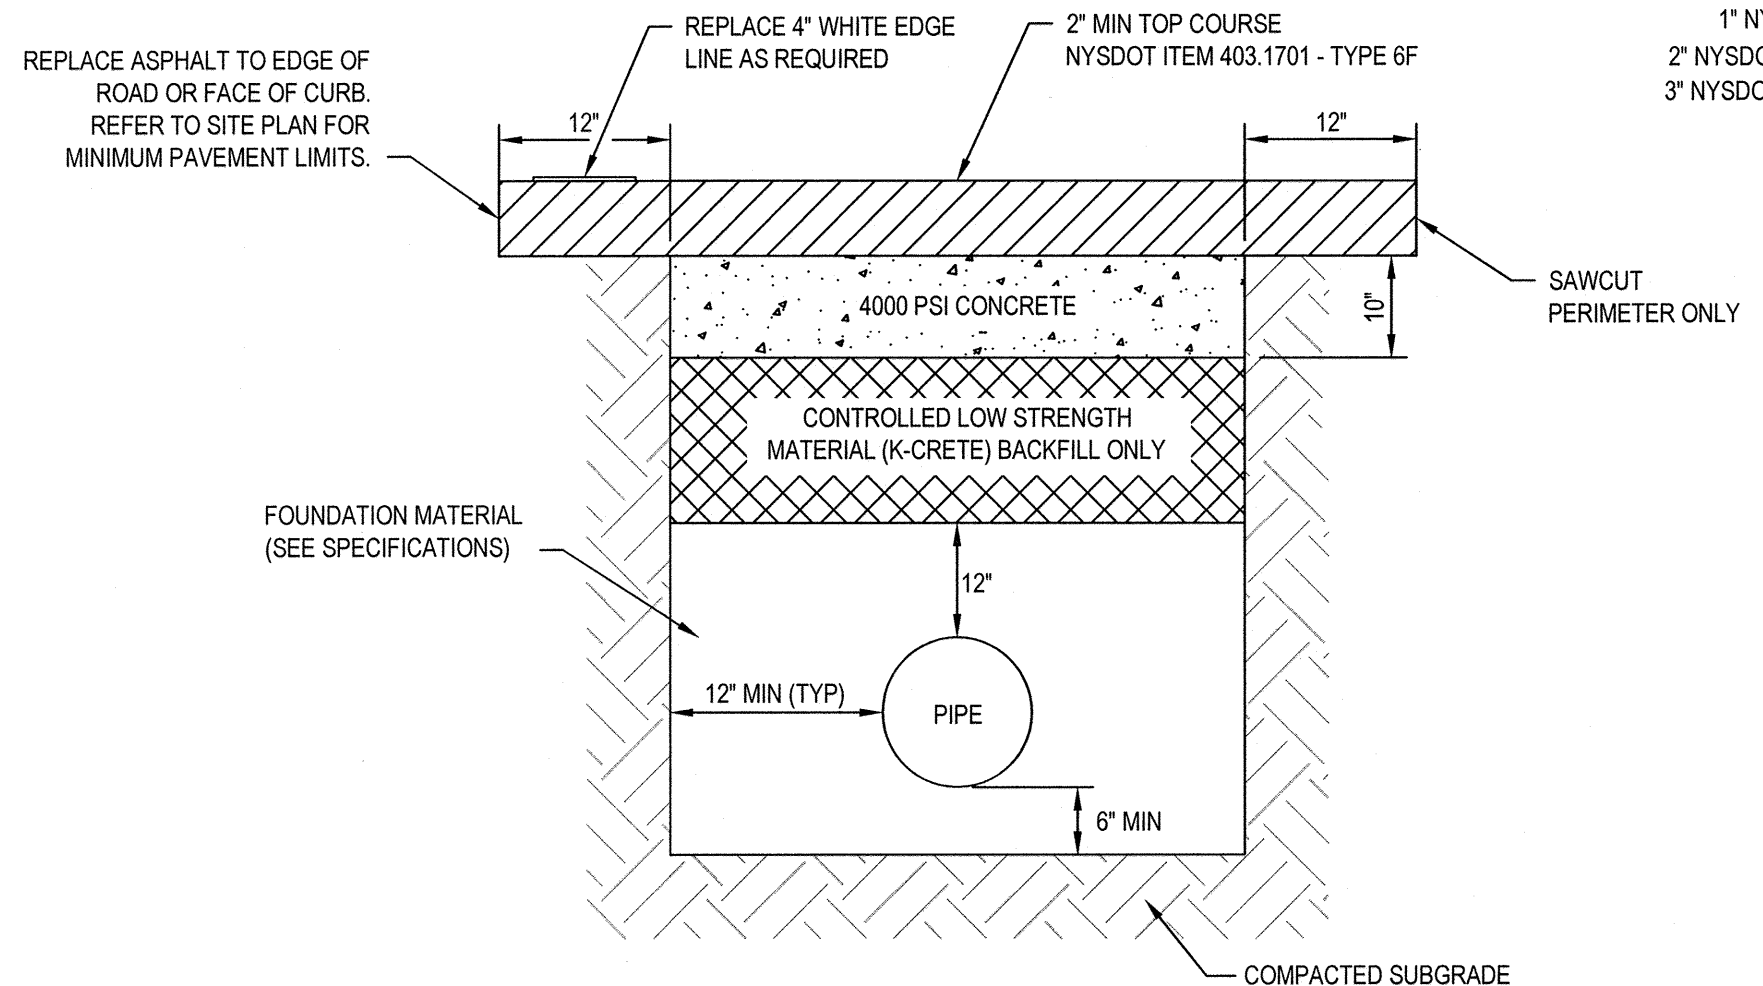- NOTES:**
- TEMPORARY PAVEMENT REPLACEMENT WILL BE ALLOWED ONLY WHEN ASPHALT PLANTS ARE NOT IN OPERATION OR AS DIRECTED. TEMPORARY PAVEMENT SHALL BE 4" OF BINDER COURSE NYSDOT 402.256902 IN LIEU OF TOP COURSE AS SHOWN. CONTRACTOR SHALL BE RESPONSIBLE FOR MAINTENANCE AND UPKEEP OF SAID PATCH UNTIL PERMANENT PATCH IS INSTALLED.
 - UPON THE AVAILABILITY OF ASPHALT, THE CONTRACTOR SHALL EXCAVATE THE "K-CRETE" BACKFILL TO THE ORDER DEPTH AND REPLACEMENT WITH 4000 PSI CONCRETE AND THE REQUIRED 2" THICK ASPHALT TO THE LIMITS AND SPECIFICATIONS SHOWN.
 - STEEL PLATES OF ADEQUATE SIZE SHALL BE PLACED OVER ALL TRENCHES UNTIL THE 4000 PSI CONCRETE PLUG IS DEEMED PASSABLE.
 - STEEL PLATES SHALL BE PINNED AS REQUIRED TO PREVENT MOVEMENT. DURING WINTER ALL STEEL PLATES SHALL BE RECESSED.
 - USE THIS DETAIL FOR WORK IN COUNTY HIGHWAY 29.


PERMANENT PAVEMENT REPLACEMENT - COUNTY ROAD
NOT TO SCALE

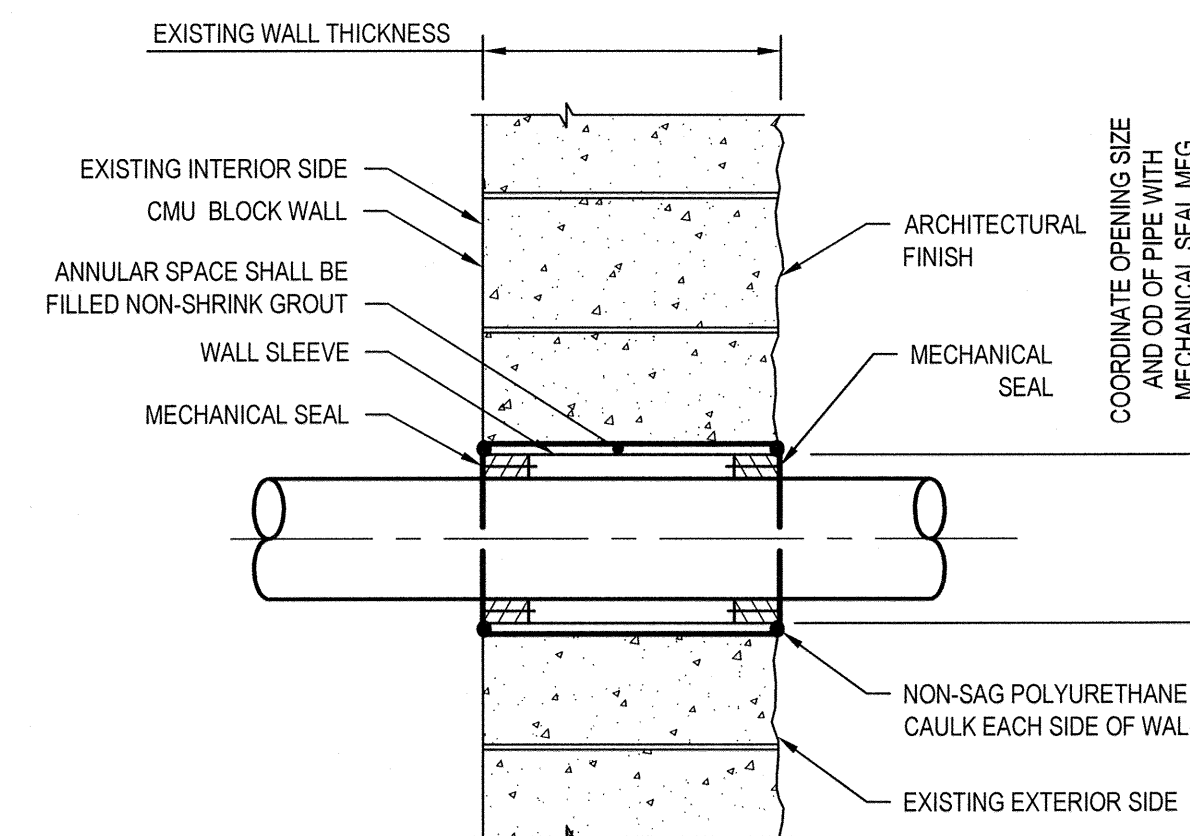

TYPICAL WALL SLEEVE DETAIL
EXISTING STRUCTURE
NOT TO SCALE




TYPICAL PENETRATION DETAIL
BRICK STRUCTURE
NOT TO SCALE

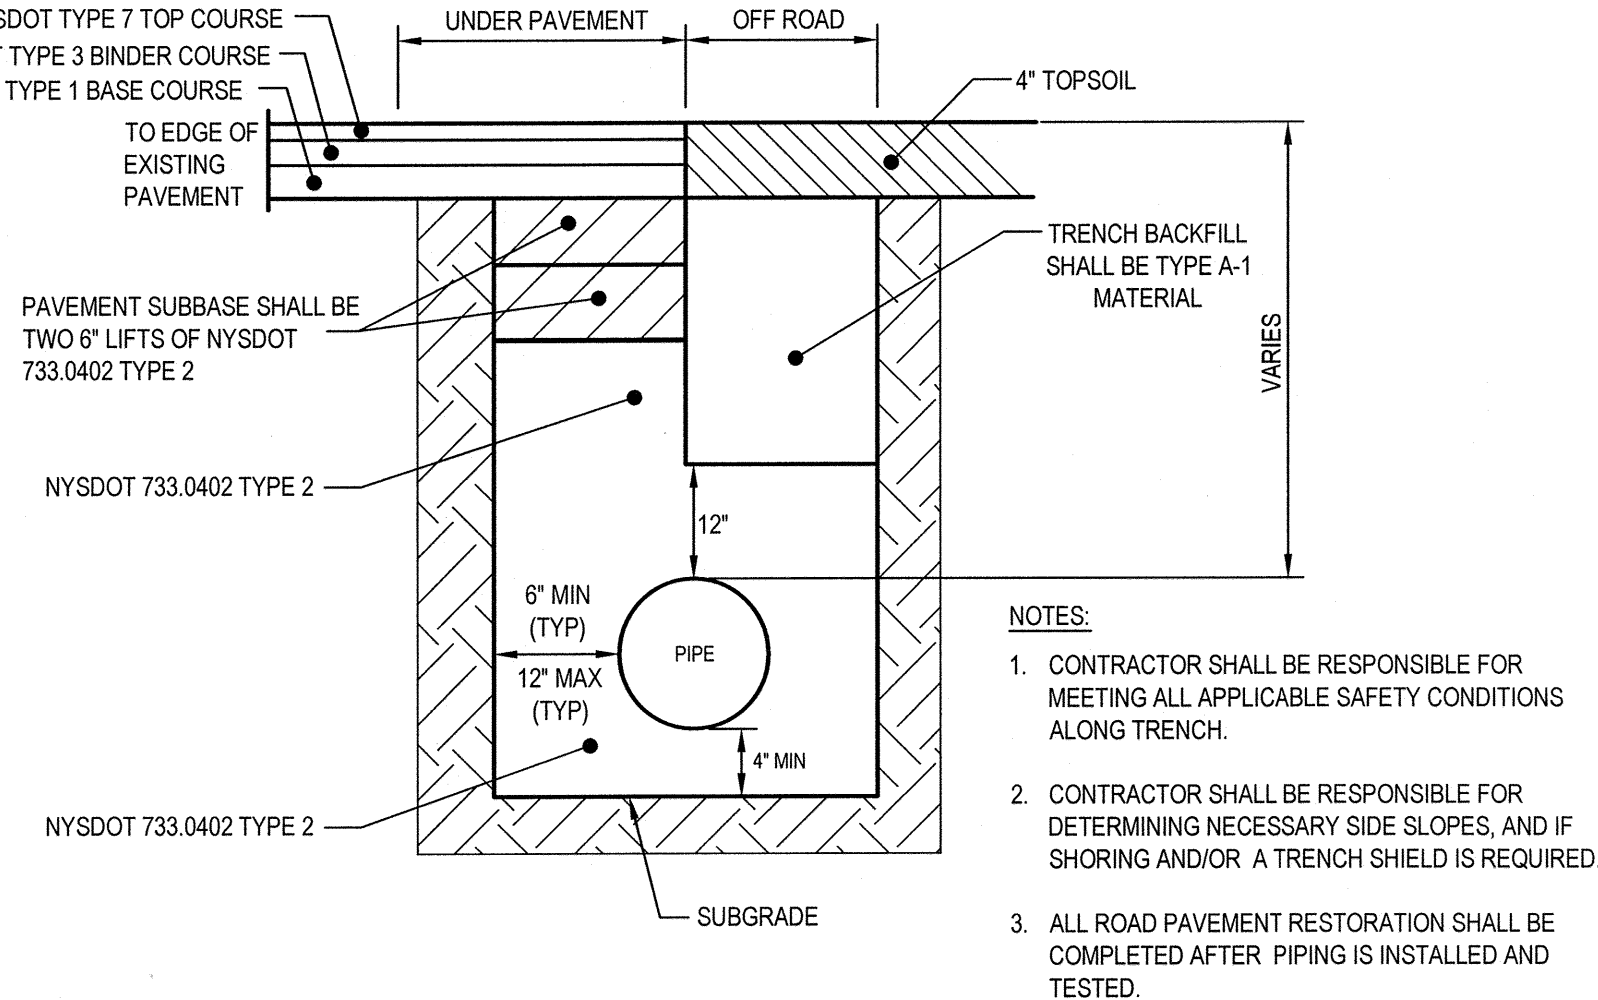

- NOTES:**
- CONTRACTOR SHALL BE RESPONSIBLE FOR MEETING ALL APPLICABLE SAFETY CONDITIONS ALONG TRENCH.
 - CONTRACTOR SHALL BE RESPONSIBLE FOR DETERMINING NECESSARY SIDE SLOPES, AND IF SHORING AND/OR A TRENCH SHIELD IS REQUIRED.
 - ALL ROAD PAVEMENT RESTORATION SHALL BE COMPLETED AFTER PIPING IS INSTALLED AND TESTED.


NORMAL SOIL CONDITIONS
TRENCH & PAVEMENT RESTORATION DETAIL
NOT TO SCALE

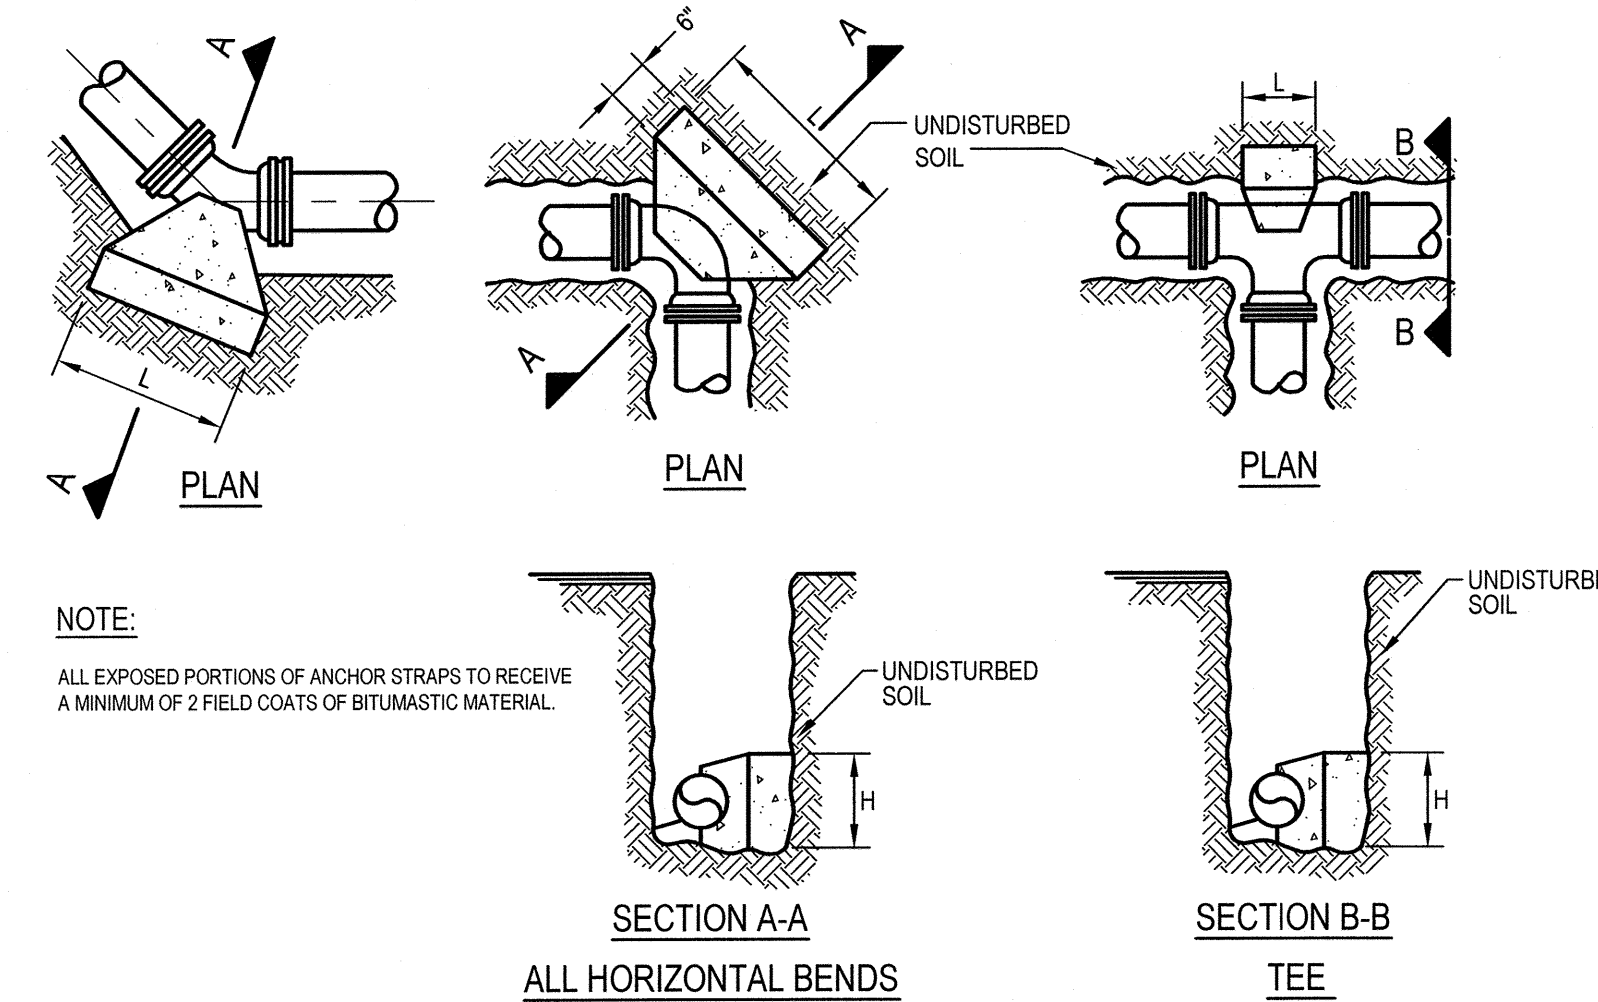

HORIZONTAL ANCHOR DIMENSIONS
FOR AVERAGE SOIL CONDITIONS

UP TO 150 P.S.I. WORKING PRESSURE											
PIPE SIZE	PLUG, CAP, TEE OR TAP SLEEVE		90° BEND		45° BEND		22 1/2° BEND		11 1/4° BEND		
	H	L	H	L	H	L	H	L	H	L	
6"	1'-0"	2'-0"	1'-0"	2'-0"	1'-0"	1'-4"	0'-9"	1'-0"	0'-6"	1'-0"	

THRUSTBLOCK DETAIL
NOT TO SCALE

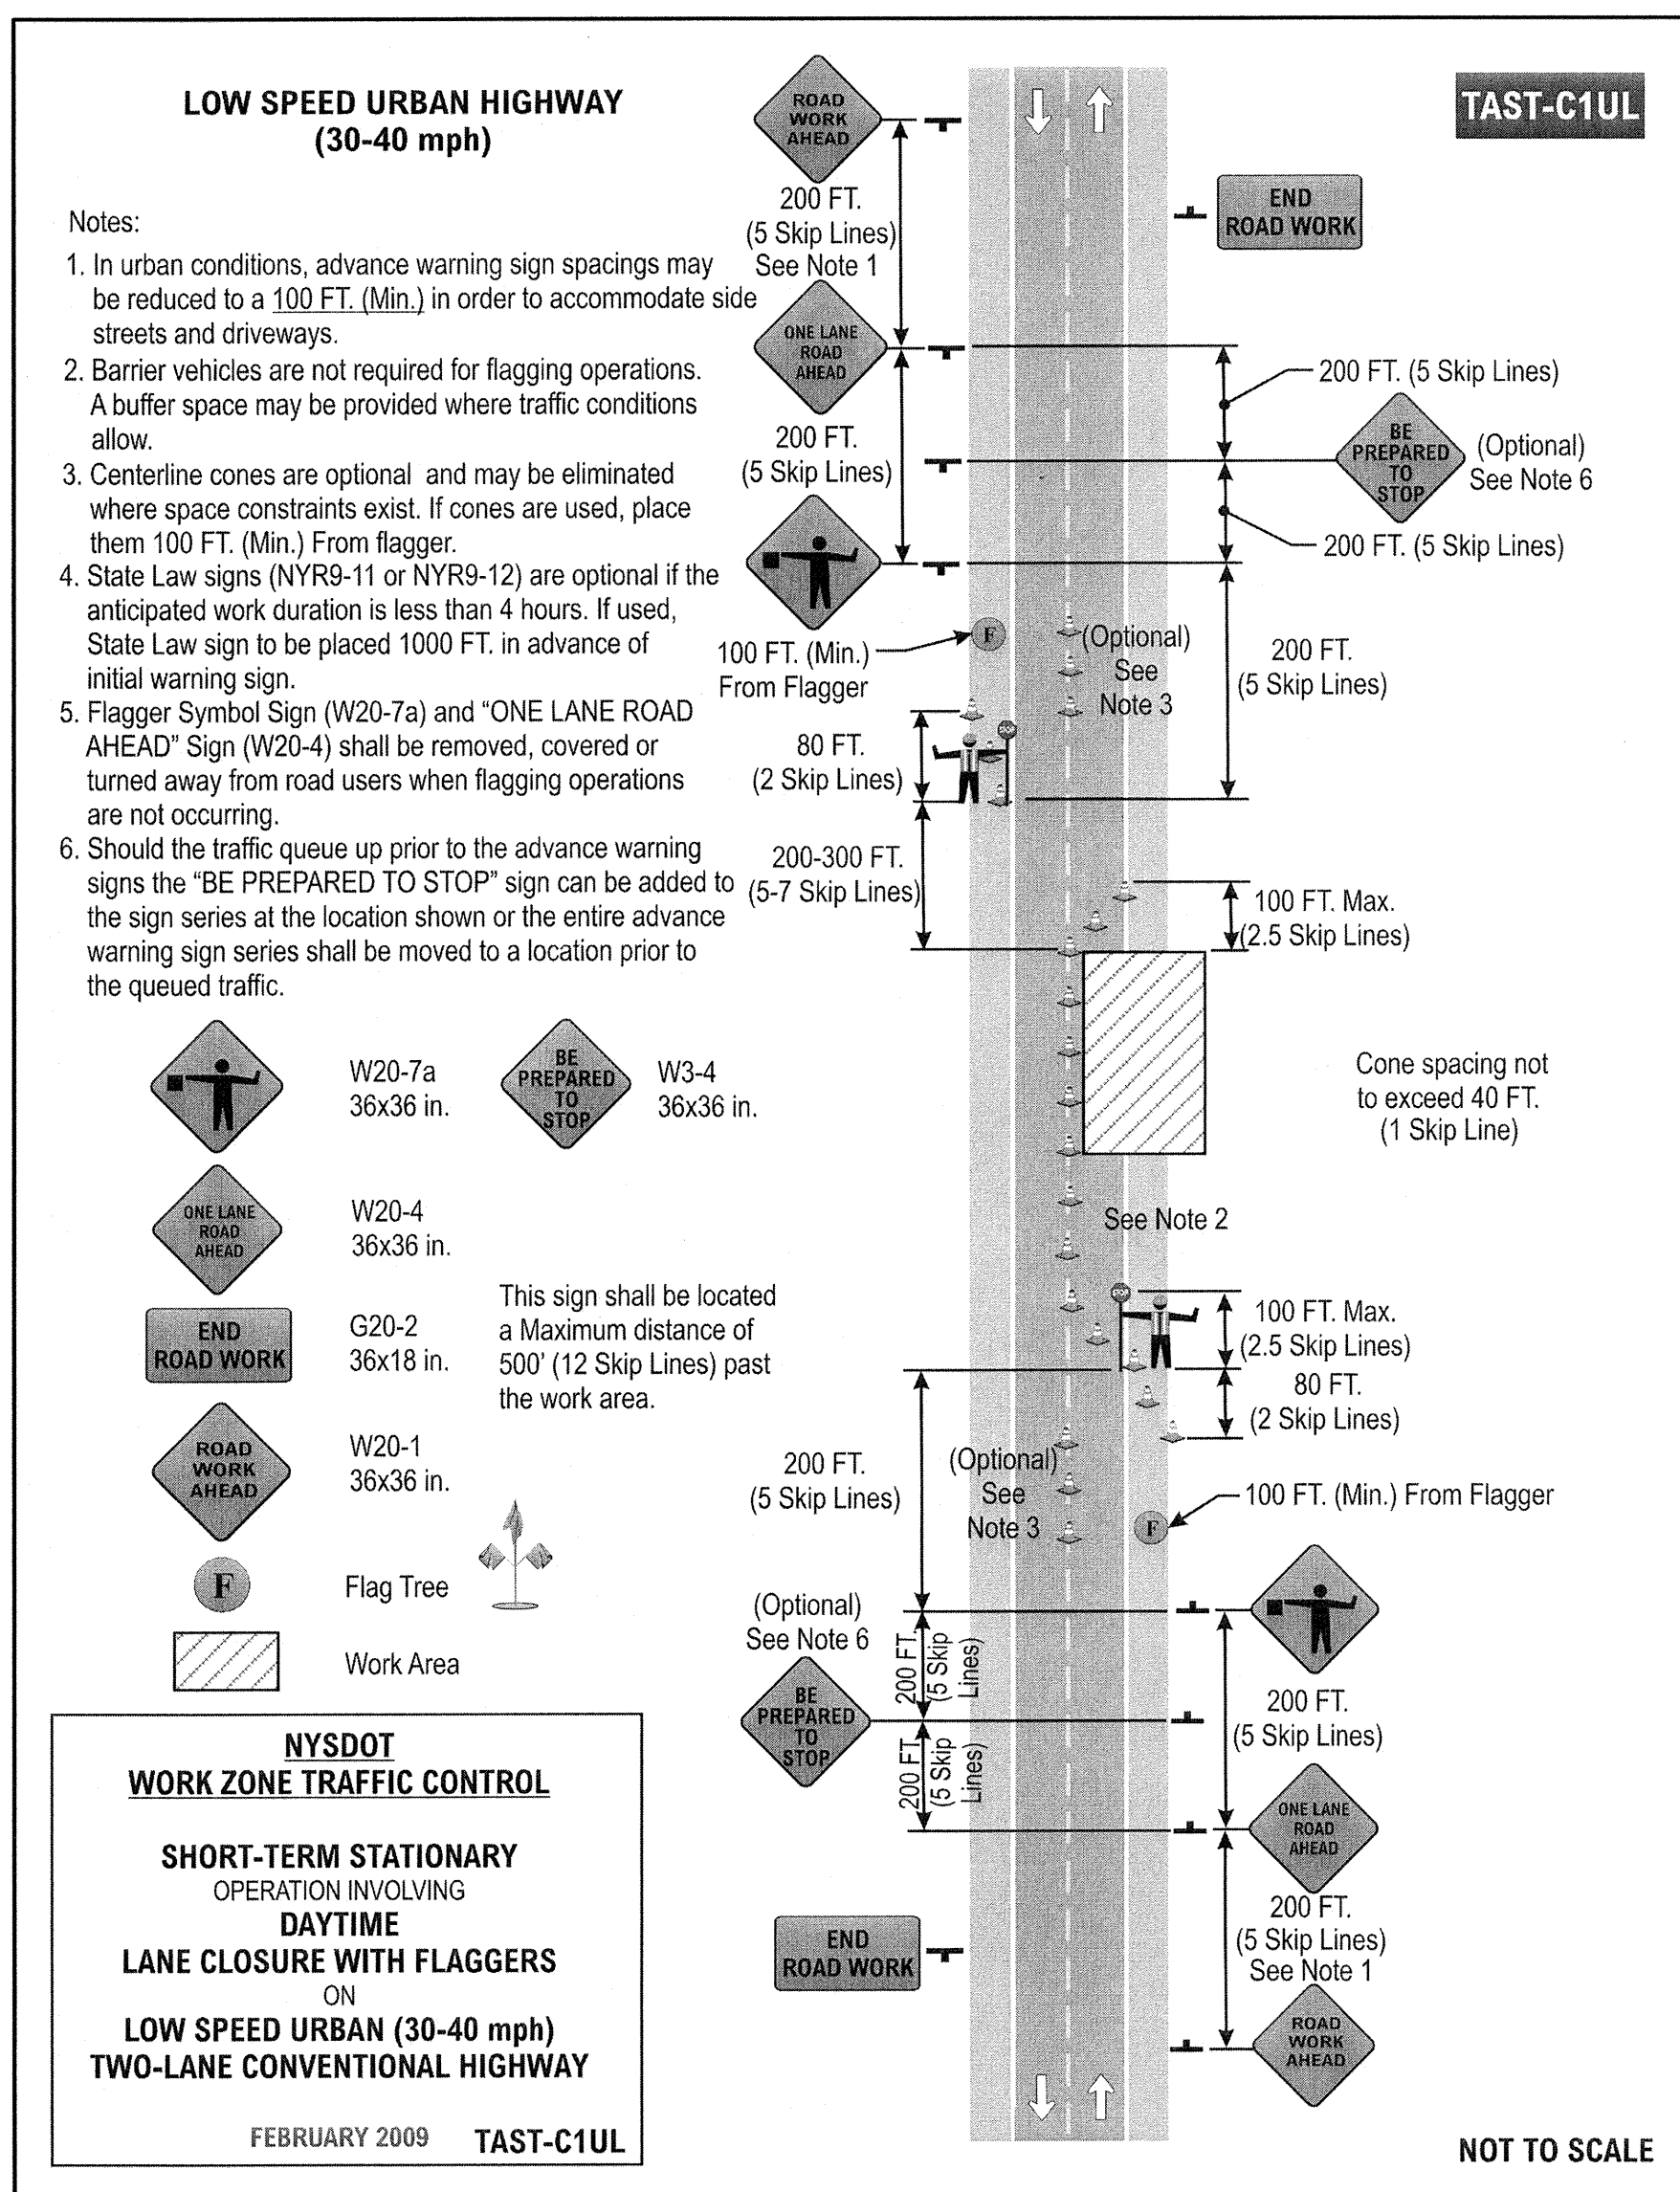

TRAFFIC CONTROL DETAIL
NOT TO SCALE

								<p>NOTES:</p> <p>UNDERGROUND FACILITIES, STRUCTURES, AND UTILITIES HAVE BEEN PLOTTED FROM AVAILABLE SURVEYS AND RECORDS, AND THEREFORE THEIR LOCATIONS MUST BE CONSIDERED APPROXIMATE ONLY. THERE MAY BE OTHERS, THE EXISTENCE OF WHICH IS PRESENTLY NOT KNOWN.</p>			
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0 FOR CONSTRUCTION				MRY	NJH	KC	10/15				
No	Revision	Note: * indicates signatures on original issue of drawing or last revision of drawing		Drawn	Job Manager	Project Director	Date				
Plot Date: 28 October 2015 - 3:27 PM				Plotted by: Jay DeLapp				Cad File No: G:\9816786\CADD\Drawings\Gen\86-16786_Misc Details.dwg			

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Professional Engineer

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Drawn M YOUNG Designer M YOUNG

Drafting Check *M. Young* Design Check *M. Young*

Approved (Project Director) *Kevin Castelli*

Date 10/30/15 Contract No. 1

Scale NONE

Client **TOWN OF NORTH CASTLE, NEW YORK**

Project **NORTH BROADWAY**

Title **ULTRAVIOLET DISINFECTION**

MISCELLANEOUS DETAILS


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Drawing No: **86-16786-G005**

Rev: **0**



FAN SCHEDULE												
EQUIPMENT TYPE		FAN					ELECTRICAL		CONTROLS	DESIGN BASIS	NOTES	
		UNIT ID	DRIVE	CFM	EXT SP (" WG)	RPM	INLET dBA	HP	RPM	VOLTS/ PHASE		CONTROLLED BY
F-1	CENTRIFUGAL SIDEWALL EXHAUST FAN	DIRECT	300	0.25	1,648	50	1/8	1,725	120/1	ON/OFF SWITCH	GREENHECK, CW-070-V.G	1

GAS UNIT HEATER SCHEDULE										
UNIT ID	ROOM SERVED	EQUIPMENT TYPE	HEATING DATA			MOTOR DATA			DESIGN BASIS	NOTES
			MBH OUTPUT	CFM	HEAT THROW (FT)	HP	RPM	VOLTS/ PHASE	MANUFACTURER, MODEL	
UH-1	BUILDING ADDITION	SEPARATED COMBUSTION GAS FIRED	24.8	450	26	0.06	1,550	120/1	REZVOR, UDA5-30	2

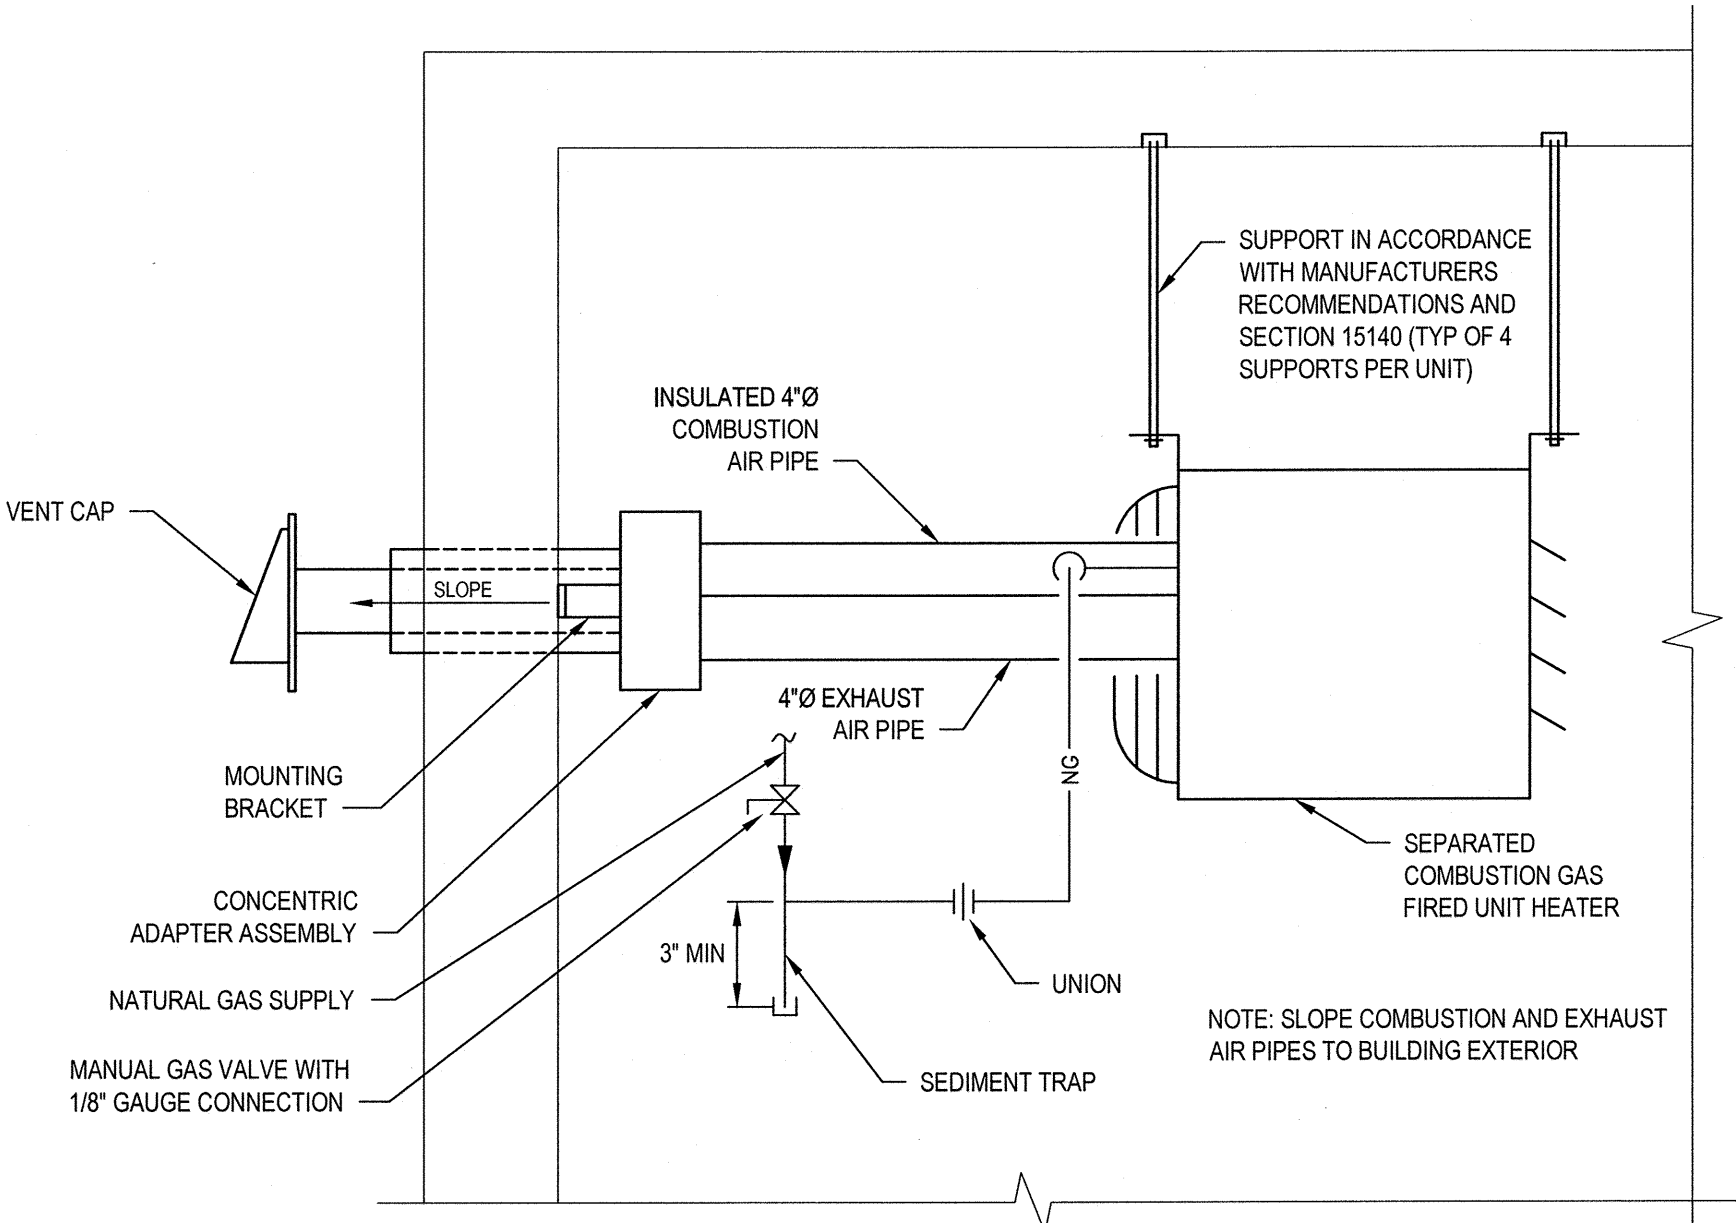


SEPARATED COMBUSTION GAS FIRED UNIT HEATER
NOT TO SCALE


- SCHEDULE NOTES:**
1. PROVIDE WITH ELECTRICALLY COMMUTATED MOTOR AND MOTOR MOUNTED SPEED DIAL.
 2. PROVIDE WITH MANUFACTURERS OUTSIDE AIR AND EXHAUST VENT TERMINATION KITS.

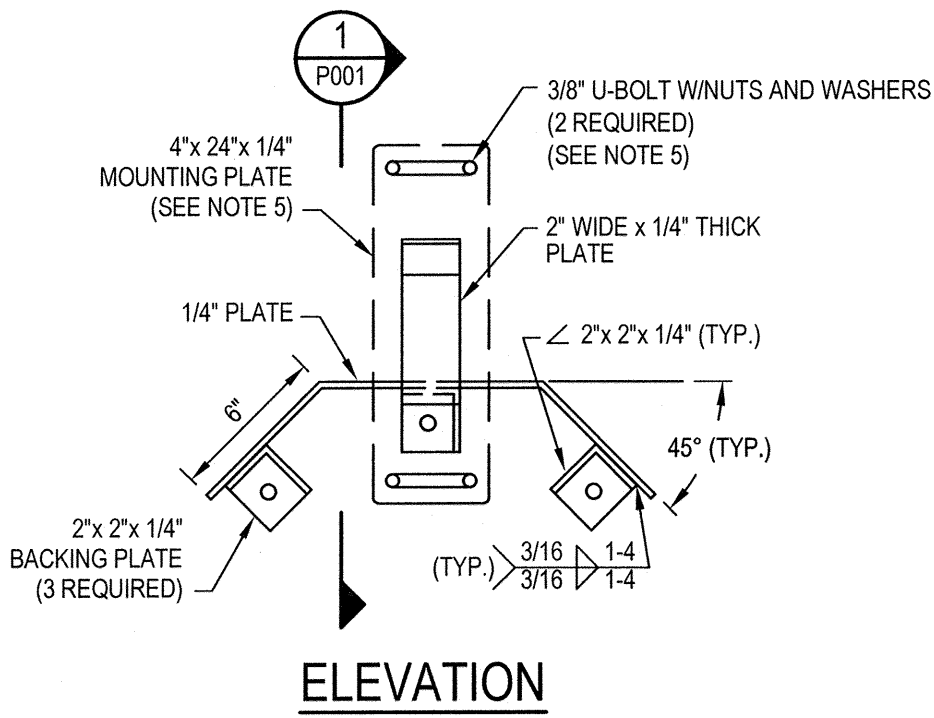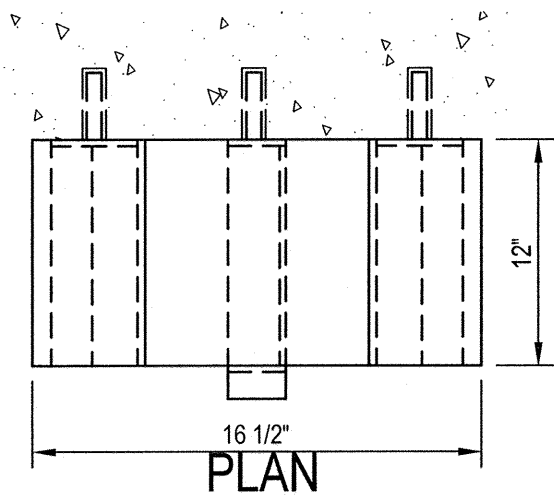


- NOTES:**
1. ANGLES AND PLATES SHALL BE 6061-T6 ALUMINUM.
 2. MILL FINISH.
 3. ALL HARDWARE SHALL BE STAINLESS STEEL.
 4. PAINT ALUMINUM IN CONTACT WITH CONCRETE PER SPECIFICATIONS.
 5. FOR COLUMN OR HANDRAIL MOUNTING, OMIT BACKING PLATES. PROVIDE MOUNTING PLATE AND U-BOLTS AS SHOWN.

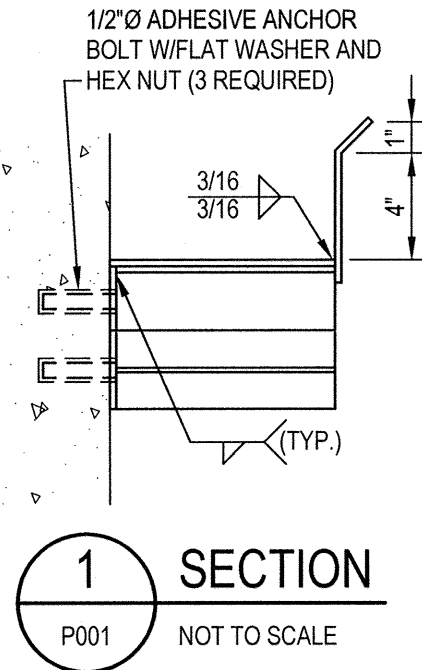


HOSE RACK DETAIL
NOT TO SCALE

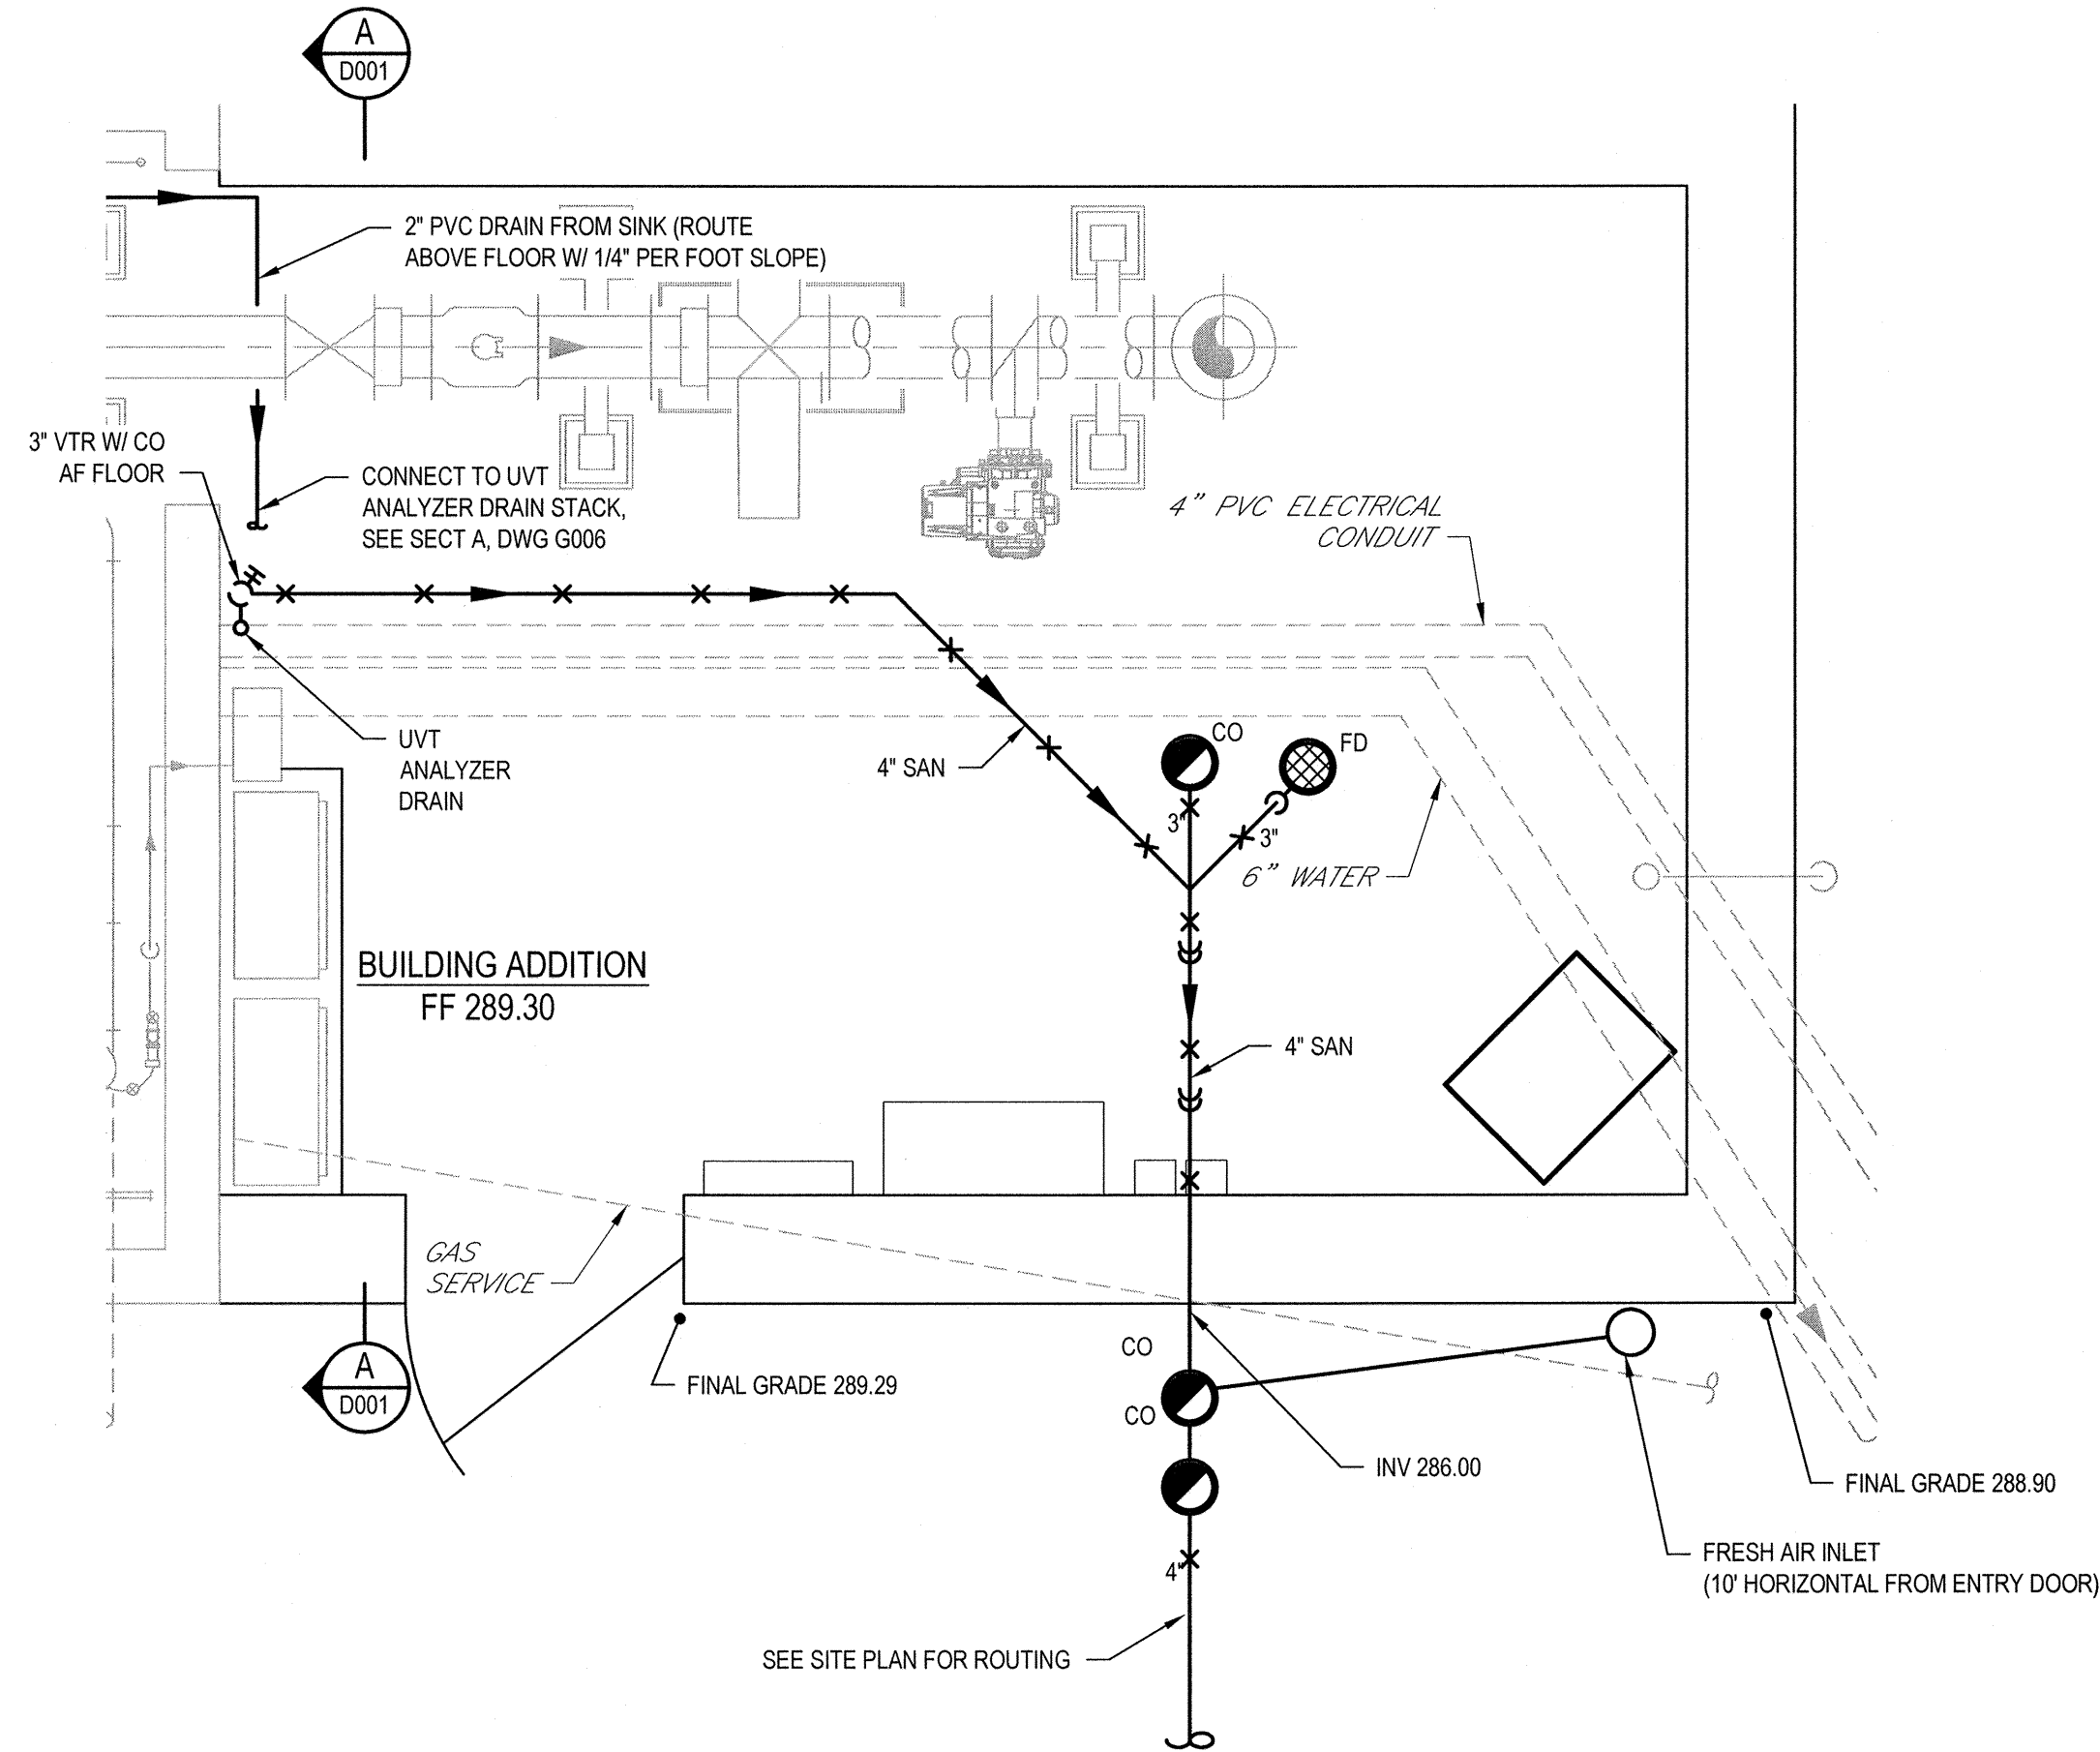


BUILDING ADDITION DWV PLAN
SCALE 1/2" = 1'-0"

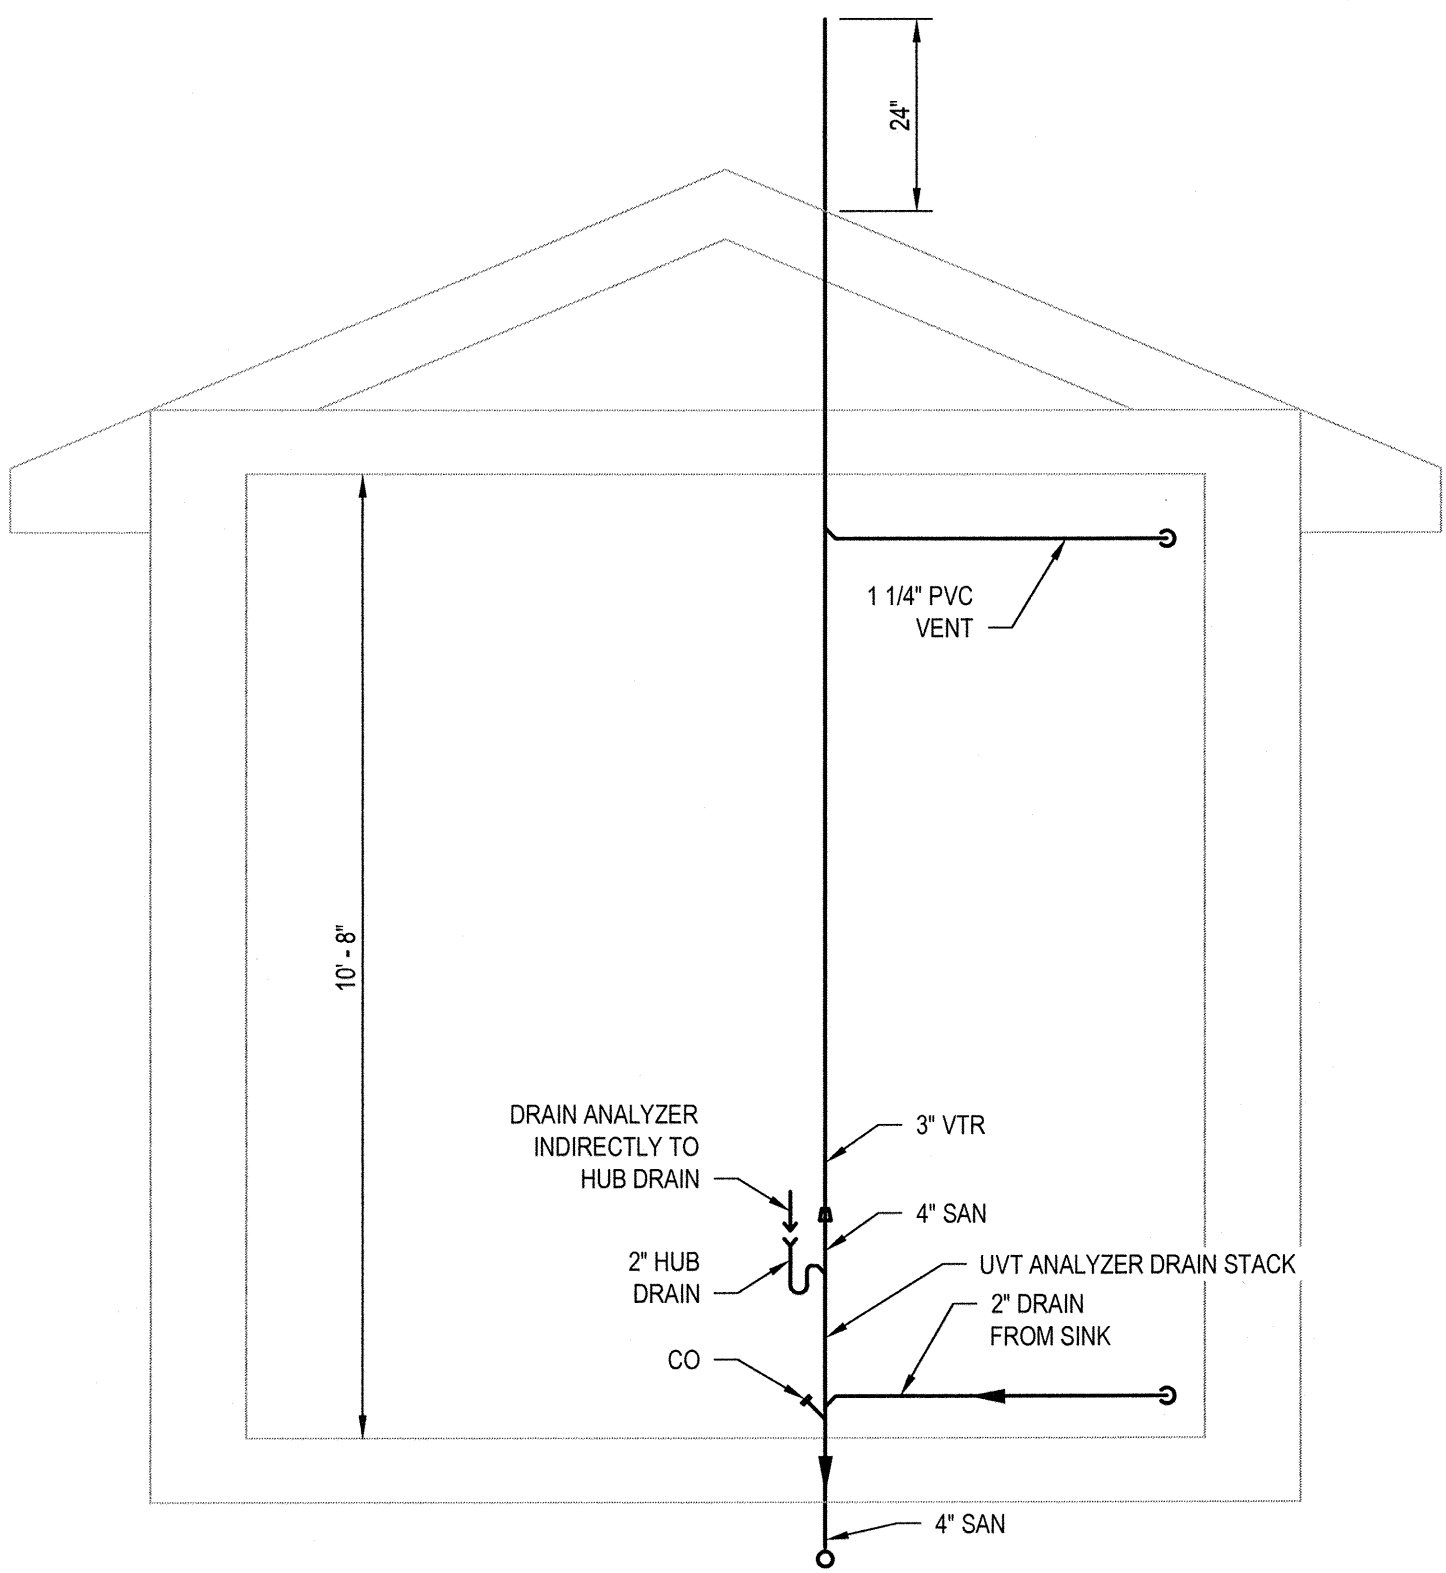


A SECTION
D001 SCALE: NOT TO SCALE

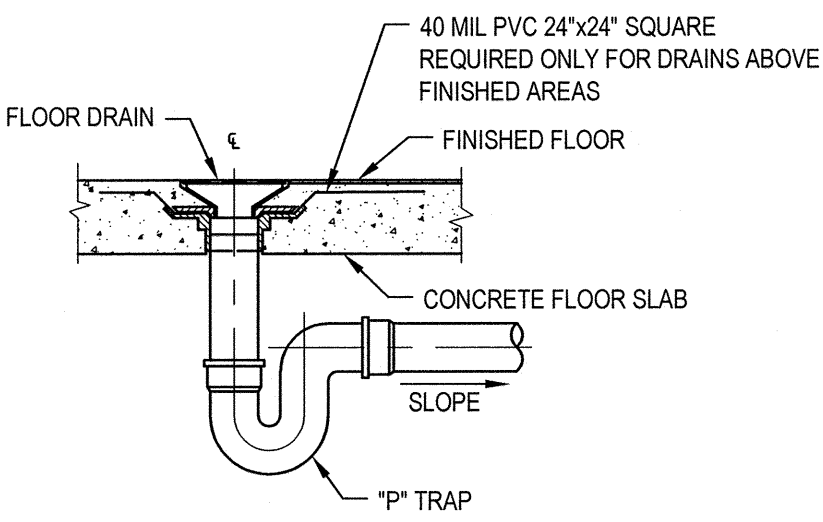

FLOOR DRAIN
NOT TO SCALE

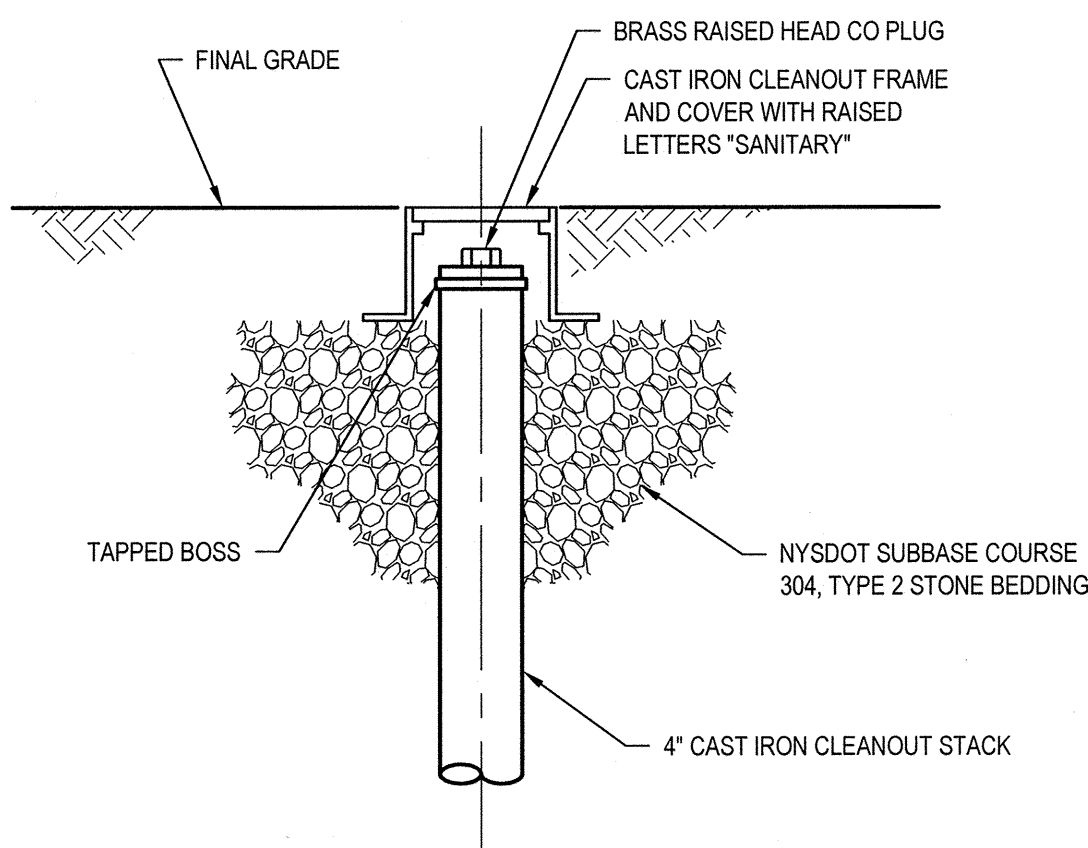

GRADE CLEANOUT DETAIL
NOT TO SCALE

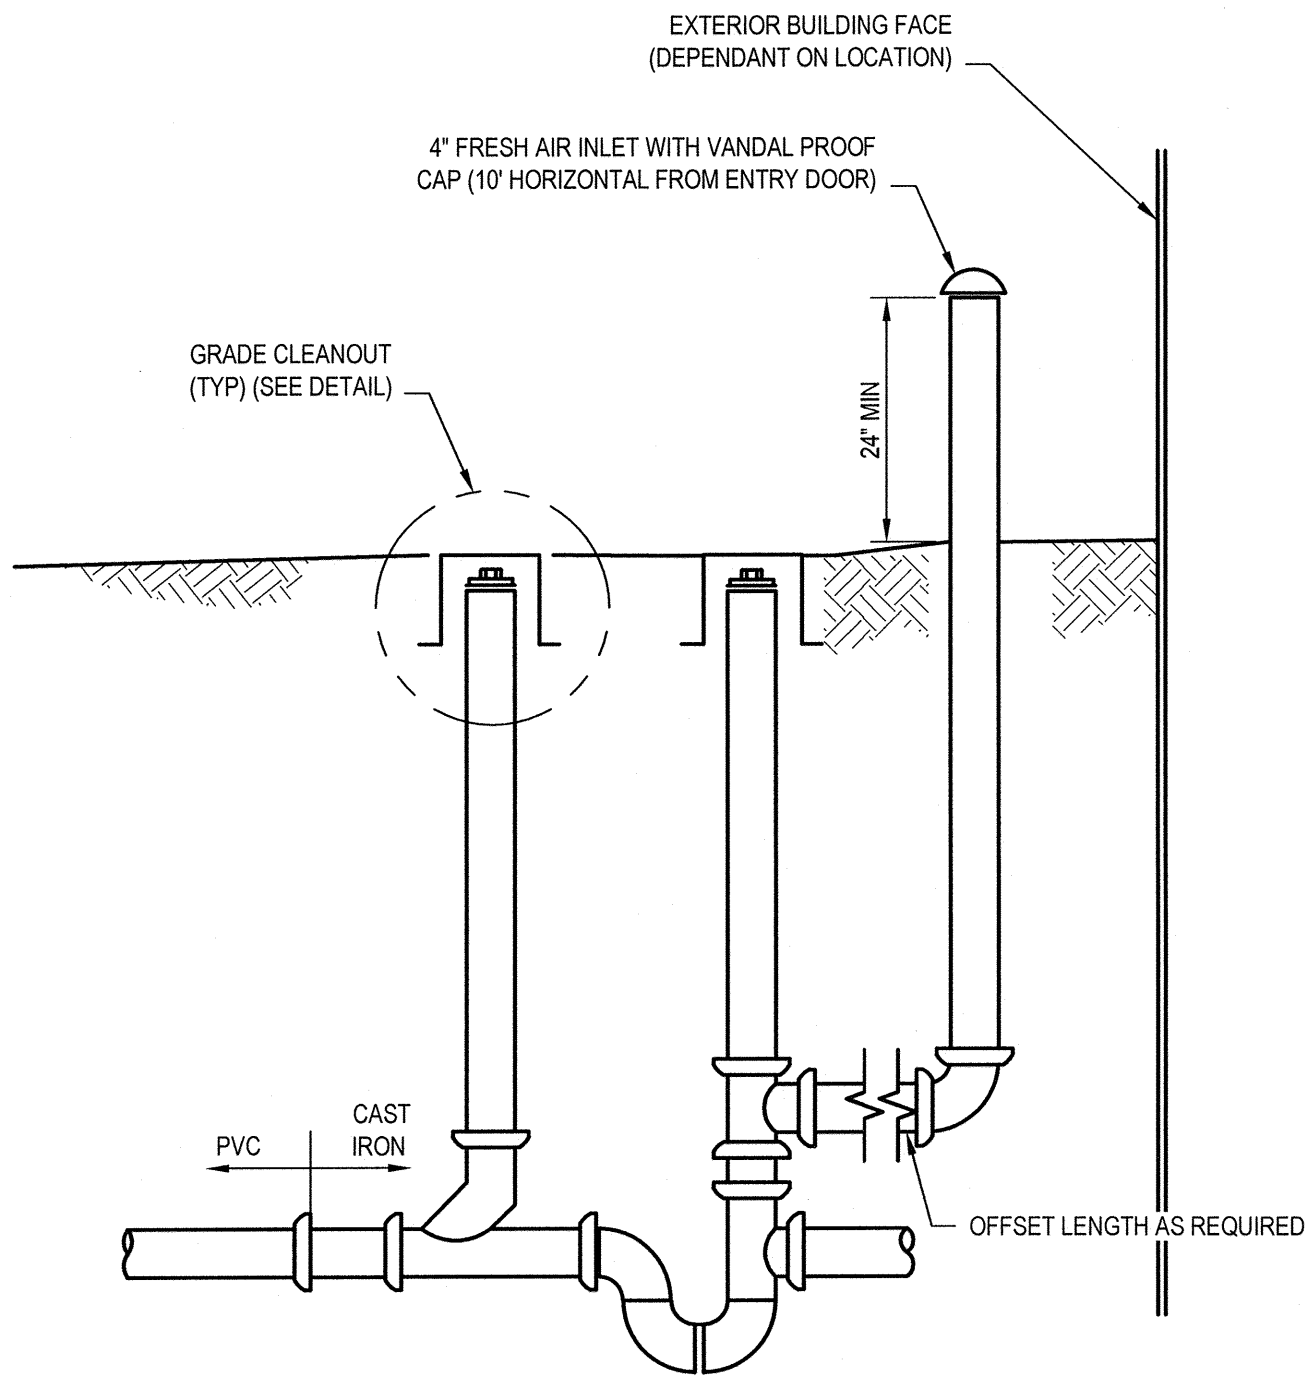

FRESH AIR INLET (FAI) AND CLEANOUT (CO) ASSEMBLY DETAIL
NOT TO SCALE

NOTES:

1. VENT AND CLEANOUT ASSEMBLY DETAIL APPLIES TO SANITARY BUILDING DRAIN.
2. ALL PIPE AND FITTINGS FOR FRESH AIR INLET, CLEANOUT ASSEMBLY AND SEWER SHALL BE SERVICE DUTY CAST IRON PIPE.

DWV ABBREVIATIONS:

AFF	ABOVE FINISHED FLOOR
CO	CLEANOUT
CODP	CLEANOUT DECK PLATE
COWP	CLEANOUT WALL PLATE
C	COLD WATER
D	DRAIN
DN	DOWN
DWV	DRAIN/WASTE/VENT
FD	FLOOR DRAIN
GV	GATE VALVE
HB	HOSE BIBB
NP	NON-POTABLE WATER
SAN	SANITARY
V	VENT
VTR	VENT THRU ROOF
W	WASTE
W	WITH

DWV SYMBOLS

---	VENT PIPING
---	SANITARY PIPING BELOW SLAB
●	CLEANOUT
●	FLOOR DRAIN
+	HOSE BIBB
---	HOSE RACK
○	BUILDING TRAP, VENT & CO
---	PIPE DOWN
---	PIPE UP

GENERAL NOTES:

1. COORDINATE ALL PLUMBING WORK WITH OTHER TRADES.
2. ISOLATION VALVES SHALL BE INSTALLED AT ALL BRANCH LINES, FIXTURES, AND EQUIPMENT.
3. ALL PIPING SHALL BE ADEQUATELY SUPPORTED PER SPECIFICATIONS.
4. SUPPLY ALL FITTINGS REQUIRED TO MAINTAIN SMOOTH FLOW LINES, CHANGE IN ELEVATIONS AND TO MEET ALL TRANSITIONS FOR A COMPLETE SYSTEM.
5. SEE DRAWING G002 FOR GENERAL LIST OF ADDITIONAL ABBREVIATIONS.
6. ALL PIPE, FITTINGS, VALVES AND HYDRANTS CONNECTED TO AND FORMING PART OF A POTABLE WATER SUPPLY SYSTEM SHALL BE DISINFECTED IN FULL ACCORDANCE WITH BOTH THE REQUIREMENTS OF AWWA STANDARD C681 AND THE STATE OR COUNTY DEPARTMENT OF HEALTH HAVING JURISDICTION OVER THE PROJECT.


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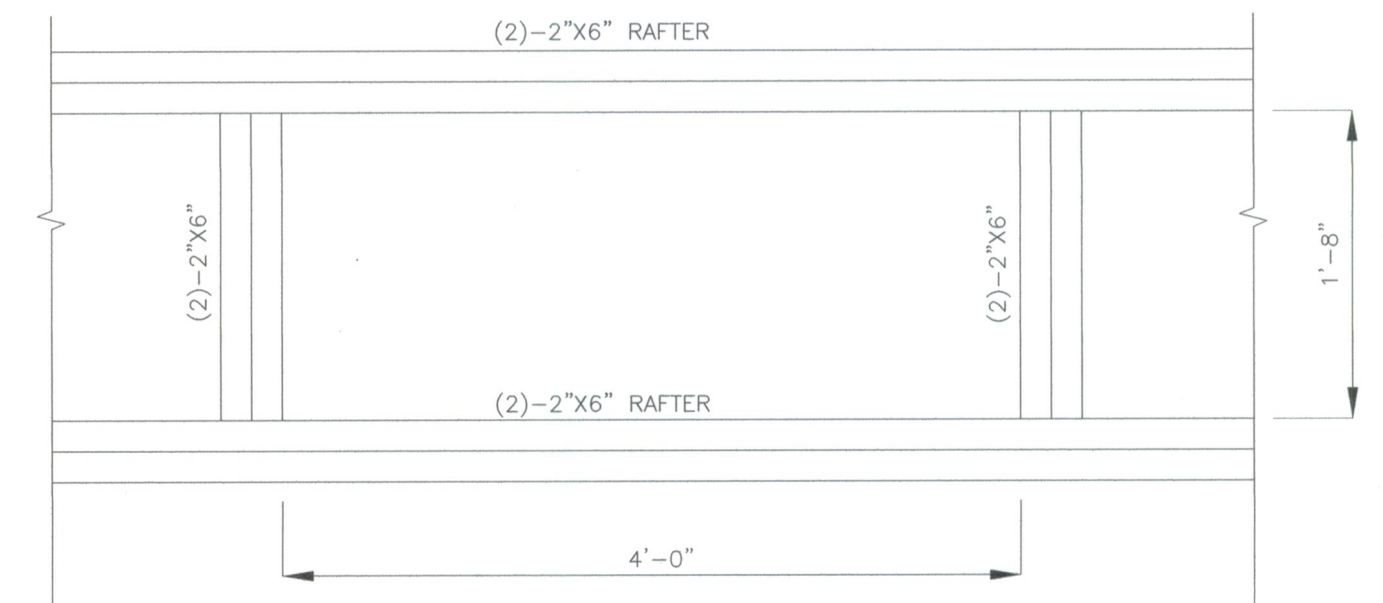
manganaro
ENGINEERS

NOT ALL BUILDING PENETRATIONS ARE SHOWN. CONTRACTOR SHALL COORDINATE PENETRATIONS WITH THE GENERAL, MECHANICAL, AND ELECTRICAL DRAWINGS.


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EXIST./PROPOSED WEST ELEVATION
SCALE: 1/2"=1'-0"




PLAN
SKYLIGHT DETAIL
NTS

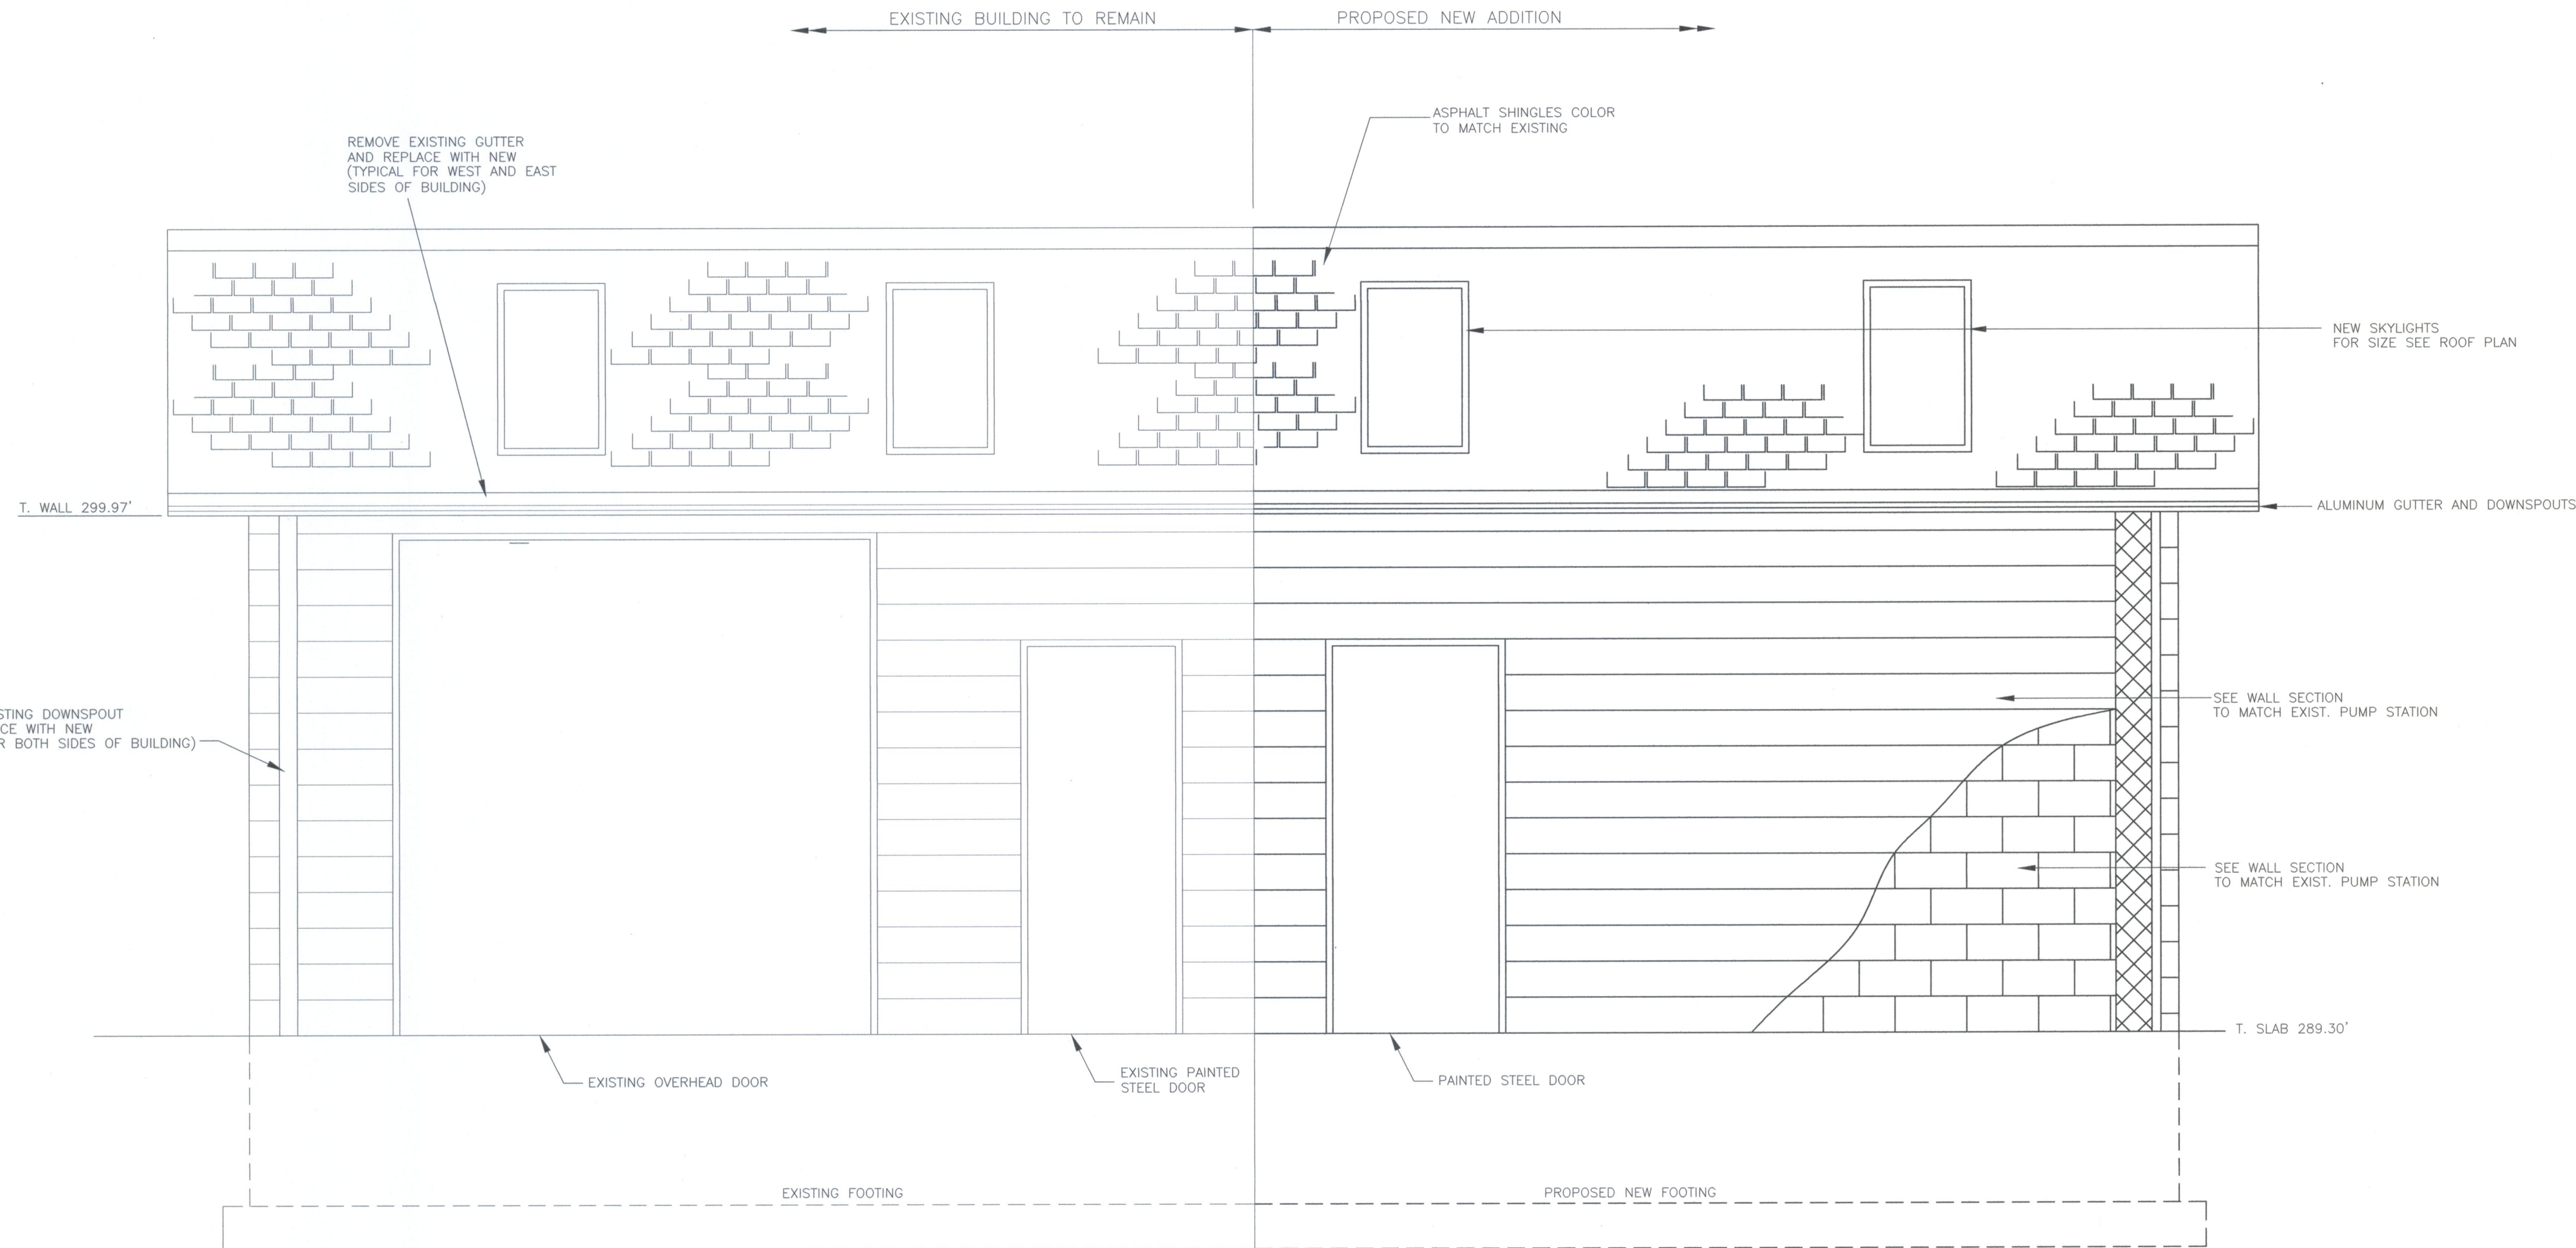


TYPICAL SECTION DETAIL
NTS

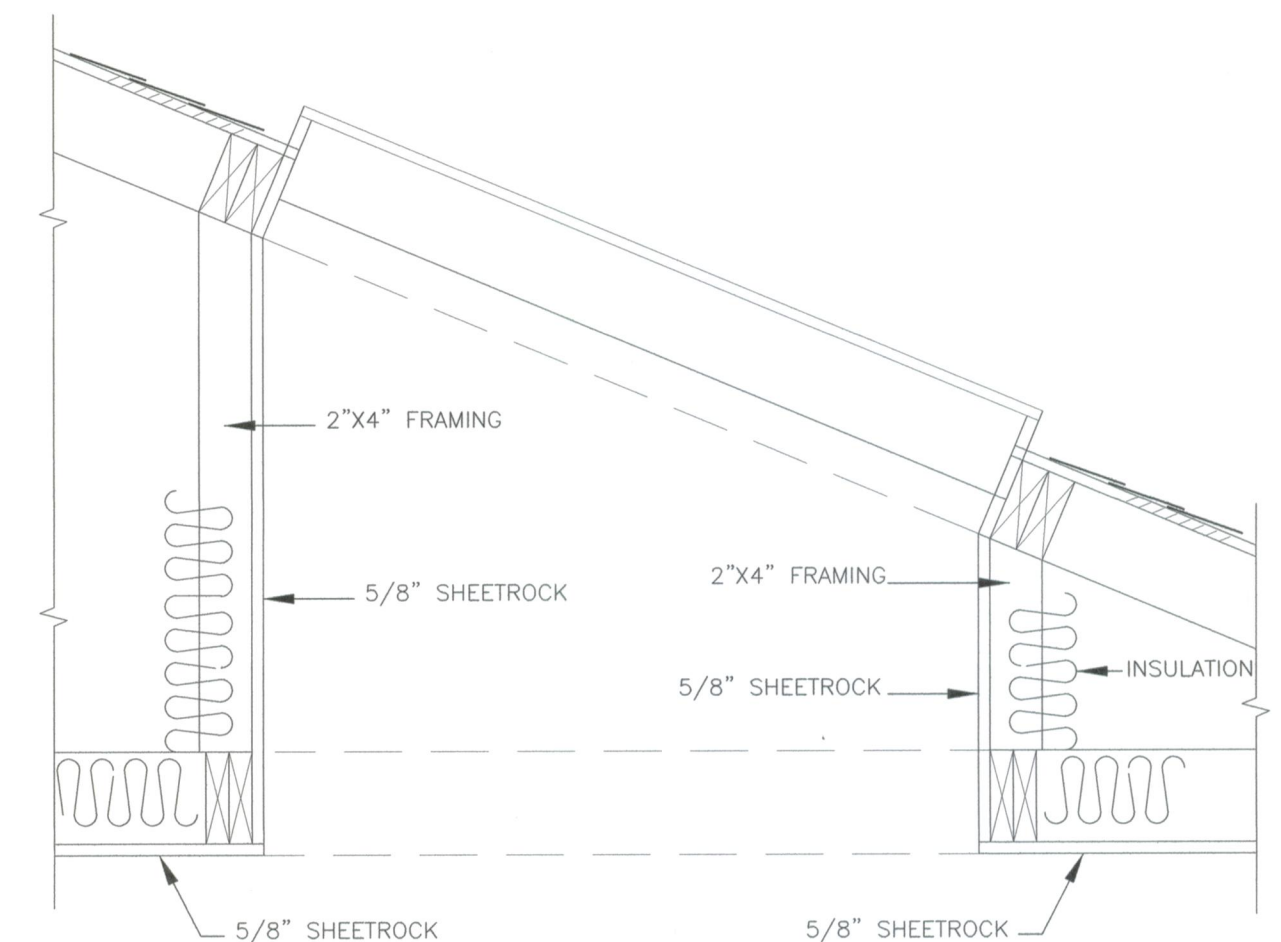NOTE:

TO TIE NEW ROOF INTO EXISTING ROOF, REMOVE THE EXISTING FASCIA BOARD AND OTHER OBSTRUCTIONS BACK TO THE FIRST TRUSS OF EXISTING ROOF. CUT BACK EXISTING ROOF BOARD TO THE FIRST TRUSS OF EXISTING ROOF AND ABUTT THE NEW BOARD.

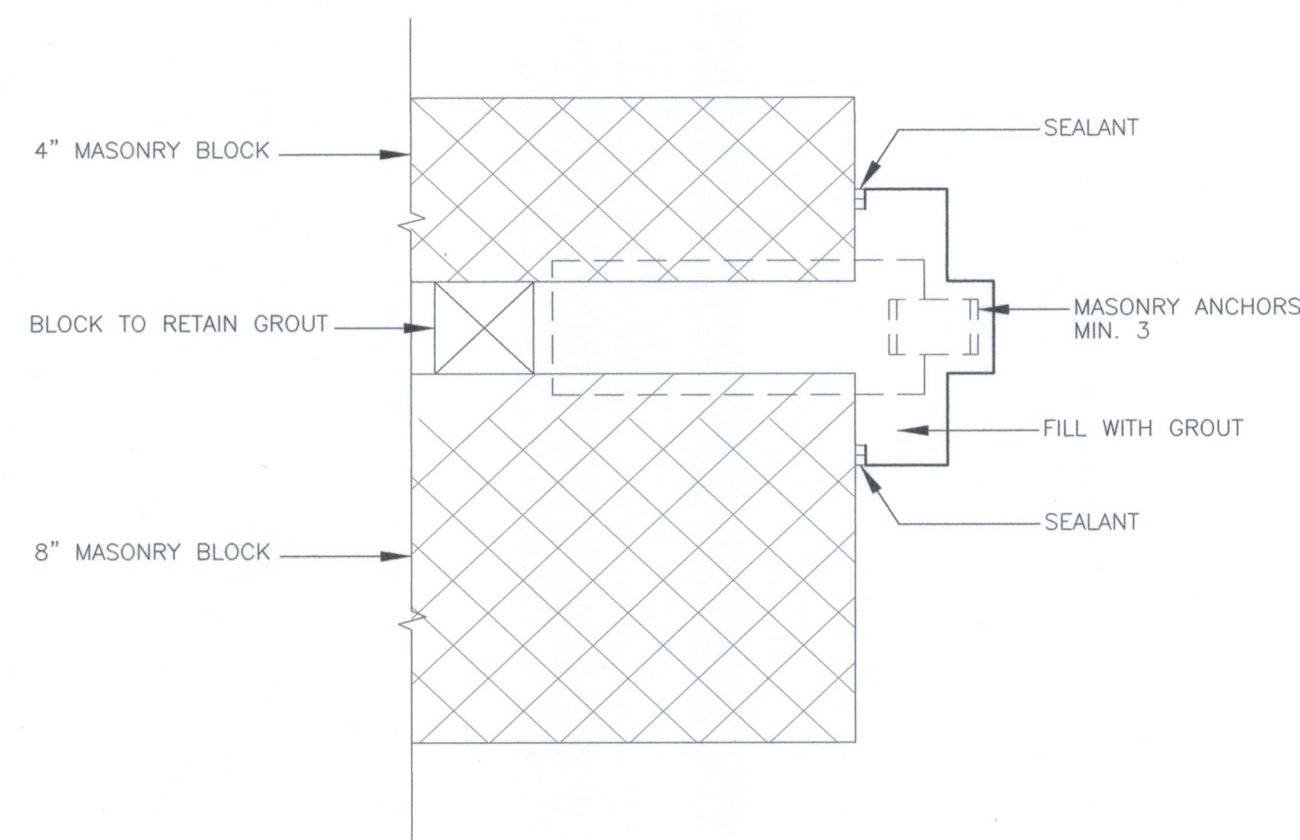

TYPICAL JAMB DETAIL
NTS

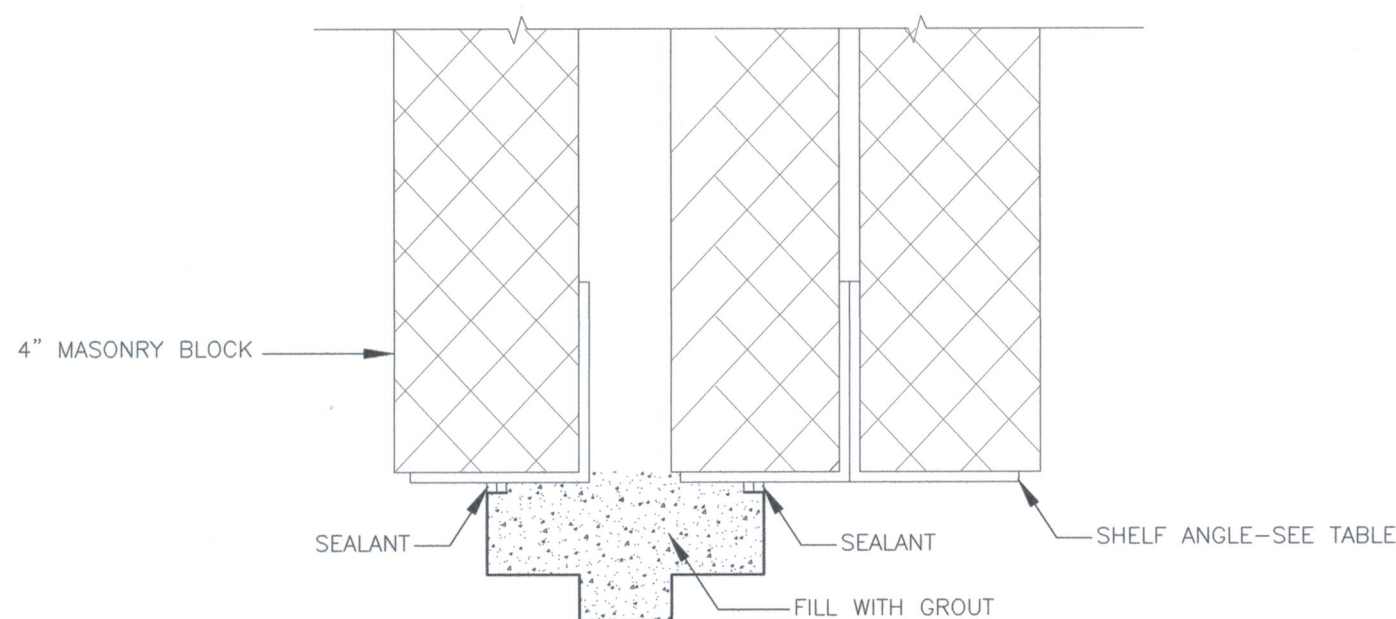


TYPICAL HEAD DETAIL
NTS

NOTES:

UNDERGROUND FACILITIES, STRUCTURES, AND UTILITIES HAVE BEEN PLOTTED FROM AVAILABLE SURVEYS AND RECORDS, AND THEREFORE THEIR LOCATIONS MUST BE CONSIDERED APPROXIMATE ONLY. THERE MAY BE OTHERS, THE EXISTENCE OF WHICH IS PRESENTLY NOT KNOWN.

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Drawn: GH	Designer: GH
Drafting: ST	Design: JSK
Check	Check
Approved Project Director: SRN	Contract No. 1
Date: 10/2015	This Drawing shall not be used for Construction unless Signed and Sealed For Construction
Scale: AS SHOWN	Original Size

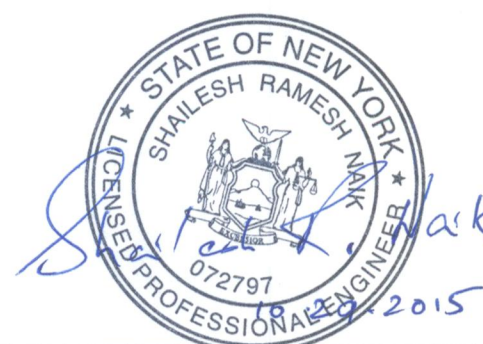Client	TOWN OF NORTH CASTLE, NEW YORK		
Project	NORTH BROADWAY PUMP STATION		
	ULTRAVIOLET DISINFECTION		
Title	BUILDING ELEVATION AND DETAILS		
Arch D	Drawing No: A002	Rev: 0	




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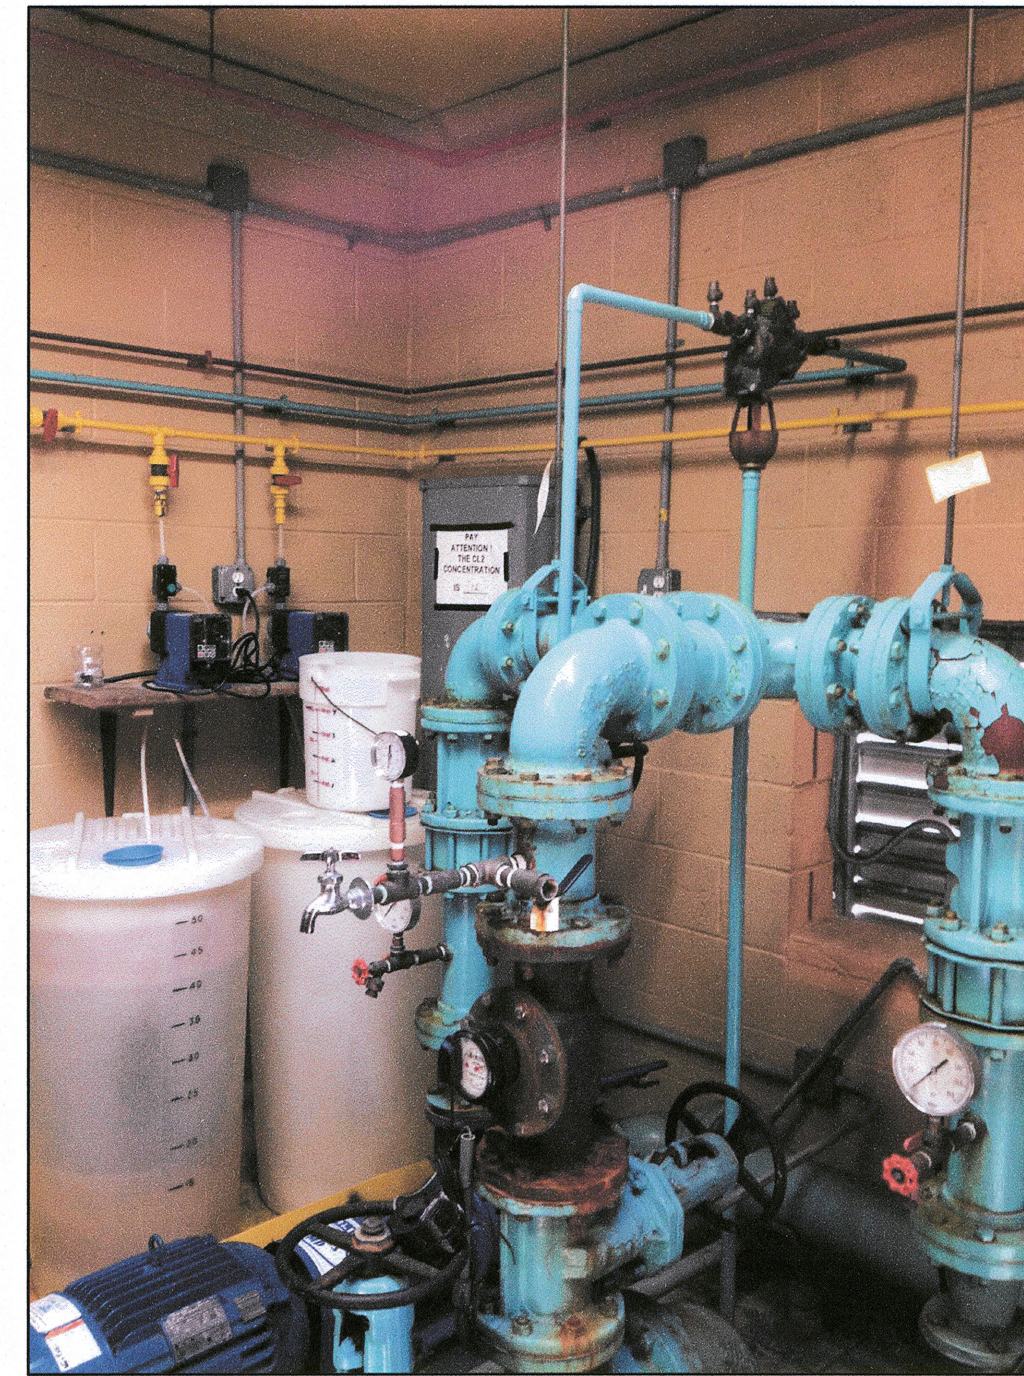


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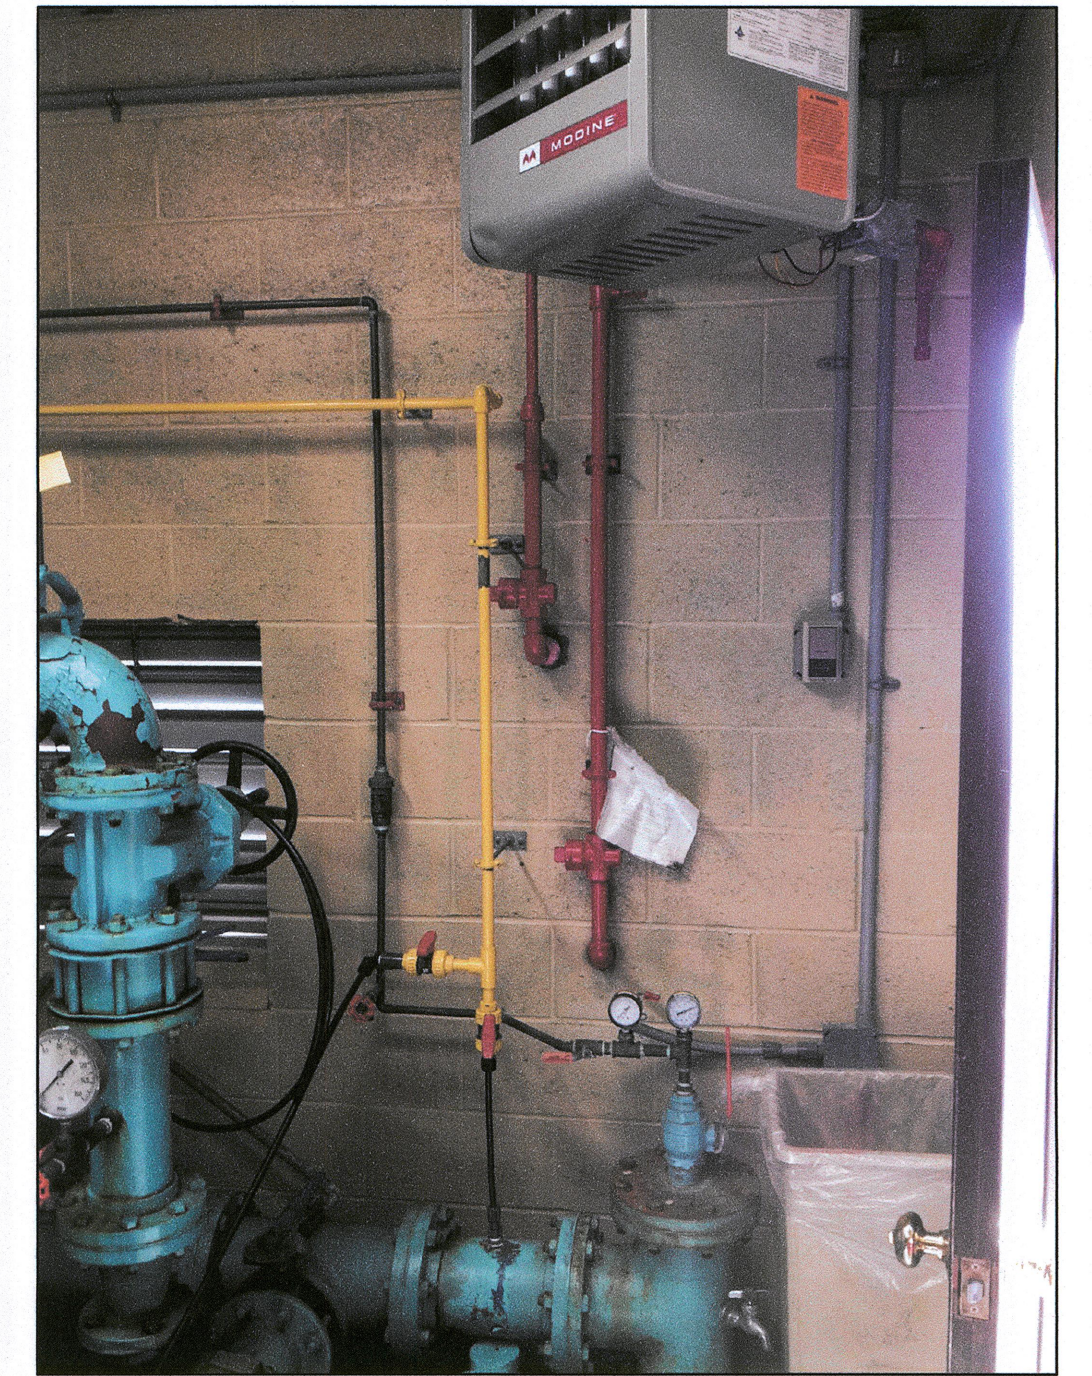
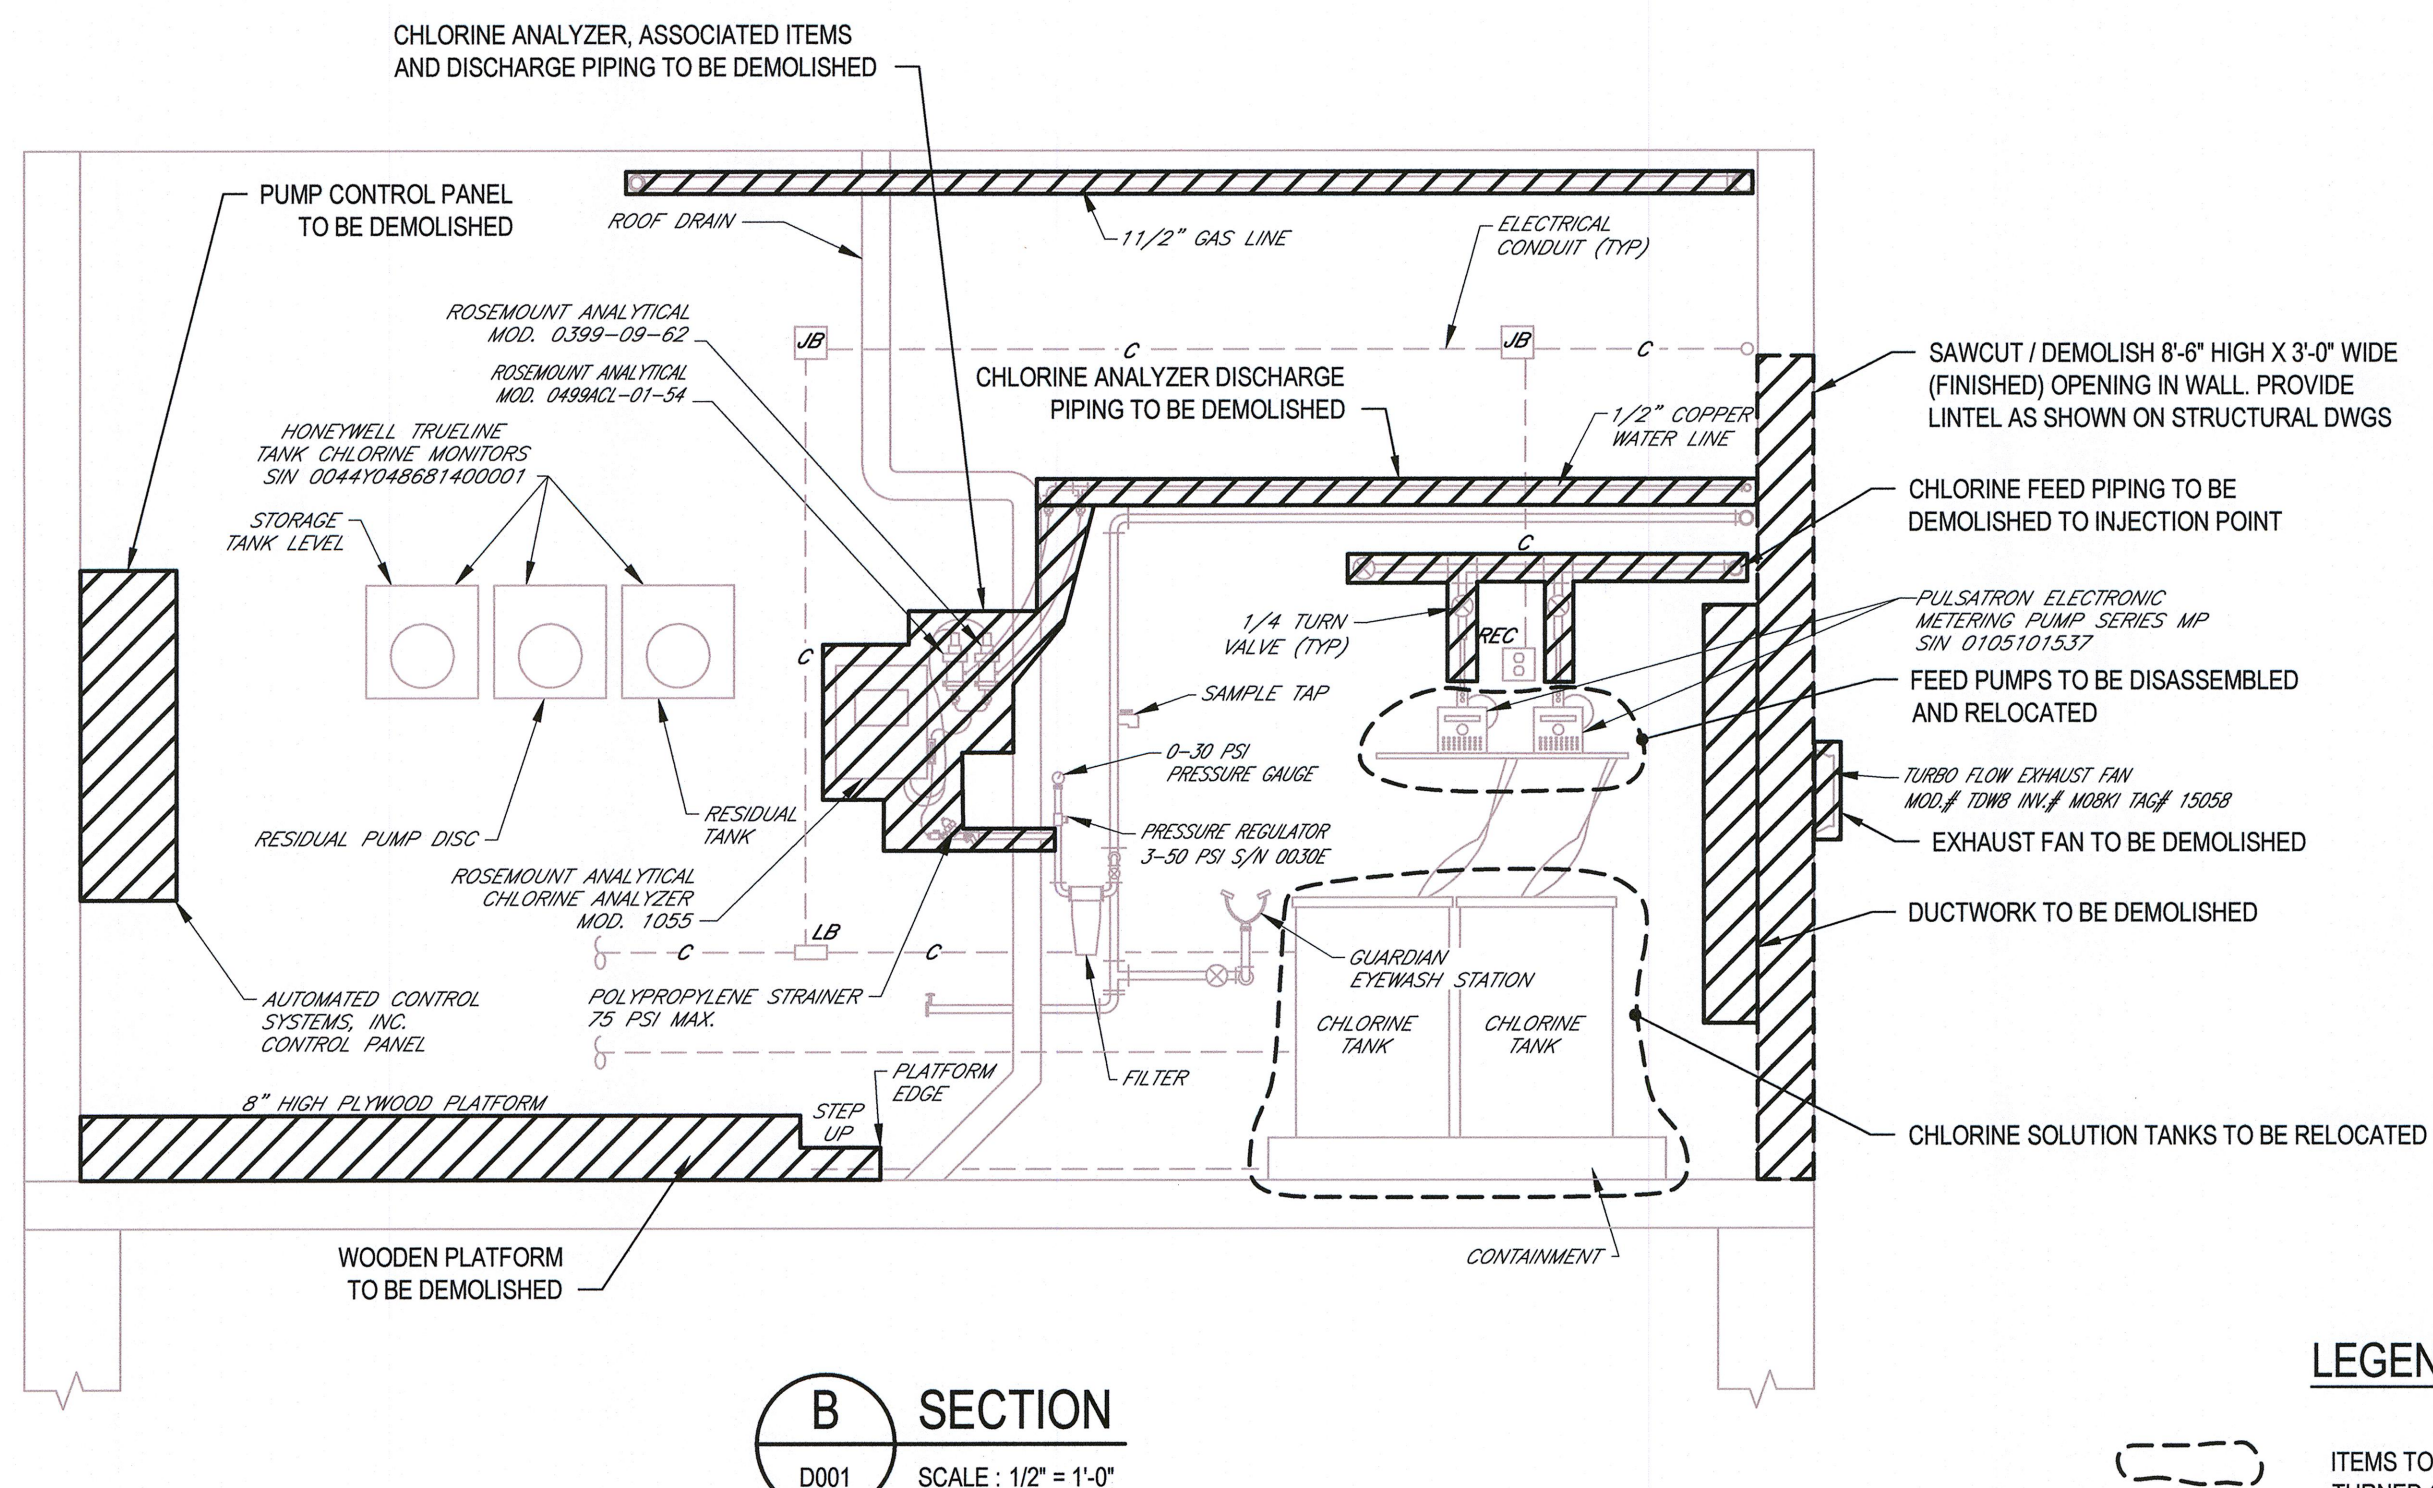
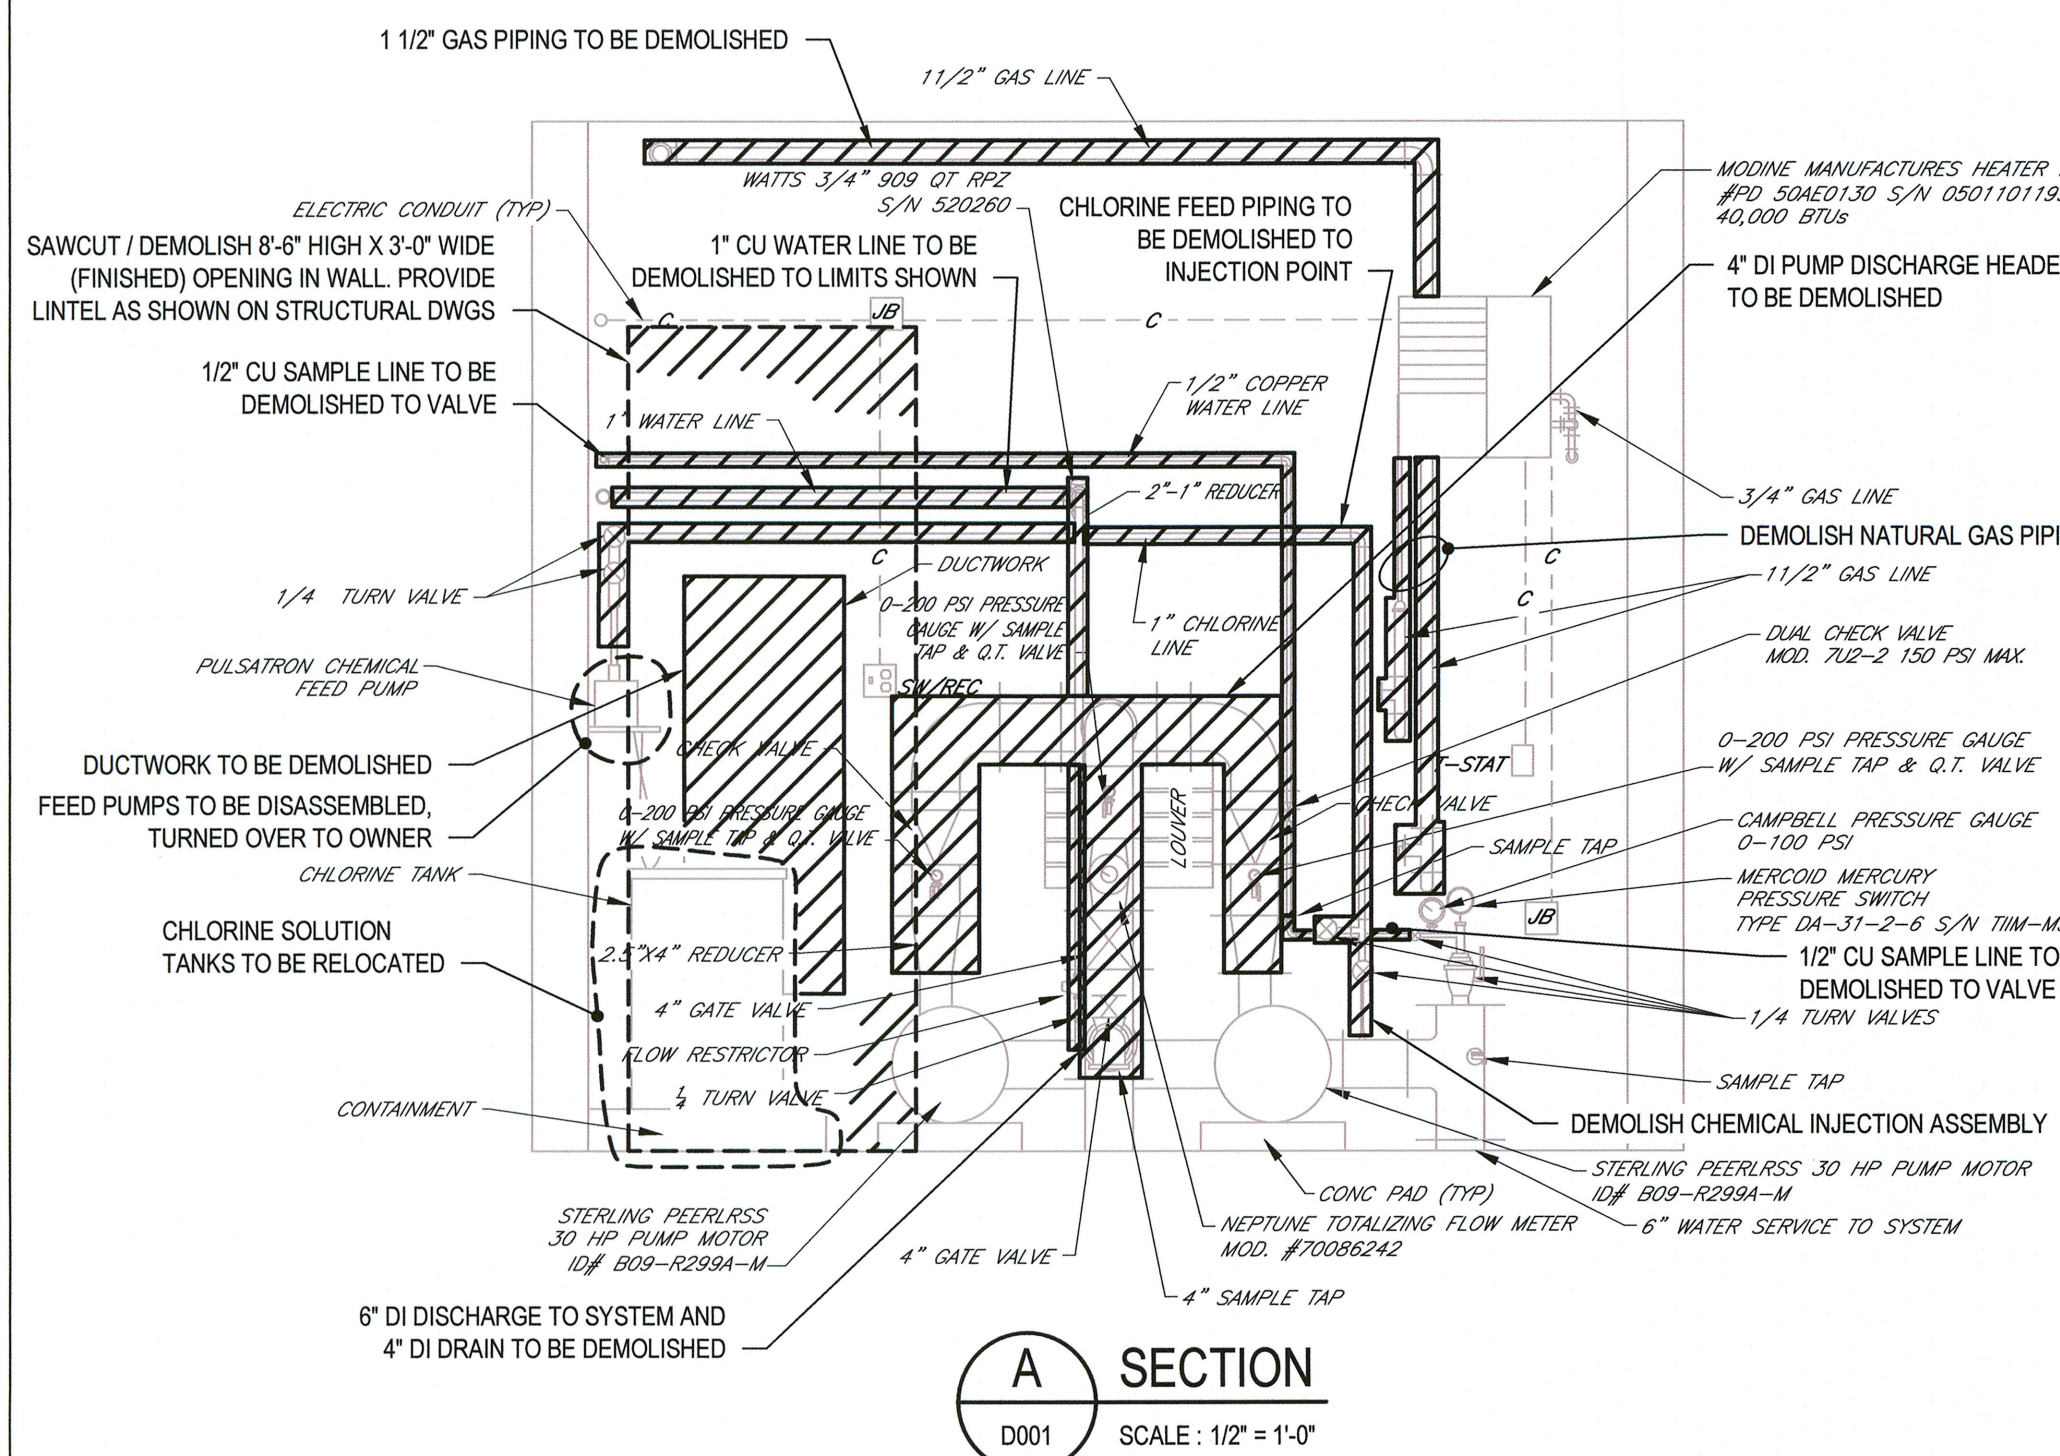


PHOTO 3

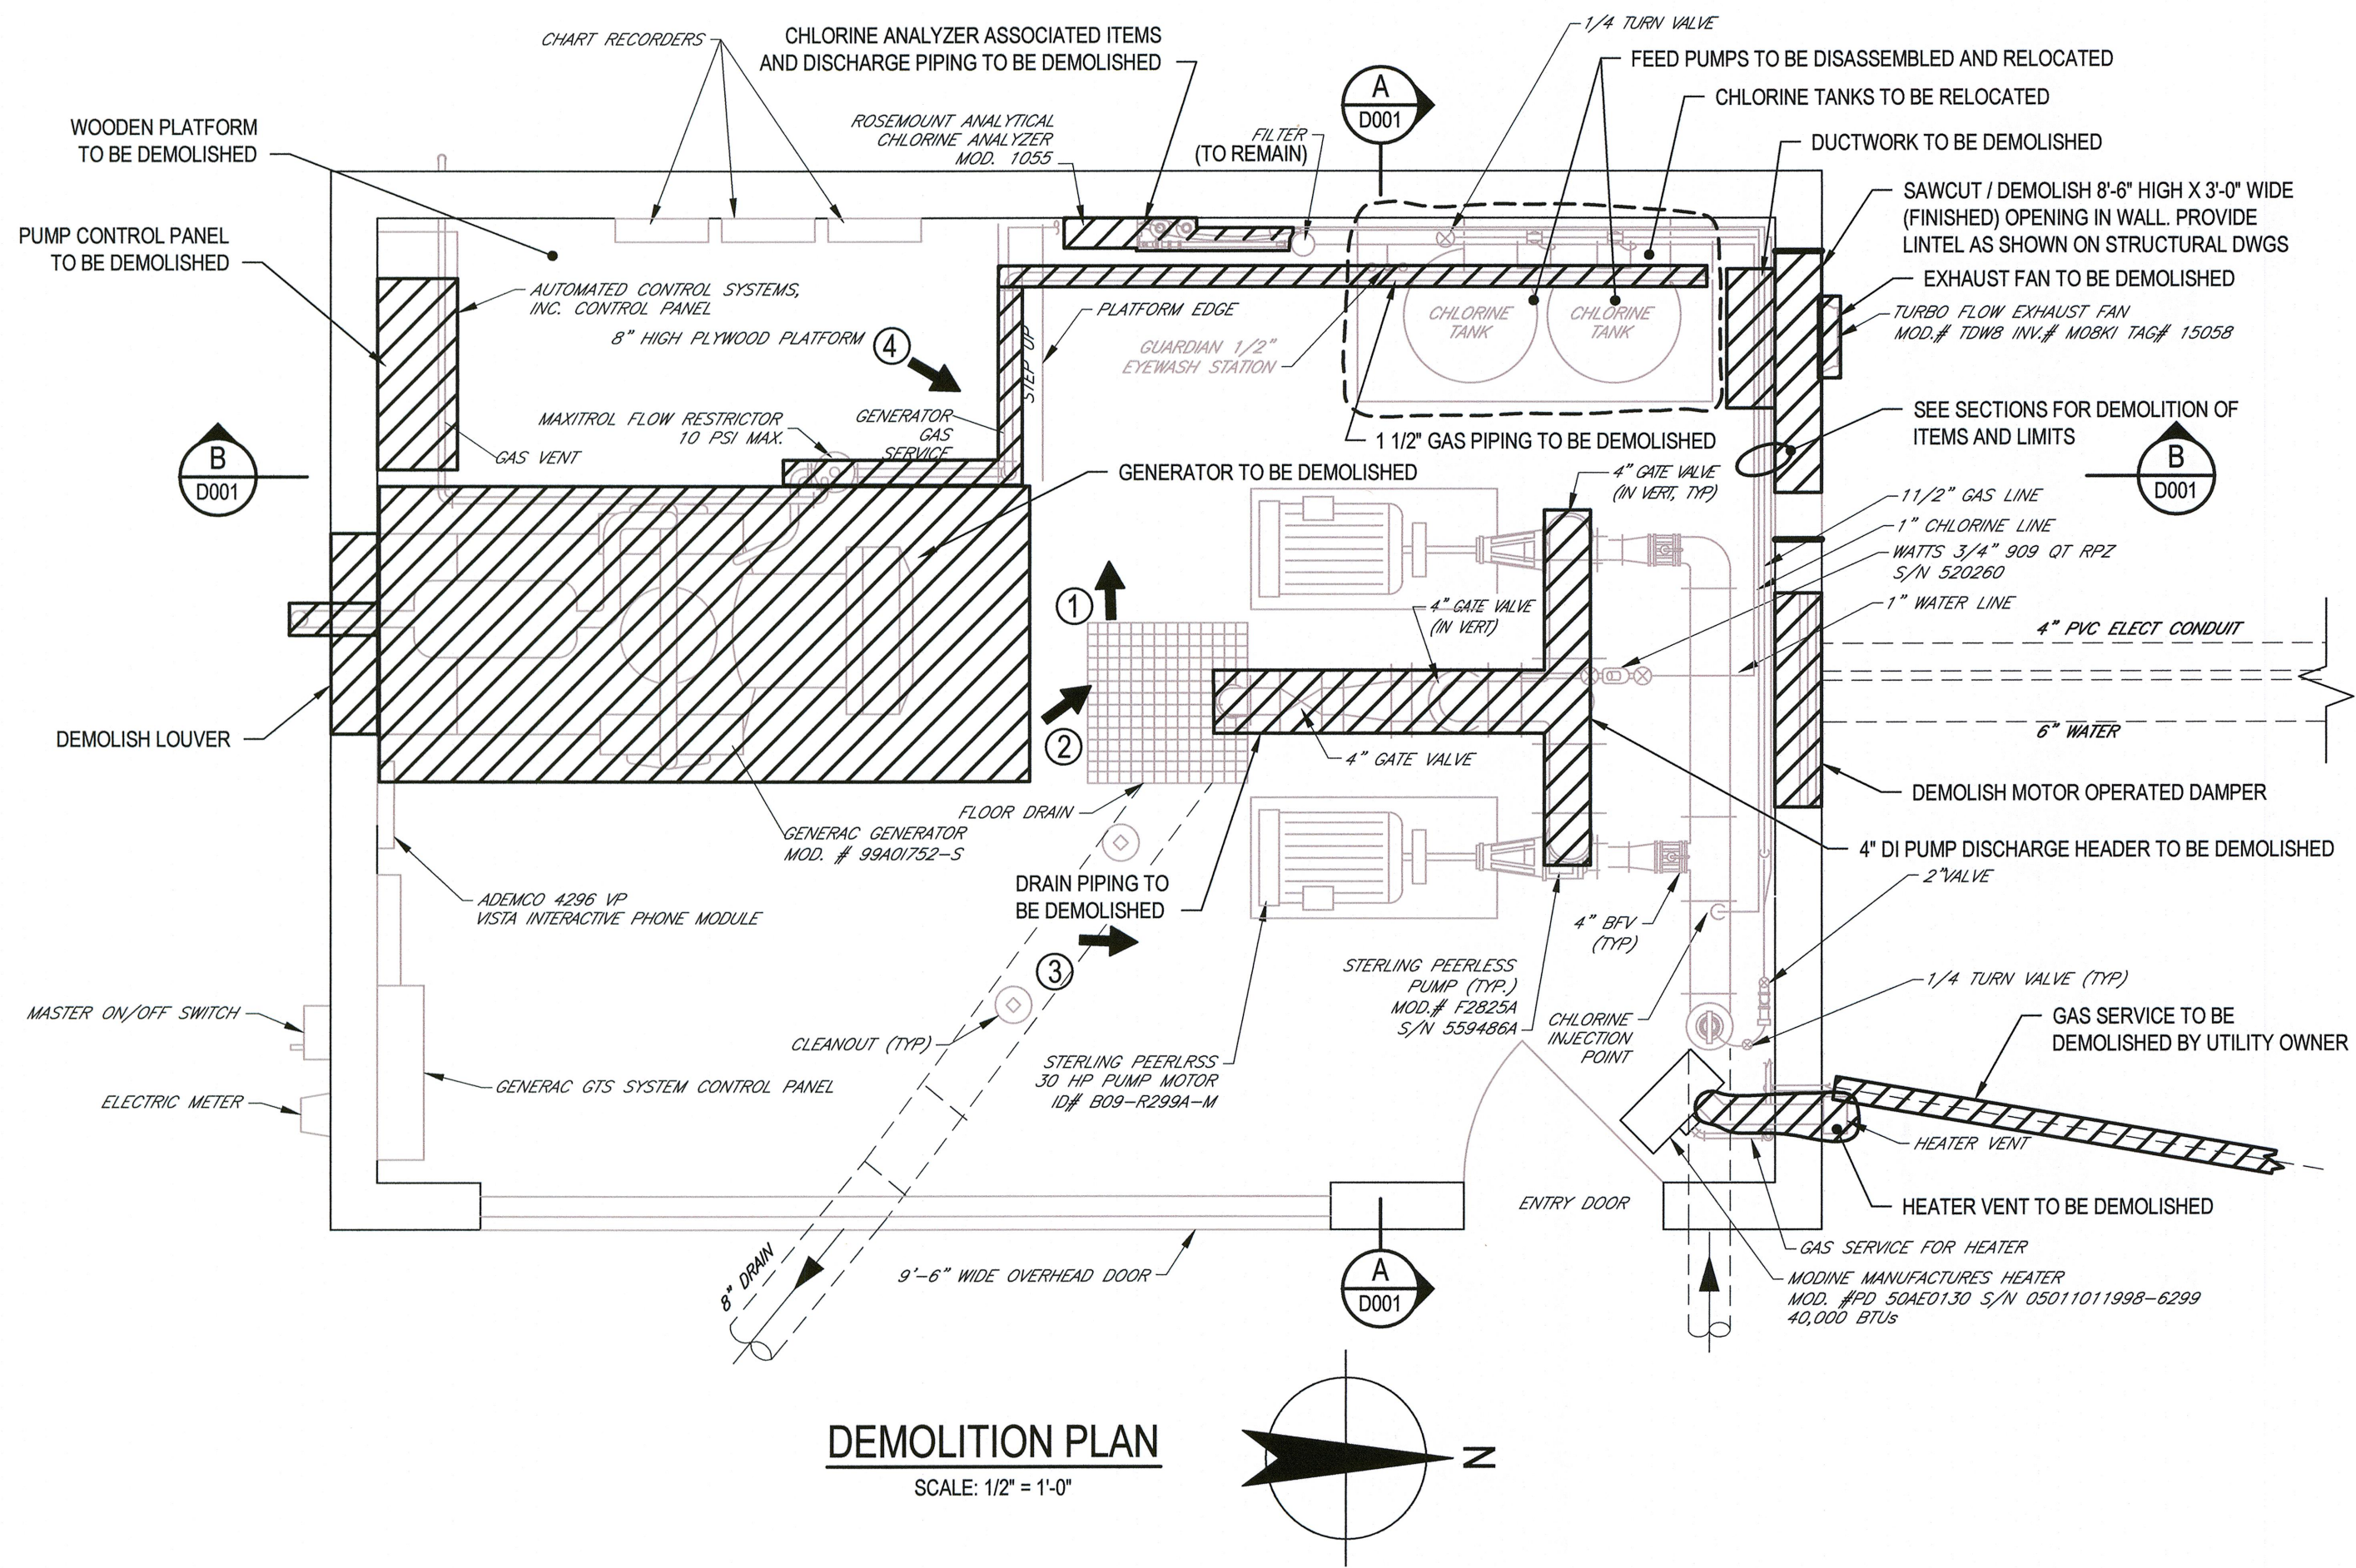

LEGEND

- ITEMS TO BE RELOCATED / DISASSEMBLED
TURNED OVER TO OWNER
- /// ITEMS TO BE DEMOLISHED
- ③ PHOTO LOCATION / DIRECTION



PHOTO 4






0 1'-0" 2'-0" 3'-0" 4'-0"
SCALE 1/2"=1'-0" AT ORIGINAL SIZE

NOTES:				
UNDERGROUND FACILITIES, STRUCTURES, AND UTILITIES HAVE BEEN PLOTTED FROM AVAILABLE SURVEYS AND RECORDS, AND THEREFORE THEIR LOCATIONS MUST BE CONSIDERED APPROXIMATE ONLY. THERE MAY BE OTHERS, THE EXISTENCE OF WHICH IS PRESENTLY NOT KNOWN.				
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0	FOR CONSTRUCTION	MRY	NJH	KC
No	Revision	Note: * indicates signatures on original issue of drawing or last revision of drawing	Drawn	Job Manager
			Project Director	Date



GHD Consulting Services, Inc.
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Cazenovia NY 13035 USA
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E cazmail@ghd.com W www.ghd.com

Drawn MRY	Designer MRY	Client	TOWN OF NORTH CASTLE, NEW YORK NORTH BROADWAY ULTRAVIOLET DISINFECTION DEMOLITION AND EXISTING CONDITIONS PLANS, SECTIONS AND PHOTOS
Drafting Check M. P. [Signature]	Design Check [Signature]	Project	
Approved (Project Director) [Signature]		Title	
Date 6/30/15	Contract No. 1		
Scale AS SHOWN	This Drawing shall not be used for Construction unless Signed and Sealed For Construction		
		Original Size Arch D	Drawing No: 86-16786-D001
			Rev: 0

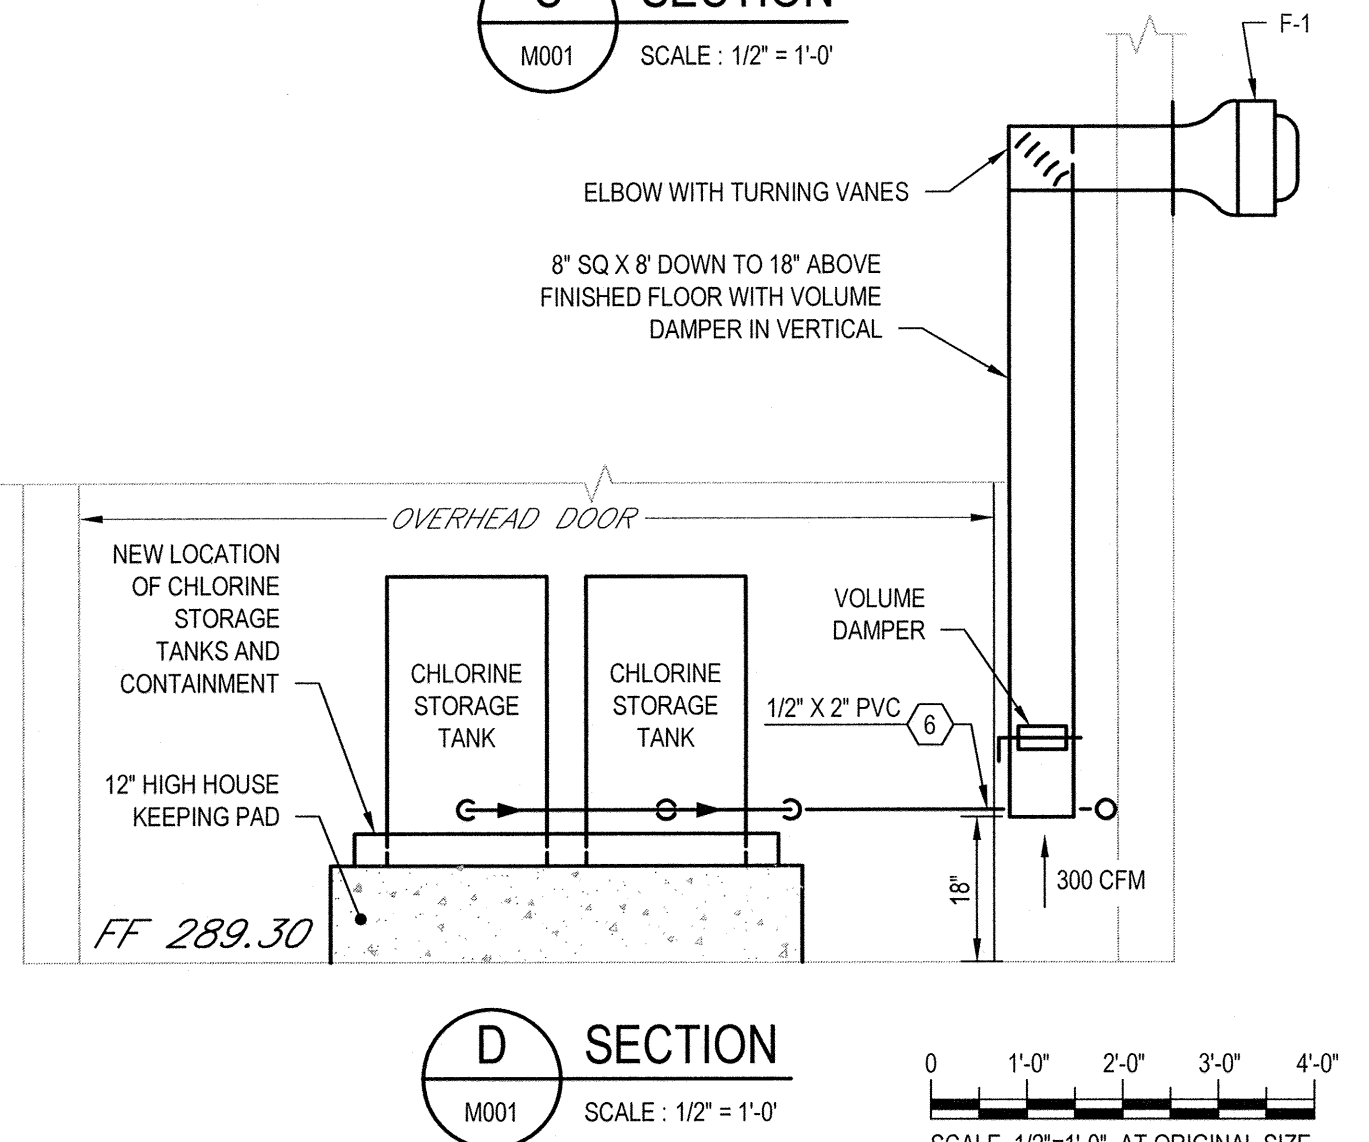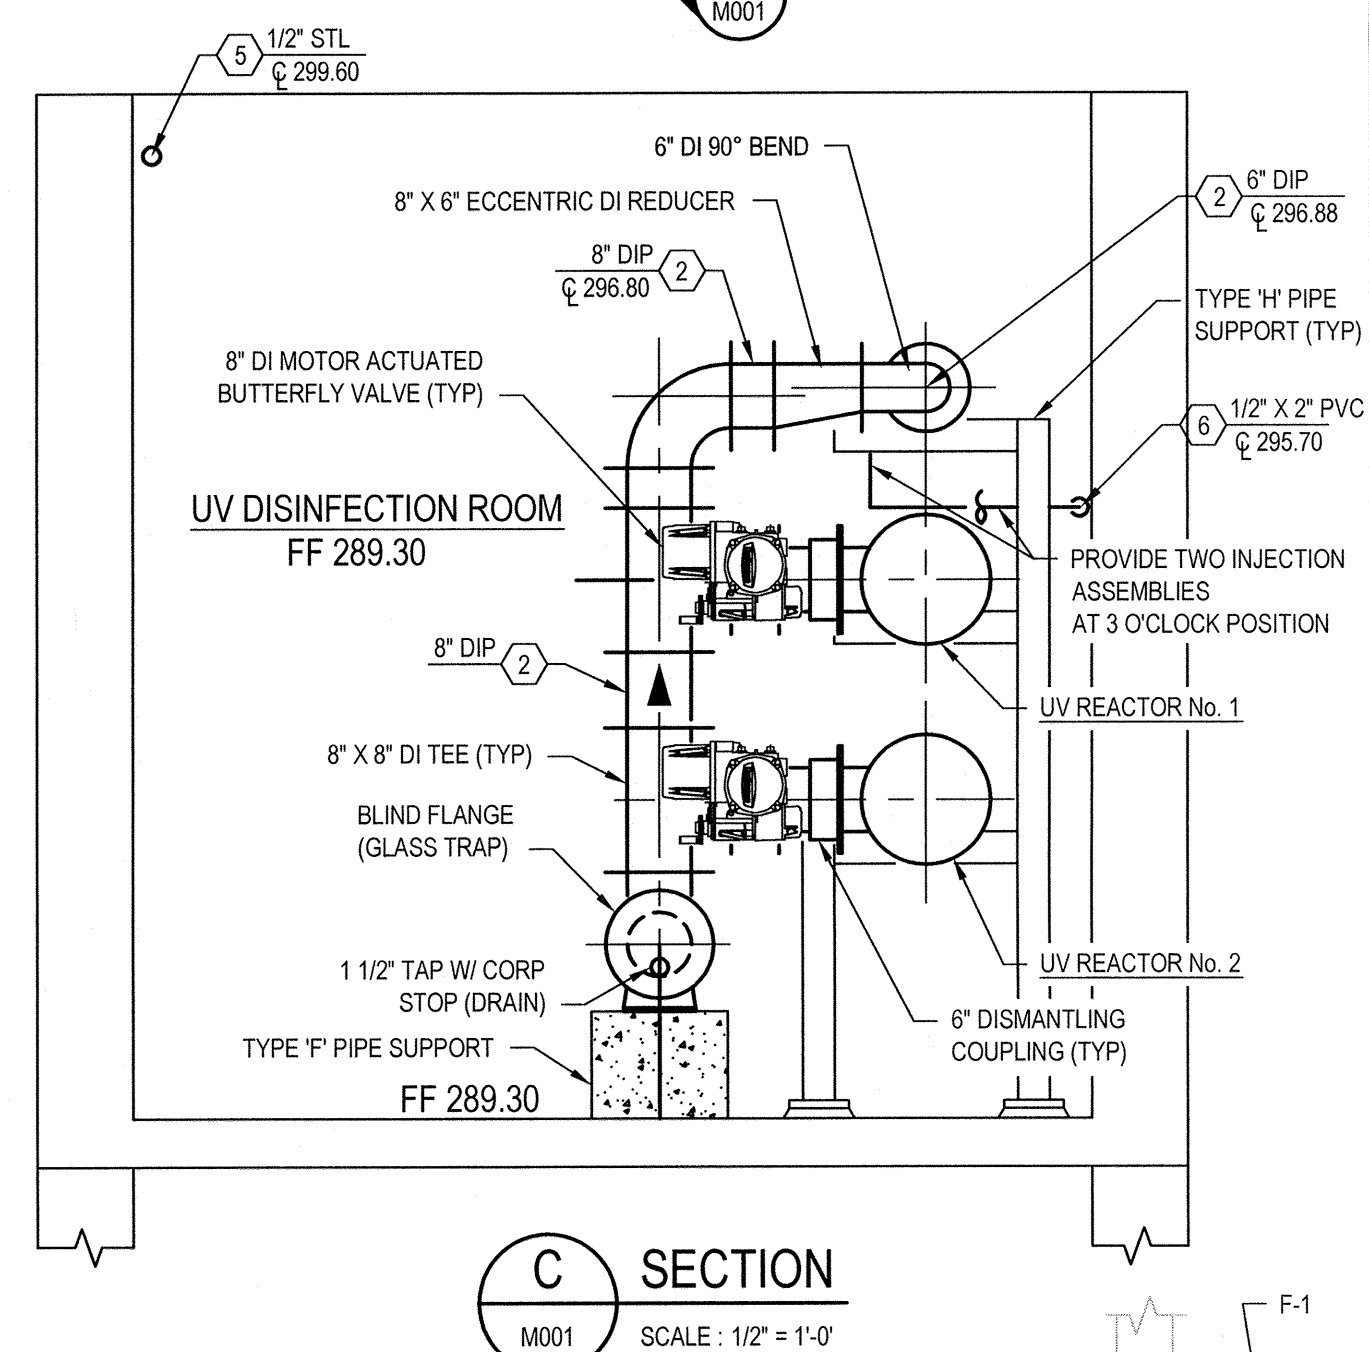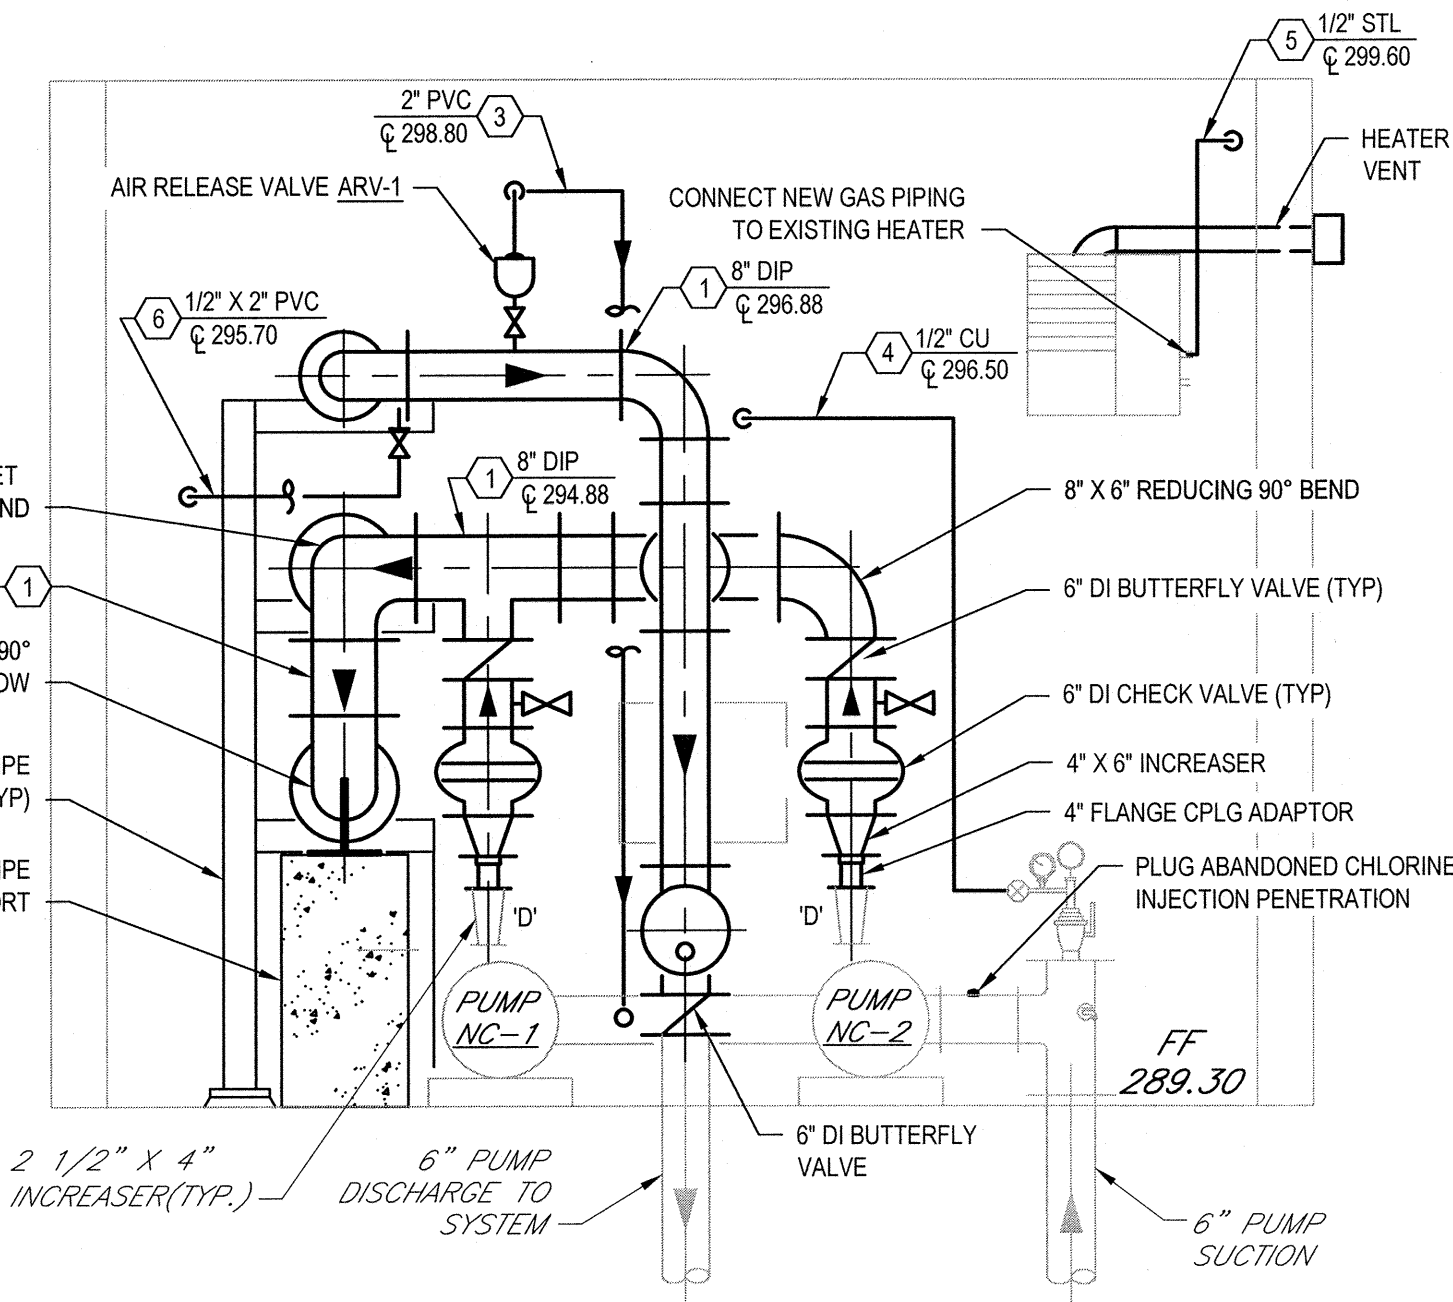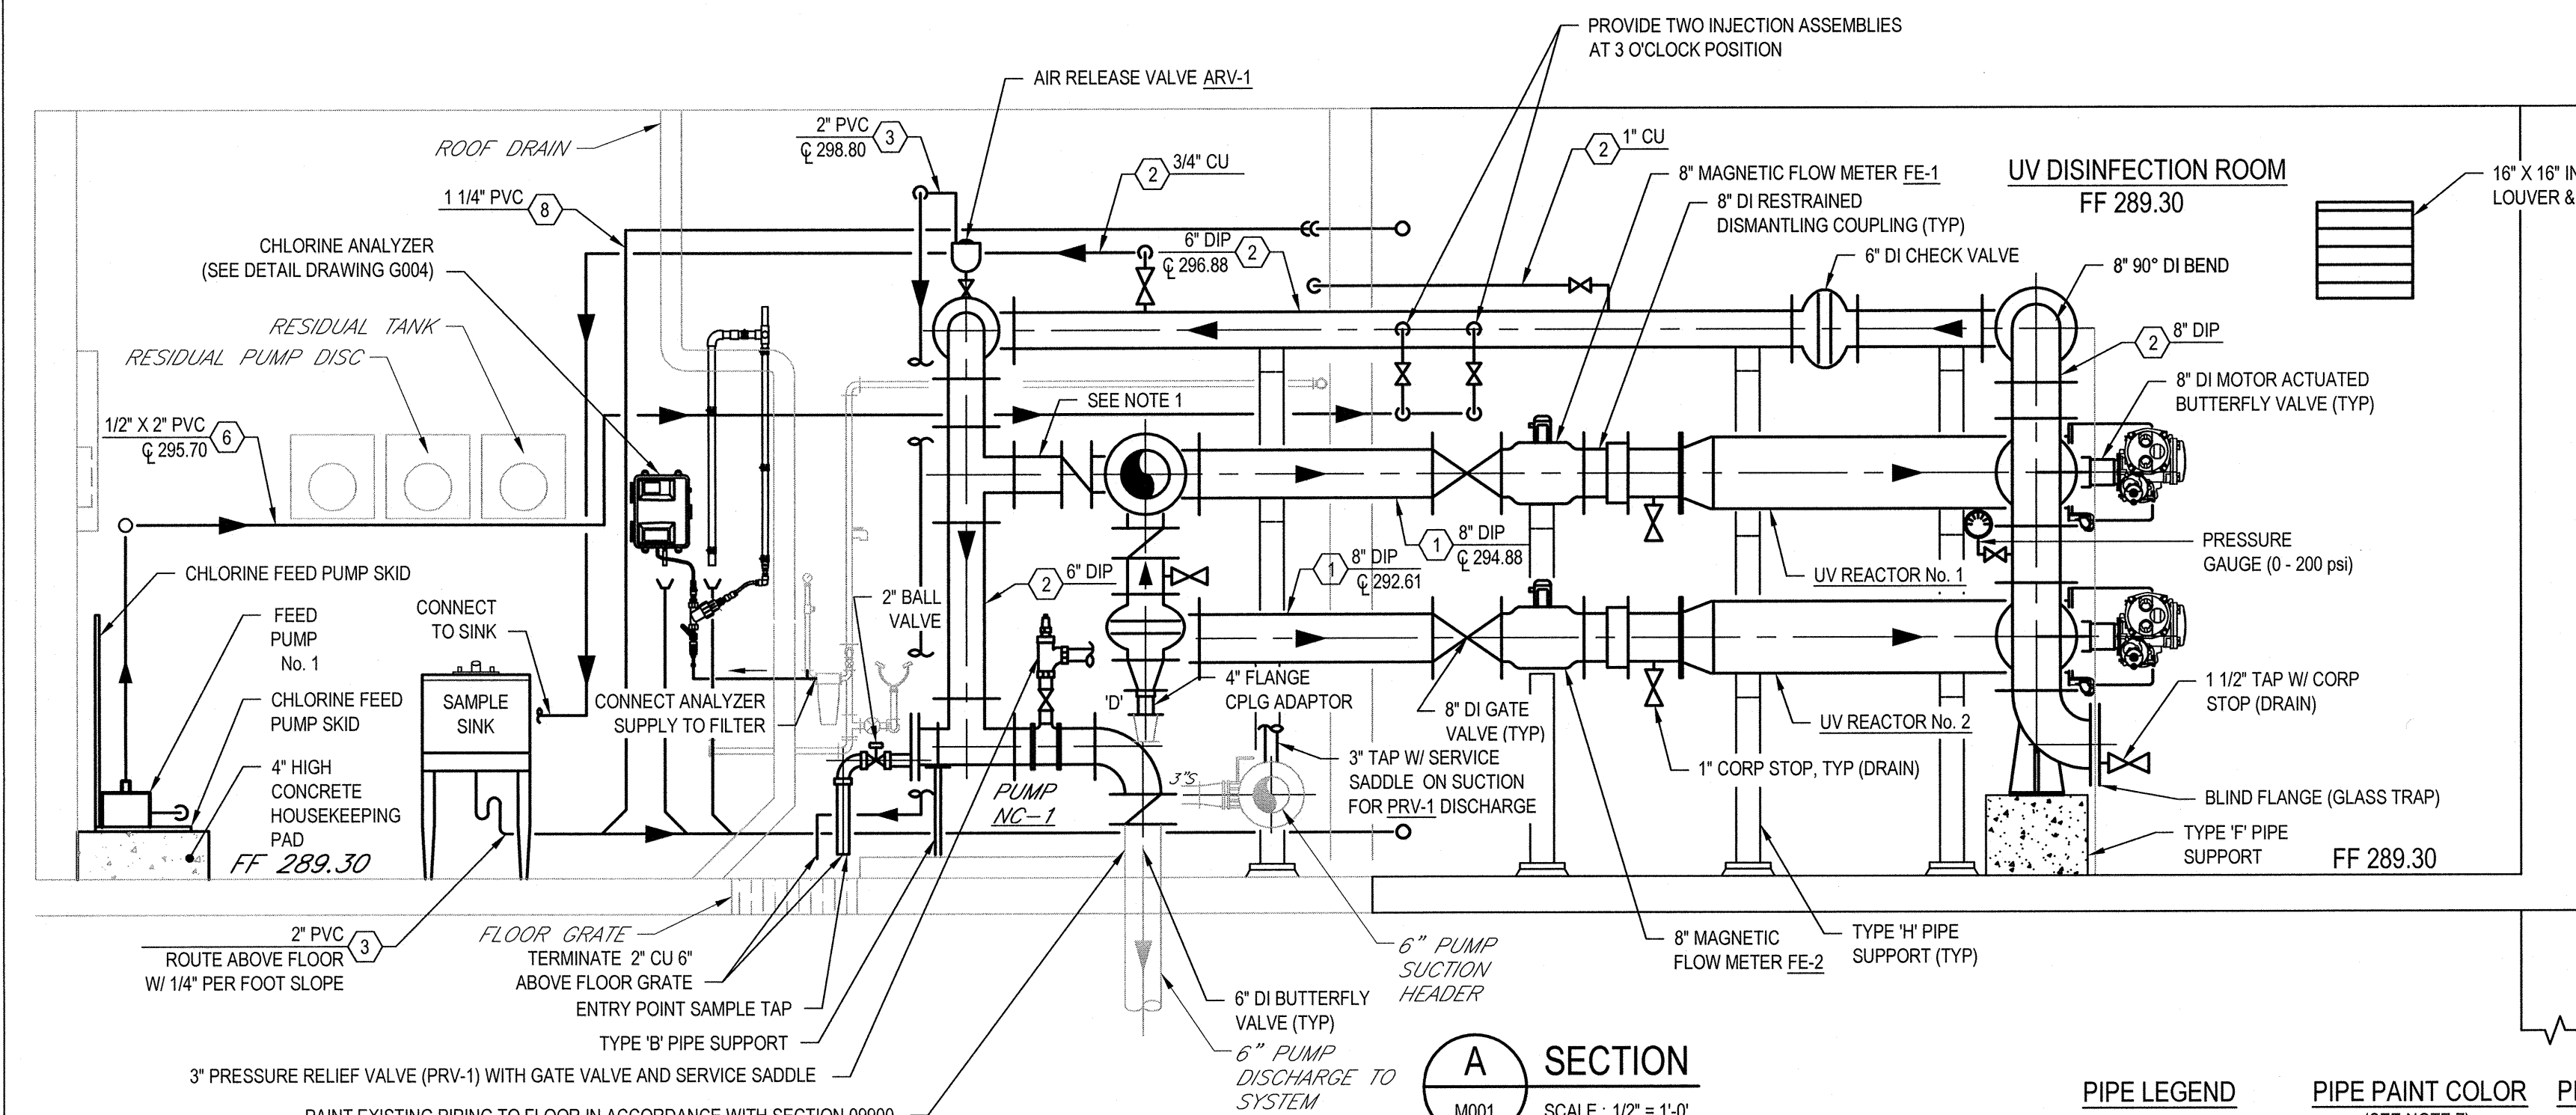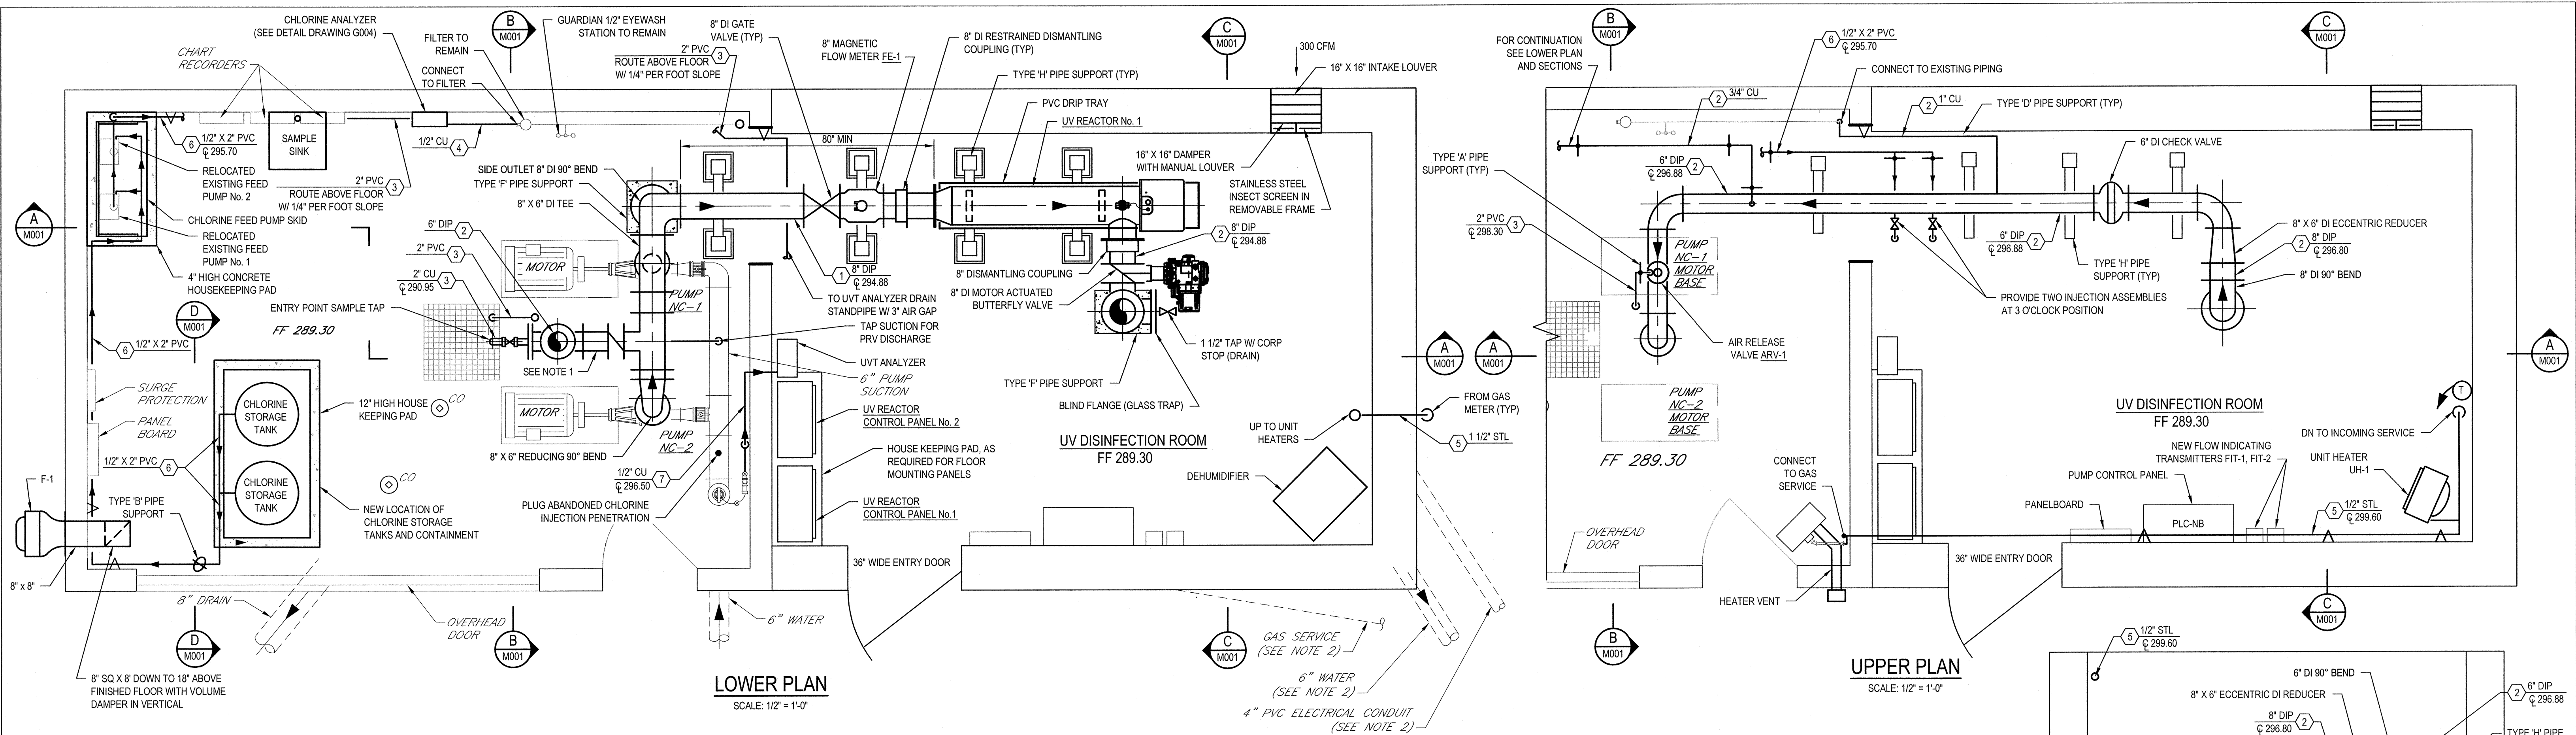

NOTES:

- UPON FINAL ACCEPTANCE OF THE ENTIRE UV SYSTEM, REMOVE 6 INCH SPPOOL PIECE AND 6 INCH BUTTERFLY VALVE. PROVIDE BLIND FLANGES ON THE 6 INCH X 6 INCH TEE AND 8 INCH X 6 INCH TEE.
- EXISTING GAS SERVICE, 6" WATER AND 4" PVC ELECTRICAL CONDUIT TO BE RELOCATED. SEE G003 FOR NEW LOCATIONS.
- PIPING LOCATED UPSTREAM OF THE UV REACTORS SHALL HAVE NO EXPANSIONS OR CONTRACTIONS (REDUCERS) WITHIN 80 INCHES (10 PIPE DIAMETERS) OF THE UV REACTOR INLET FLANGE.
- PIPING CONFIGURATION LOCATED UPSTREAM AND DOWNSTREAM OF THE REACTOR IS IN ACCORDANCE WITH RECOMMENDED STANDARDS FOR WATER WORKS, POLICY STATEMENT OF ULTRAVIOLET LIGHT DISINFECTION FOR TREATMENT OF PUBLIC WATER SUPPLIES.
- MAINTAIN PROPER CLEARANCE PER UV REACTOR'S MANUFACTURER'S REQUIREMENTS FOR MAINTENANCE. REMOVAL AND OPERATION OF UV REACTORS, AS SUCH, CONTRACTOR SHALL OBTAIN WRITTEN CONFIRMATION THAT THE VERTICAL CLEARANCE AS SHOWN IS ACCEPTABLE PRIOR TO ORDERING AND ASSEMBLY AND SHALL BE SUBMITTED TO ENGINEER.
- UV REACTOR SHALL BE UV SWIFT SC BY TROJAN TECHNOLOGIES. PROVIDE VALIDATED CAPACITY OF 480 GPM AT 87 PERCENT UVT. SEE SPECIFICATION SECTION 11390 FOR ADDITIONAL DETAIL.
- REFER TO SPECIFICATION SECTION 09900 FOR PAINTING REQUIREMENTS. PIPE LABELS SHALL BE PROVIDED FOR ALL PIPING PIPING IN ACCORDANCE WITH SPECIFICATION SECTION 09900.
- ALL SAMPLE TAPS SHALL BE PROVIDED WITH TAPPING SADDLE AND SHALL BE SMOOTH-NOSED AT INTERIOR PIPE WALL.
- PROVIDE TWO INJECTION ASSEMBLIES AT 3 O'CLOCK POSITION.
- DUCTWORK SHALL BE GALVANIZED STEEL, MANUFACTURED AND INSTALLED IN ACCORDANCE WITH SMACMA HVAC DUCT CONSTRUCTION STANDARDS.

A SECTION

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PIPE LEGEND

- RAW WATER
- UV TREATED WATER
- DRAIN
- ANALYZER SUPPLY
- NATURAL GAS
- SODIUM HYPOCHLORITE
- UVT ANALYZER SUPPLY
- VENT

PIPE PAINT COLOR

- OLIVE GREEN
- DARK BLUE
- NONE
- NONE
- RED
- NONE
- NONE
- NONE

PIPE LABEL COLOR

- GREEN W/ WHITE LETTERS
- BLUE W/ WHITE LETTERS
- NONE
- BLUE W/ WHITE LETTERS
- **CONFORM TO FUEL GAS CODE
- YELLOW W/ BLACK LETTERS
- GREEN W/ WHITE LETTERS
- NONE

0 FOR CONSTRUCTION

No Revision Note: * Indicates signatures on original issue of drawing or last revision of drawing

Plot Date: 28 October 2015 - 3:34 PM

Plotted by: Jay DeLapp

MRY

NJH

KC

10/15

Drawn

Job Manager

Project Director

Date

NOTES:

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Cazenovia NY 13035 USA
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E cazmail@ghd.com W www.ghd.com

Drawn MRY

Drafting Check M. Young

Approved (Project Director) Kevin J. DeLapp

Date 10/30/15

Scale AS SHOWN

Designer MRY

Design Check M. Young

Contract No. 1

This Drawing shall not be used for Construction unless Signed and Sealed For Construction

Client

Project

Title






Original Size

Arch D

TOWN OF NORTH CASTLE, NEW YORK
NORTH BROADWAY
ULTRAVIOLET DISINFECTION
MECHANICAL PLANS AND SECTIONS
ALTERNATE LAYOUT 1

Drawing No: **86-16786-M001**

Rev: 0

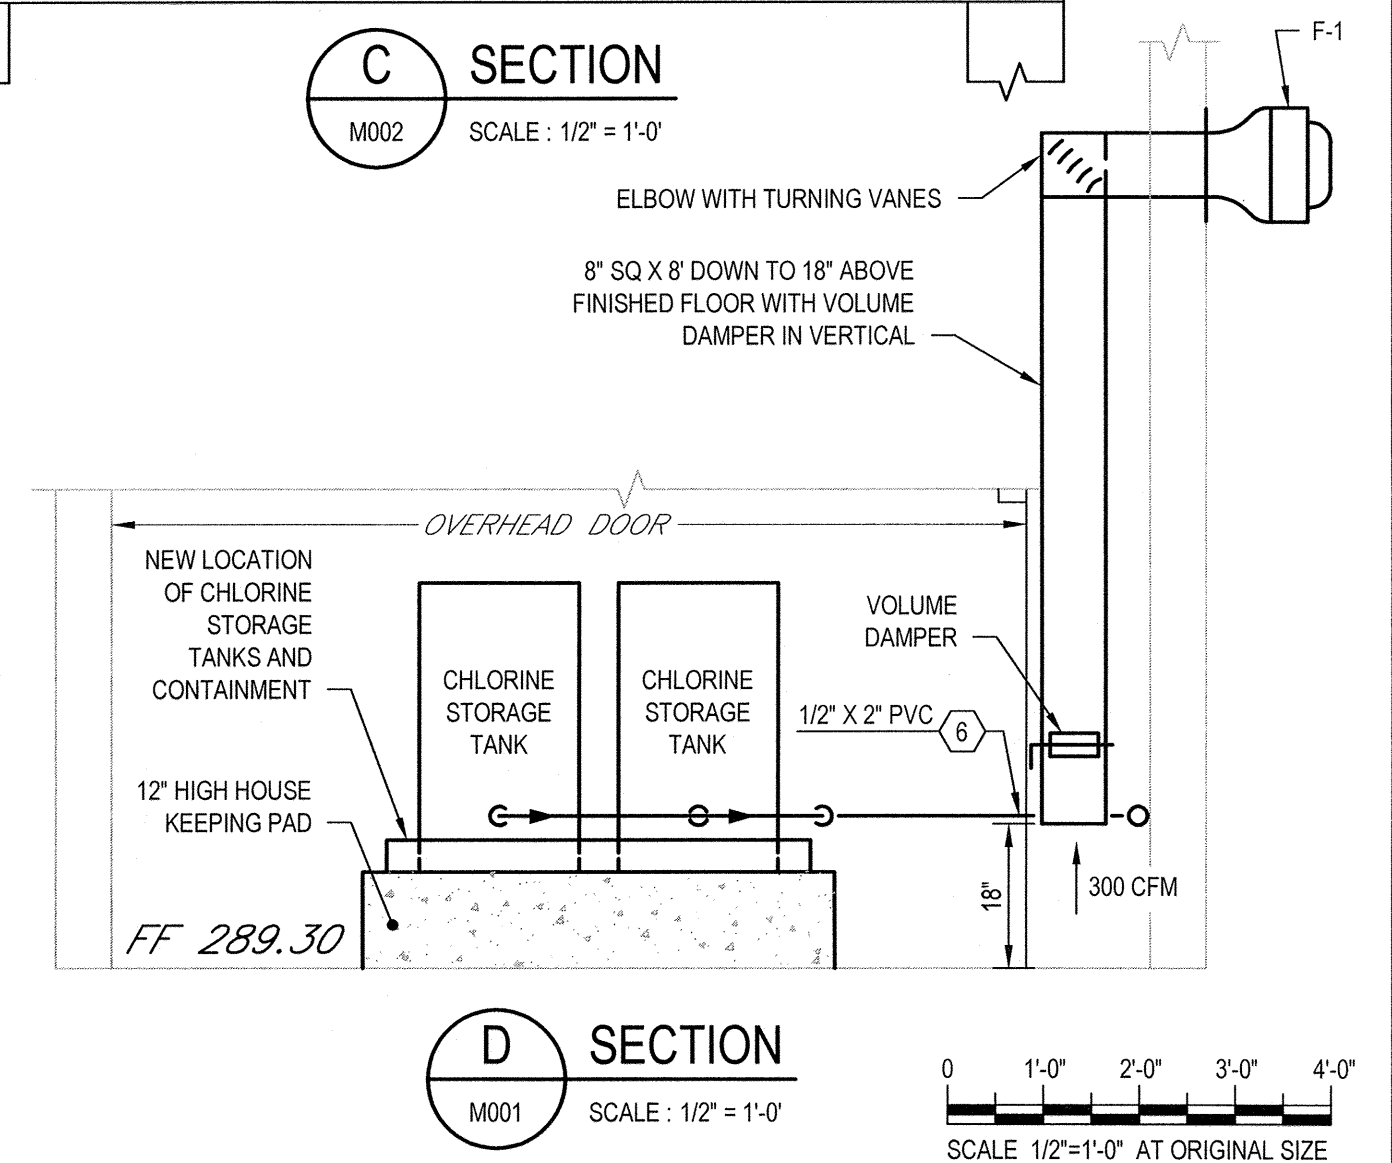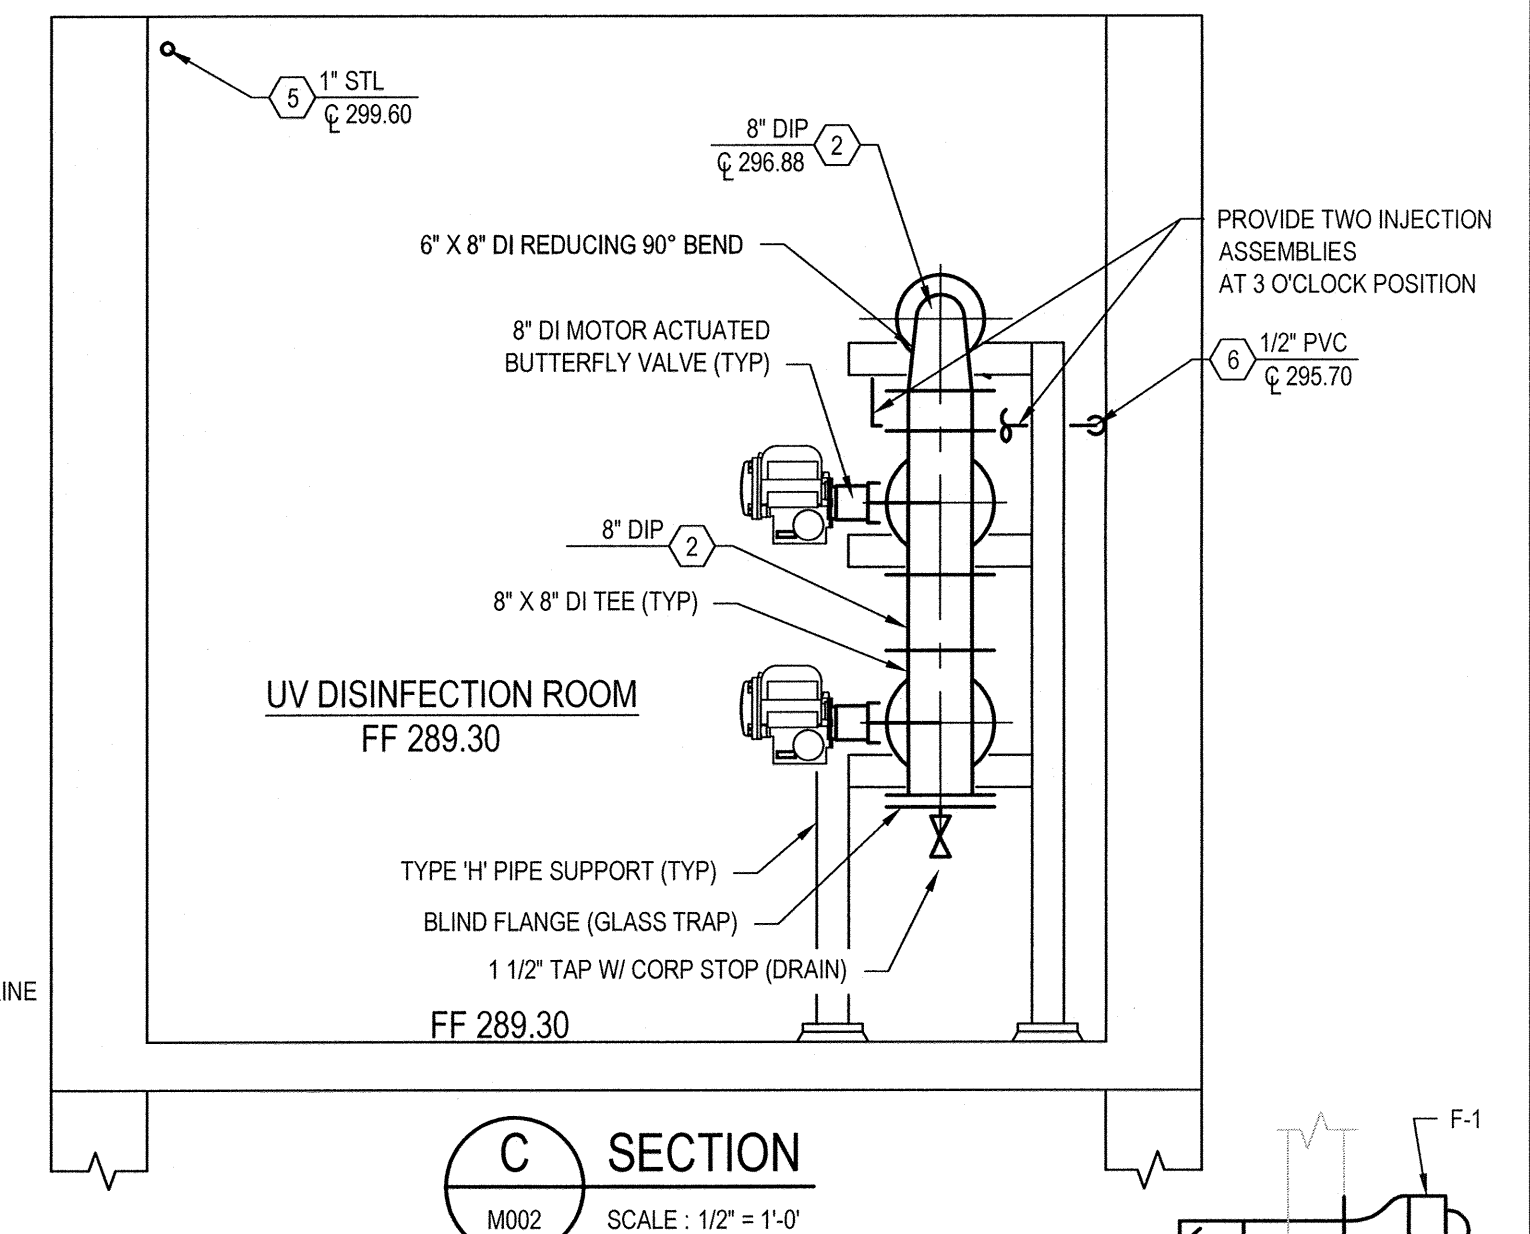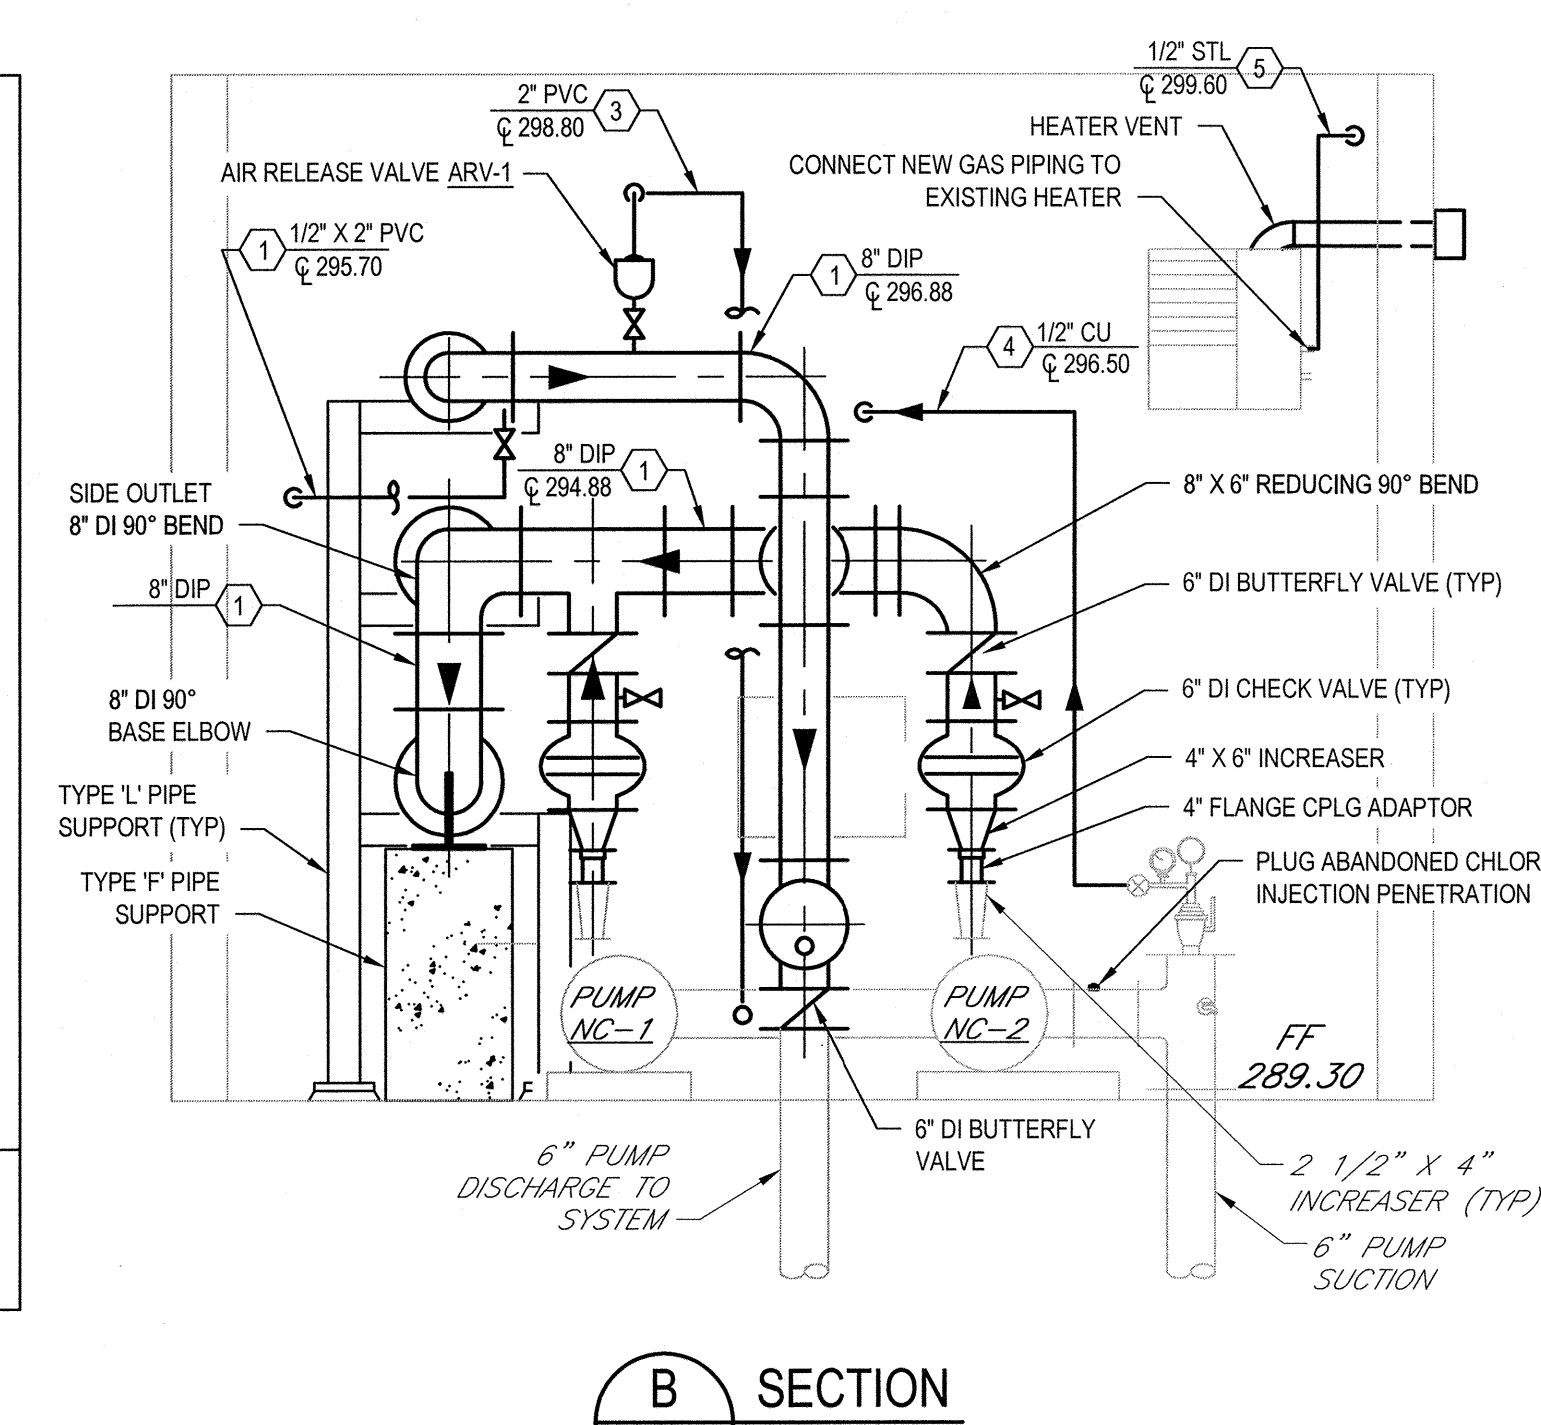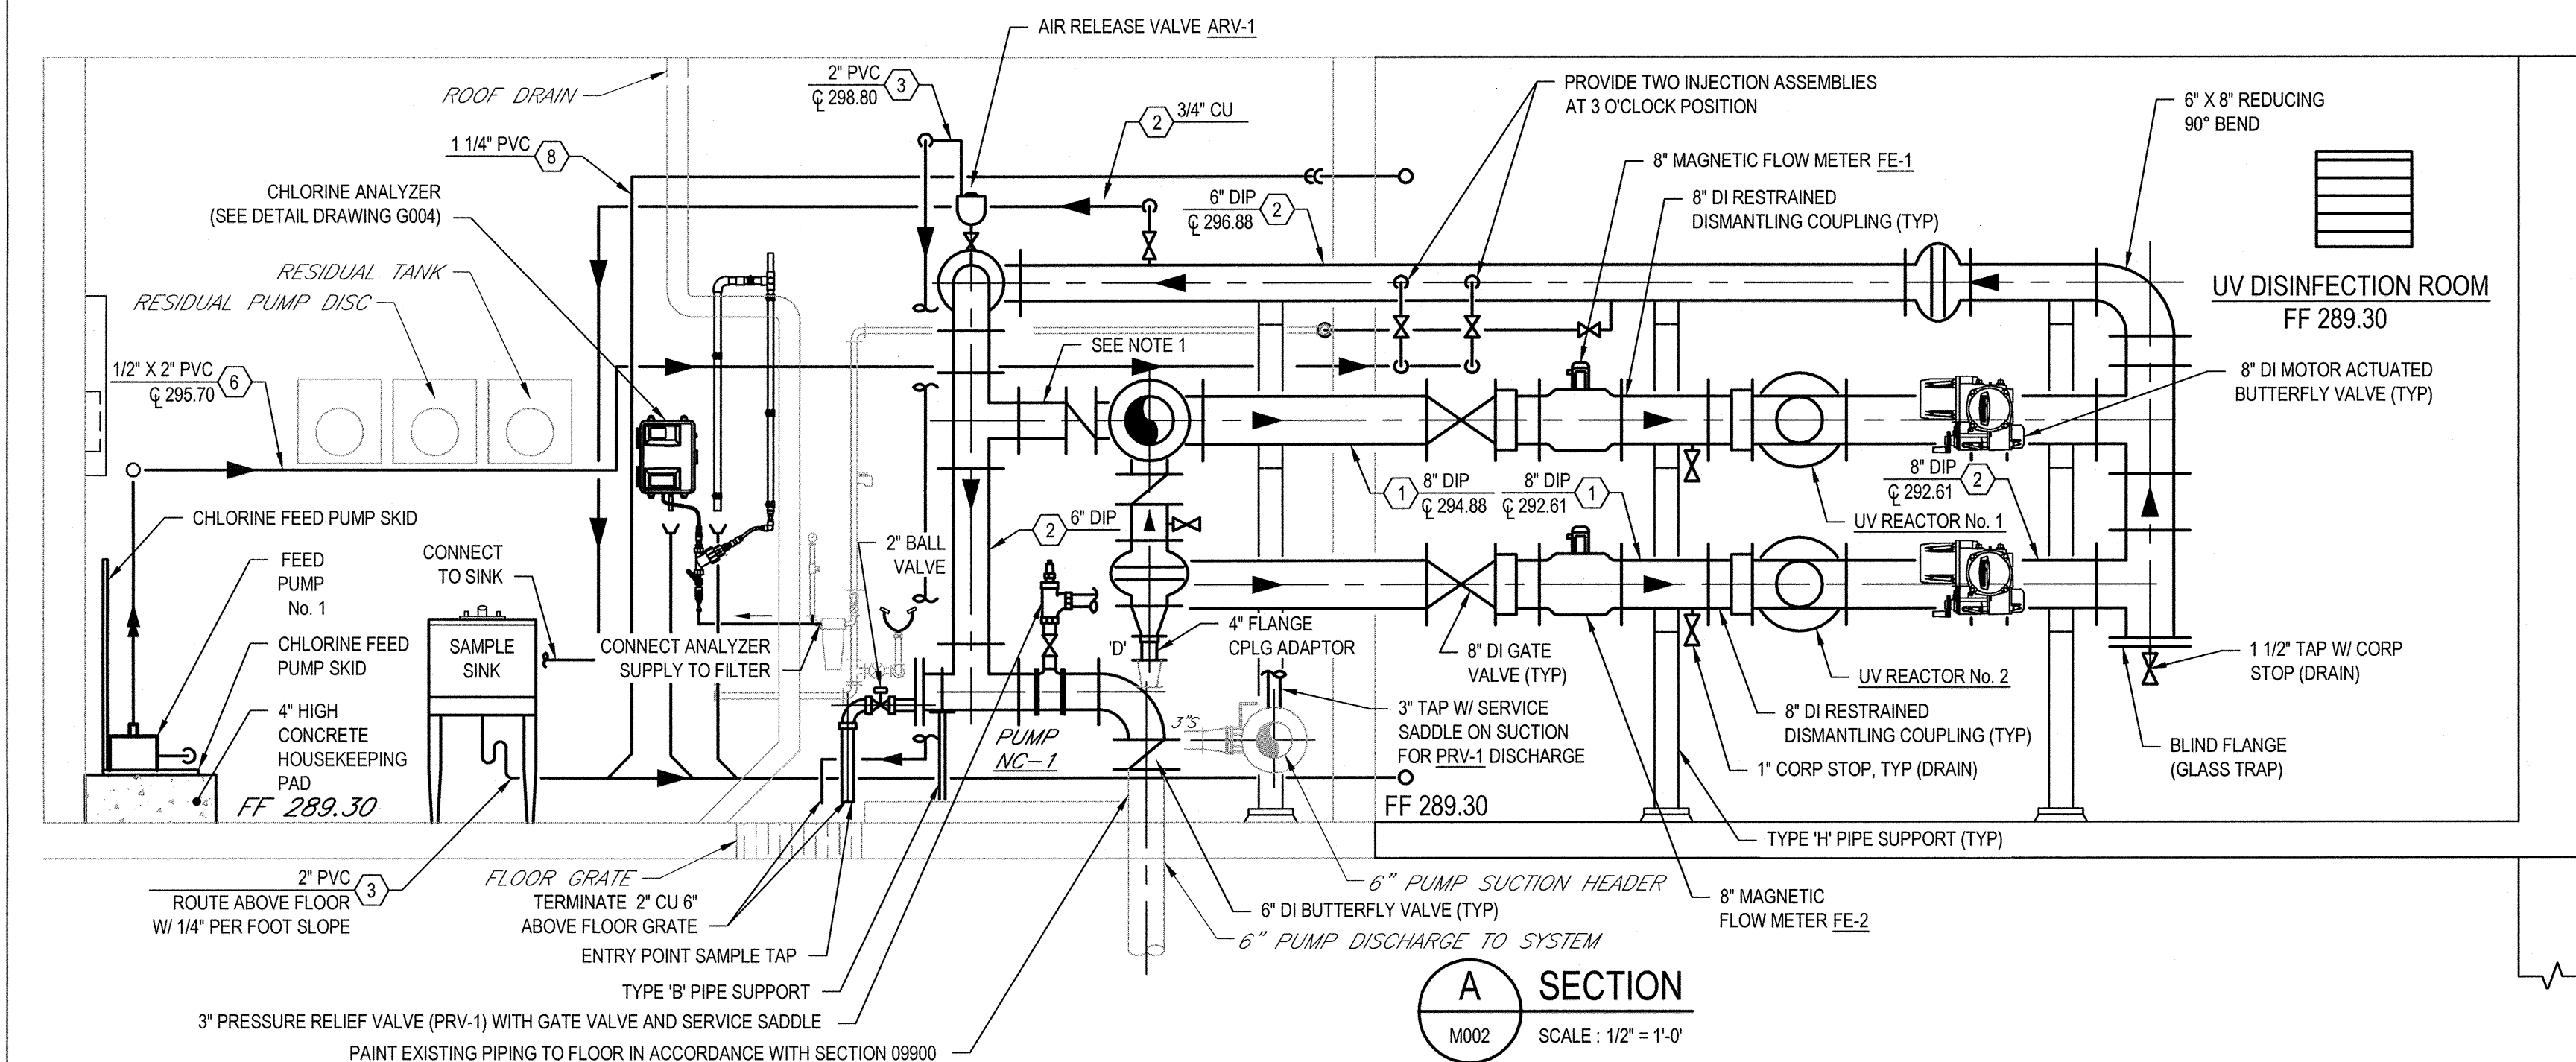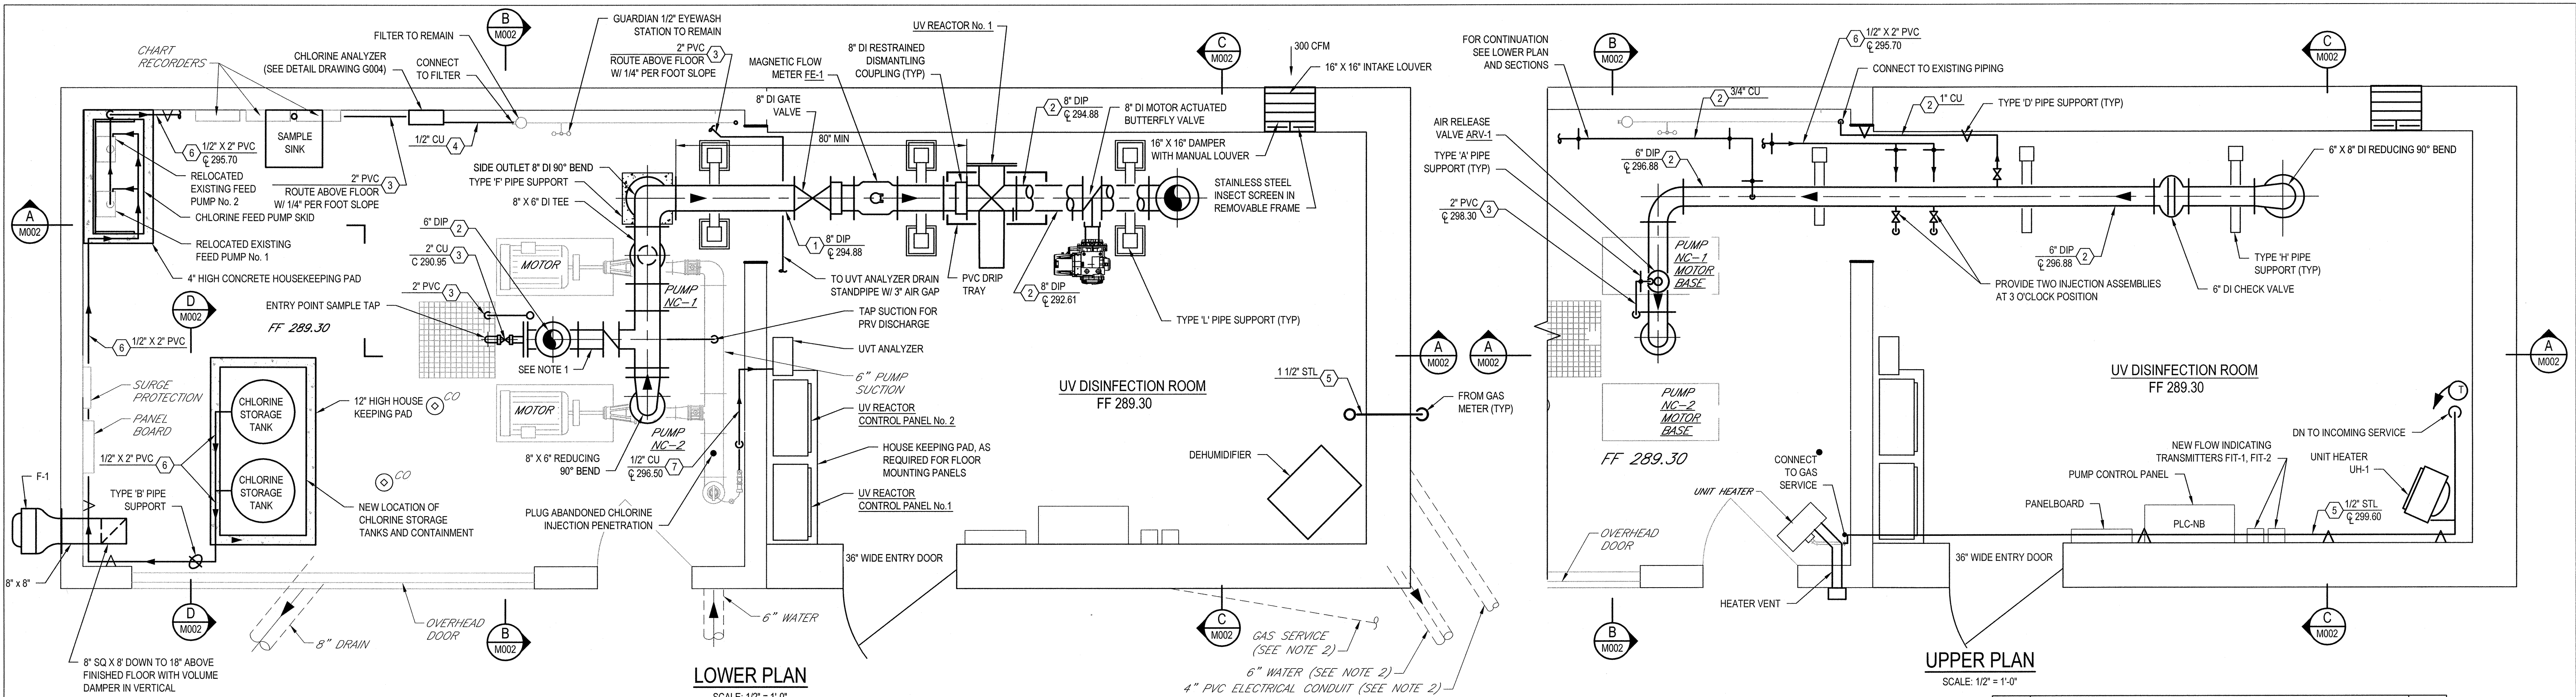

NOTES:

- UPON FINAL ACCEPTANCE OF THE ENTIRE UV SYSTEM, REMOVE 6 INCH SPOOL PIECE AND 6 INCH BUTTERFLY VALVE. PROVIDE BLIND FLANGES ON THE 6 INCH X 6 INCH TEE AND 8 INCH X 6 INCH TEE.
- EXISTING GAS SERVICE, 6" WATER AND 4" PVC ELECTRICAL CONDUIT TO BE RELOCATED. SEE G003 FOR NEW LOCATIONS.
- PIPING LOCATED UPSTREAM OF THE UV REACTORS SHALL HAVE NO EXPANSIONS OR CONTRACTIONS (REDUCERS) WITHIN 80 INCHES (10 PIPE DIAMETERS) OF THE UV REACTOR INLET FLANGE.
- PIPING CONFIGURATION LOCATED UPSTREAM AND DOWNSTREAM OF THE REACTOR IS IN ACCORDANCE WITH RECOMMENDED STANDARDS FOR WATER WORKS, POLICY STATEMENT OF ULTRAVIOLET LIGHT DISINFECTION FOR TREATMENT OF PUBLIC WATER SUPPLIES.
- MAINTAIN PROPER CLEARANCE PER UV REACTOR'S MANUFACTURER'S REQUIREMENTS FOR MAINTENANCE, REMOVAL AND OPERATION OF UV REACTORS. AS SUCH, CONTRACTOR SHALL OBTAIN WRITTEN CONFIRMATION THAT THE VERTICAL CLEARANCE AS SHOWN IS ACCEPTABLE PRIOR TO ORDERING AND ASSEMBLY AND SHALL BE SUBMITTED TO ENGINEER.
- UV REACTOR SHALL BE MODEL SX225 BY ENGINEERED TREATMENT SYSTEMS (ETS). PROVIDE VALIDATED CAPACITY OF 480 GPM AT 87 PERCENT UVT. SEE SPECIFICATION SECTION 11390 FOR ADDITIONAL DETAIL.
- REFER TO SPECIFICATION SECTION 09800 FOR PAINTING REQUIREMENTS. PIPE LABELS SHALL BE PROVIDED FOR ALL PIPING PIPING IN ACCORDANCE WITH SPECIFICATION SECTION 09800.
- ALL SAMPLE TAPS SHALL BE PROVIDED WITH TAPPING SADDLE AND SHALL BE SMOOTH-NOSED AT INTERIOR PIPE WALL.
- PROVIDE PVC DRIP TRAY BETWEEN UV REACTOR No. 1 AND UV REACTOR No. 2.
- DUCTWORK SHALL BE GALVANIZED STEEL, MANUFACTURED AND INSTALLED IN ACCORDANCE WITH SMACMA HVAC DUCT CONSTRUCTION STANDARDS.


PIPE LEGEND

PIPE LEGEND	PIPE PAINT COLOR (SEE NOTE 7)	PIPE LABEL COLOR
1 RAW WATER	OLIVE GREEN	GREEN W/ WHITE LETTERS
2 UV TREATED WATER	DARK BLUE	BLUE W/ WHITE LETTERS
3 DRAIN	NONE	NONE
4 ANALYZER SUPPLY	NONE	BLUE W/ WHITE LETTERS
5 NATURAL GAS	RED	**CONFORM TO FUEL GAS CODE
6 SODIUM HYPOCHLORITE	NONE	YELLOW W/ BLACK LETTERS
7 UVT ANALYZER SUPPLY	NONE	GREEN W/ WHITE LETTERS
8 VENT	NONE	NONE

NOTES:

UNDERGROUND FACILITIES, STRUCTURES, AND UTILITIES HAVE BEEN PLOTTED FROM AVAILABLE SURVEYS AND RECORDS, AND THEREFORE THEIR LOCATIONS MUST BE CONSIDERED APPROXIMATE ONLY. THERE MAY BE OTHERS, THE EXISTENCE OF WHICH IS PRESENTLY NOT KNOWN.

IT IS VIOLATION OF NEW YORK STATE EDUCATION LAW FOR ANY PERSON UNLESS ACTING UNDER THE DIRECTION OF A LICENSED PROFESSIONAL ENGINEER, TO ALTER AN ITEM ON THIS DRAWING IN ANYWAY. IF AN ITEM IS ALTERED, THE ALTERING ENGINEER SHALL AFFIX TO THE ITEM HIS/HER SEAL AND THE NOTATION "ALTERED BY" FOLLOWED BY HIS/HER SIGNATURE AND DATE OF SUCH ALTERATION AND A SPECIFIC DESCRIPTION OF THE ALTERATION.

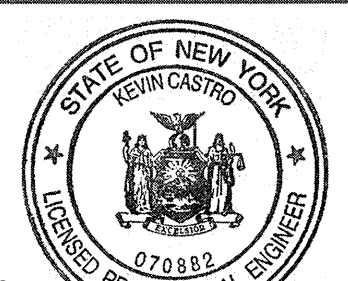

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Drawn MRY

Designer MRY

Drafting Check M. H.

Design Check M. H.

Approved (Project Director)

Contract No. 1

Date 10/30/15

Scale AS SHOWN

Client **TOWN OF NORTH CASTLE, NEW YORK**
Project **NORTH BROADWAY
ULTRAVIOLET DISINFECTION
MECHANICAL PLANS AND SECTIONS
ALTERNATE LAYOUT 2**
Title
Original Size
Arch D Drawing No: **86-16786-M002**
Rev: 0

Plot Date: 28 October 2015 - 3:35 PM



Plotted by: Jay DeLapp

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A or AMP	AMPERE AMPS
AC	ALTERNATING CURRENT
AF	AMPERE FRAME SIZE
AF	ABOVE FINISHED FLOOR
AIC	AMPS INTERRUPTING CURRENT
AIT	ANALYZING INDICATING TRANSMITTER
AT	AMPERE TRIP RATING
ATS	AUTOMATIC TRANSFER SWITCH
AUX	AUXILIARY
AWG	AMERICAN WIRE GAUGE
BKR	BREAKER
C or COND	CONDUIT
CA	CABLE
CB	CIRCUIT BREAKER
CEMS	CONTINUOUS EMISSIONS MONITORING SYSTEM
CIRC	CIRCUIT
CMU	CONCRETE MASONRY UNIT
COMP	COMPARTMENT
CP	CONTROL PANEL
CS	CONTROL STATION
CPT	CONTROL POWER TRANSFORMER
CON	CONCRETE
CR	CONTROL RELAY
CT	CURRENT TRANSFORMER
DC	DIRECT CURRENT
DIA	DIAMETER
DIP	DUCTILE IRON PIPE
EA	EACH
ESTOP	EMERGENCY STOP
ETM	ELAPSED TIME METER
EW	EACH WAY
F & I	FURNISHED & INSTALLED
FIT	FLOW INDICATING TRANSMITTER
FE	FLOW ELEMENT
FLEX	FLEXIBLE
FVNR	FULL VOLTAGE NON REVERSING
FVR	FULL VOLTAGE REVERSING
FVTS	FULL VOLTAGE TWO SPEED
GEN	GENERATOR
GENSET	EMERGENCY POWER GENERATOR
GRD	GROUND
H	HORIZONTAL
HOA	HAND-OFF-AUTO SELECTOR SWITCH
HP	HORSE POWER
IL	INDICATING LIGHT
I/O	INPUT/OUTPUT
ISR	INTRINSICALLY SAFE RELAY
JB	JUNCTION BOX
KCMIL	THOUSAND CIRCULAR MILS
KW	KILOWATT
LA	LIGHTNING ARRESTOR
LE	LEVEL ELEMENT
LIT	LEVEL INDICATING TRANSMITTER
mA	MILLIAMPS
MAG	MAGNETIC
MAX	MAXIMUM
MCC	MOTOR CONTROL CENTER
MDP	MAIN DISTRIBUTION PANEL
MFR	MANUFACTURER
MIN	MINIMUM
Mx	MOTOR CONTACTOR AUXILIARY CONTACT
NC	NORMALLY CLOSED
NEC	NATIONAL ELECTRIC CODE
NEMA	NATIONAL ELECTRICAL MANUFACTURERS ASSOC.
NO	NORMALLY OPEN
NP	NAMEPLATE
OC	ON CENTER
OL	OVERLOAD RELAY
Ø	PHASE OR DIAMETER
P	POLE
PB	PUSHBUTTON
PBX	PULL BOX
PF	PULLING FITTING
PLC	PROGRAMMABLE LOGIC CONTROLLER
PVC	POLYVINYL CHLORIDE
RAS	RETURN ACTIVATED SLUDGE
RGS	RIGID GALVANIZED STEEL (CONDUIT)
ROC	RUN OF CRUSH
SA	SURGE ARRESTOR
SEC	SECOND
SCADA	SYSTEM CONTROL AND DATA ACQUISITION
SHLD	SHIELDED
SL	STOPILOCKOUT SWITCH
SEL or SEL SW	SELECTOR SWITCH
SS	STAINLESS STEEL
S/S	STOP/START PUSH BUTTON
STR	STRAINED
SV	SOLENOID VALVE
SW	SWITCH
TERM	TERMINAL
TRANS	TRANSFORMER
TSP	TWISTED SHIELDED PAIR
TST	TWISTED SHIELDED TRIAD
Typ	TYPICAL
UCON	UNLESS OTHERWISE NOTED
UPS	UNINTERRUPTIBLE POWER SUPPLY
V	VOLTS OR VERTICAL
VA	VOLT-AMPERES
VFD	VARIABLE FREQUENCY DRIVE
W/	WITH
WAS	WASTE ACTIVATED SLUDGE
WP	WEATHER PROOF, WATER PROOF
XP	EXPLOSION PROOF
YI	FAILURE INDICATION
Y/N	RUN INDICATION

	MOMENTARY OPEN PUSHBUTTON (NORMALLY OPEN)
	MOMENTARY CLOSED PUSHBUTTON (NORMALLY CLOSED)
	THREE POSITION MAINTAINED CONTACT SELECTOR SWITCH
	FOUR POSITION MAINTAINED CONTACT SELECTOR SWITCH
	NORMALLY OPEN CONTACT
	NORMALLY CLOSED CONTACT
	LIMIT SWITCH
	FLOAT SWITCH
	INDICATING LIGHT * = COLOR R - RED W - WHITE G - GREEN A - AMBER
	PUSH-TO-TEST INDICATING LIGHT
	NAME PLATE
	RED MUSHROOM HEAD PUSHBUTTON(MAINTAINED)
	MOUNTING STAND
	CONTROL RELAY
	MOTOR STARTER CONTACTOR COIL
	ELAPSED TIME METER
	FLEXIBLE CONDUIT
	WIRES CONNECTED
	WIRES NOT CONNECTED
	CURRENT LIMITING FUSE
	SWITCH WITH CURRENT LIMITING FUSE
	MOLDED CASE CIRCUIT BREAKER
	CONTINUOUS RATING SA MCP MOTOR CIRCUIT PROTECTOR-TRIP RANGE SETTING BASED ON ACTUAL MOTOR FULL LOAD AMPS
	CONTACTOR TYPE AND NEMA SIZE AS REQUIRED FOR MOTOR FULL LOAD AND CHARACTERISTICS
	OVERLOAD HEATERS OR RELAY
	SQUIRREL CAGE INDUCTION MOTOR AND HP HP, VARIES
	CB-1 DOOR CALL OUT
	DOOR NUMBER
	BUILDING ABBREVIATION
	APPROXIMATE DOOR LOCATION

1. ALL WORK SHALL BE DONE IN ACCORDANCE WITH THE NATIONAL ELECTRICAL CODE, THESE CONTRACT DOCUMENTS AND ALL LOCAL AUTHORITIES HAVING JURISDICTION.
2. FURNISH AND INSTALL ALL MATERIAL, LABOR, EQUIPMENT AND SUPPLIES, TOGETHER WITH ALL RELATED AND REQUIRED APPURTENANCES TO PROVIDE A COMPLETE AND OPERATING SYSTEM. IT IS THE SOLE RESPONSIBILITY OF THE CONTRACTOR TO DETERMINE THE AMOUNT OF MATERIALS REQUIRED.
3. THE CONTRACTOR SHALL OBTAIN AND PAY FOR ALL PERMITS, INSPECTIONS AND APPROVALS REQUIRED.
4. PROVIDE FULLY LABELED AS-BUILT DRAWINGS IN ACCORDANCE WITH SECTIONS 16055 AND 01700. DRAWINGS SHALL SHOW CONDUIT RUNS AND DESTINATION, WIRE TERMINAL NO.'S AND GENERAL ROUTING. DIMENSION BURIED CONDUIT OFF BUILDINGS.
5. AFTER REMOVAL OF EXISTING ELECTRICAL FACILITIES SHOWN OR SPECIFIED TO BE DEMOLISHED, THE CONTRACTOR SHALL REPAIR OR SEAL ALL HOLES IN THE STRUCTURE AND PROVIDE ALL PLANKS AND COVERS TO CLOSE UP ALL HOLES IN REMAINING ELECTRICAL WORK. RE-LABEL ALL DIRECTORIES.
6. PROVIDE SHOP DRAWINGS FOR ALL EQUIPMENT IN ACCORDANCE WITH SECTION 01300 FOR ENGINEER'S REVIEW.
7. NOT ALL CONDUIT IS SHOWN ON THE PLANS. REFER TO SCHEMATIC DIAGRAMS FOR CONDUIT AND CONDUCTOR SIZES AND QUANTITIES. EXACT LOCATION OF CONDUIT INSTALLATION SHALL BE DETERMINED BY THE CONTRACTOR IN THE FIELD. UNLESS SPECIFICALLY DIMENSIONED ON THE PLANS, CONDUIT INSTALLATION SHALL BE IN ACCORDANCE WITH SPECIFICATION 16055. CONDUIT SHALL BE INSTALLED SO AS TO NOT CAUSE TRIPPING HAZARDS. RUN CONDUIT AROUND WORK AREAS, OR INSTALL OVERHEAD - MIN. 7'-0" CLEARANCE. ALL CONDUIT TO BE RIGIDLY INSTALLED.
8. ALL EQUIPMENT SHALL BE INSTALLED IN ACCORDANCE WITH MANUFACTURER'S RECOMMENDATIONS AND ALL APPLICABLE LOCAL, STATE AND FEDERAL REGULATIONS.
9. EXACT EQUIPMENT LOCATIONS SHALL BE DETERMINED IN THE FIELD UNLESS SPECIFICALLY DIMENSIONED ON THE PLANS.
10. ALL INTERIOR ELECTRICAL CONDUIT SHALL BE PARALLEL TO BUILDING WALLS AND BEAMS UNLESS OTHERWISE SHOWN. SUPPORT ALL CONDUIT PER NEC.
11. TWISTED SHIELDED PAIR (TSP) AND TWISTED SHIELDED TRIAD (TST) CONDUCTORS CARRYING DATA COMMUNICATION SIGNALS SHALL BE INSTALLED IN RIGID STEEL CONDUIT OR PVC COATED RIGID STEEL CONDUIT ONLY. POWER DISTRIBUTION AND CONTROL CONDUCTORS SHALL NOT BE INSTALLED IN CONDUIT CARRYING INSTRUMENTATION CONDUCTORS. EXCEPTION - 24 VOLT CONTROL CAN BE INSTALLED WITH 4-20mA CABLE.
12. MOUNT ALL CONDUIT, BOXES AND ENCLOSURES OFF WALLS BY 1/4".
13. ALL PENETRATIONS THROUGH EXISTING CONCRETE STRUCTURES SHALL BE CORE DRILLED AND SIZED TO ACCEPT MECHANICAL LINK SEALS. CONDUIT THROUGH MASONRY WALLS SHALL HAVE HOLES CORE DRILLED AND THE SPACE PATCHED WITH NON-SHRINK GROUT. HOLES THROUGH METAL SECTIONS OF BUILDINGS SHALL BE NEATLY CUT.
14. EXPANSION FITTINGS SHALL BE FURNISHED AND INSTALLED WHERE CONDUIT PASSES ACROSS STRUCTURAL EXPANSION JOINTS, OR STRAIGHT CONDUIT RUNS ARE OVER 50 FEET IN LENGTH.
15. THE CONTRACTOR SHALL FURNISH AND INSTALL ALL SUPPORTS, ANGLES, BRACKETS, ETC., REQUIRED FOR PROPER INSTALLATION OF THE ELECTRICAL SYSTEM.
16. EACH CONDUIT OR GROUP OF CONDUITS SHALL BE LABELED AS TO DESTINATION.
17. NO TERMINATION SHALL BE MADE IN WIREWAYS OR PULLBOXES. PROVIDE TERMINAL STRIPS IN ALL JUNCTION BOXES 100 CUBIC INCHES OR LARGER. OVERSIZE BOXES AS REQUIRED.
18. EXISTING PIPING AND FACILITIES SHOWN LIGHT, NEW PIPING AND FACILITIES SHOWN DARK. ITEMS TO BE DEMOLISHED ARE SPECIFICALLY LABELED ON THESE DRAWINGS.
19. CONTRACTOR IS TO VERIFY AND COORDINATE ALL EXISTING STRUCTURE AND PIPING ELEVATIONS, LOCATIONS, SIZE AND TYPE OF MATERIAL WITH NEW PIPING PRIOR TO CONSTRUCTION. IF DISCREPANCIES ARISE BETWEEN THESE CONTRACT DRAWINGS AND ACTUAL FIELD CONDITIONS, THE CONTRACTOR SHALL NOTIFY ENGINEER IMMEDIATELY IN WRITING.
20. IN GENERAL ALL NEW WORK OR WORK TO BE MODIFIED IS SHOWN VIA A HEAVY LINE.
21. CONTRACTOR RESPONSIBLE TO REPAIR/PATCH ALL PENETRATIONS AND/OR OPENINGS AS A RESULT FROM THEIR WORK.

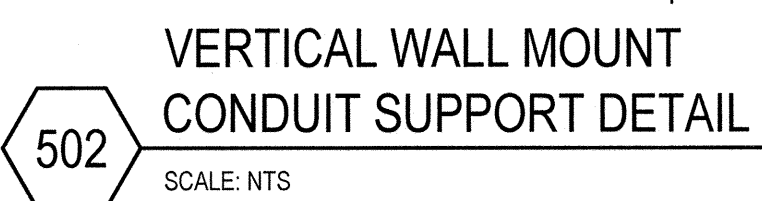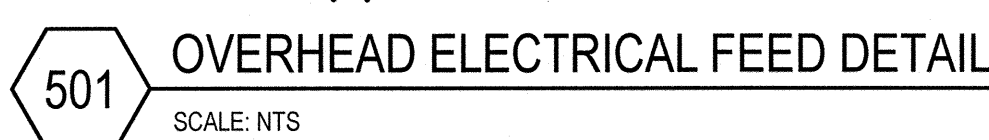


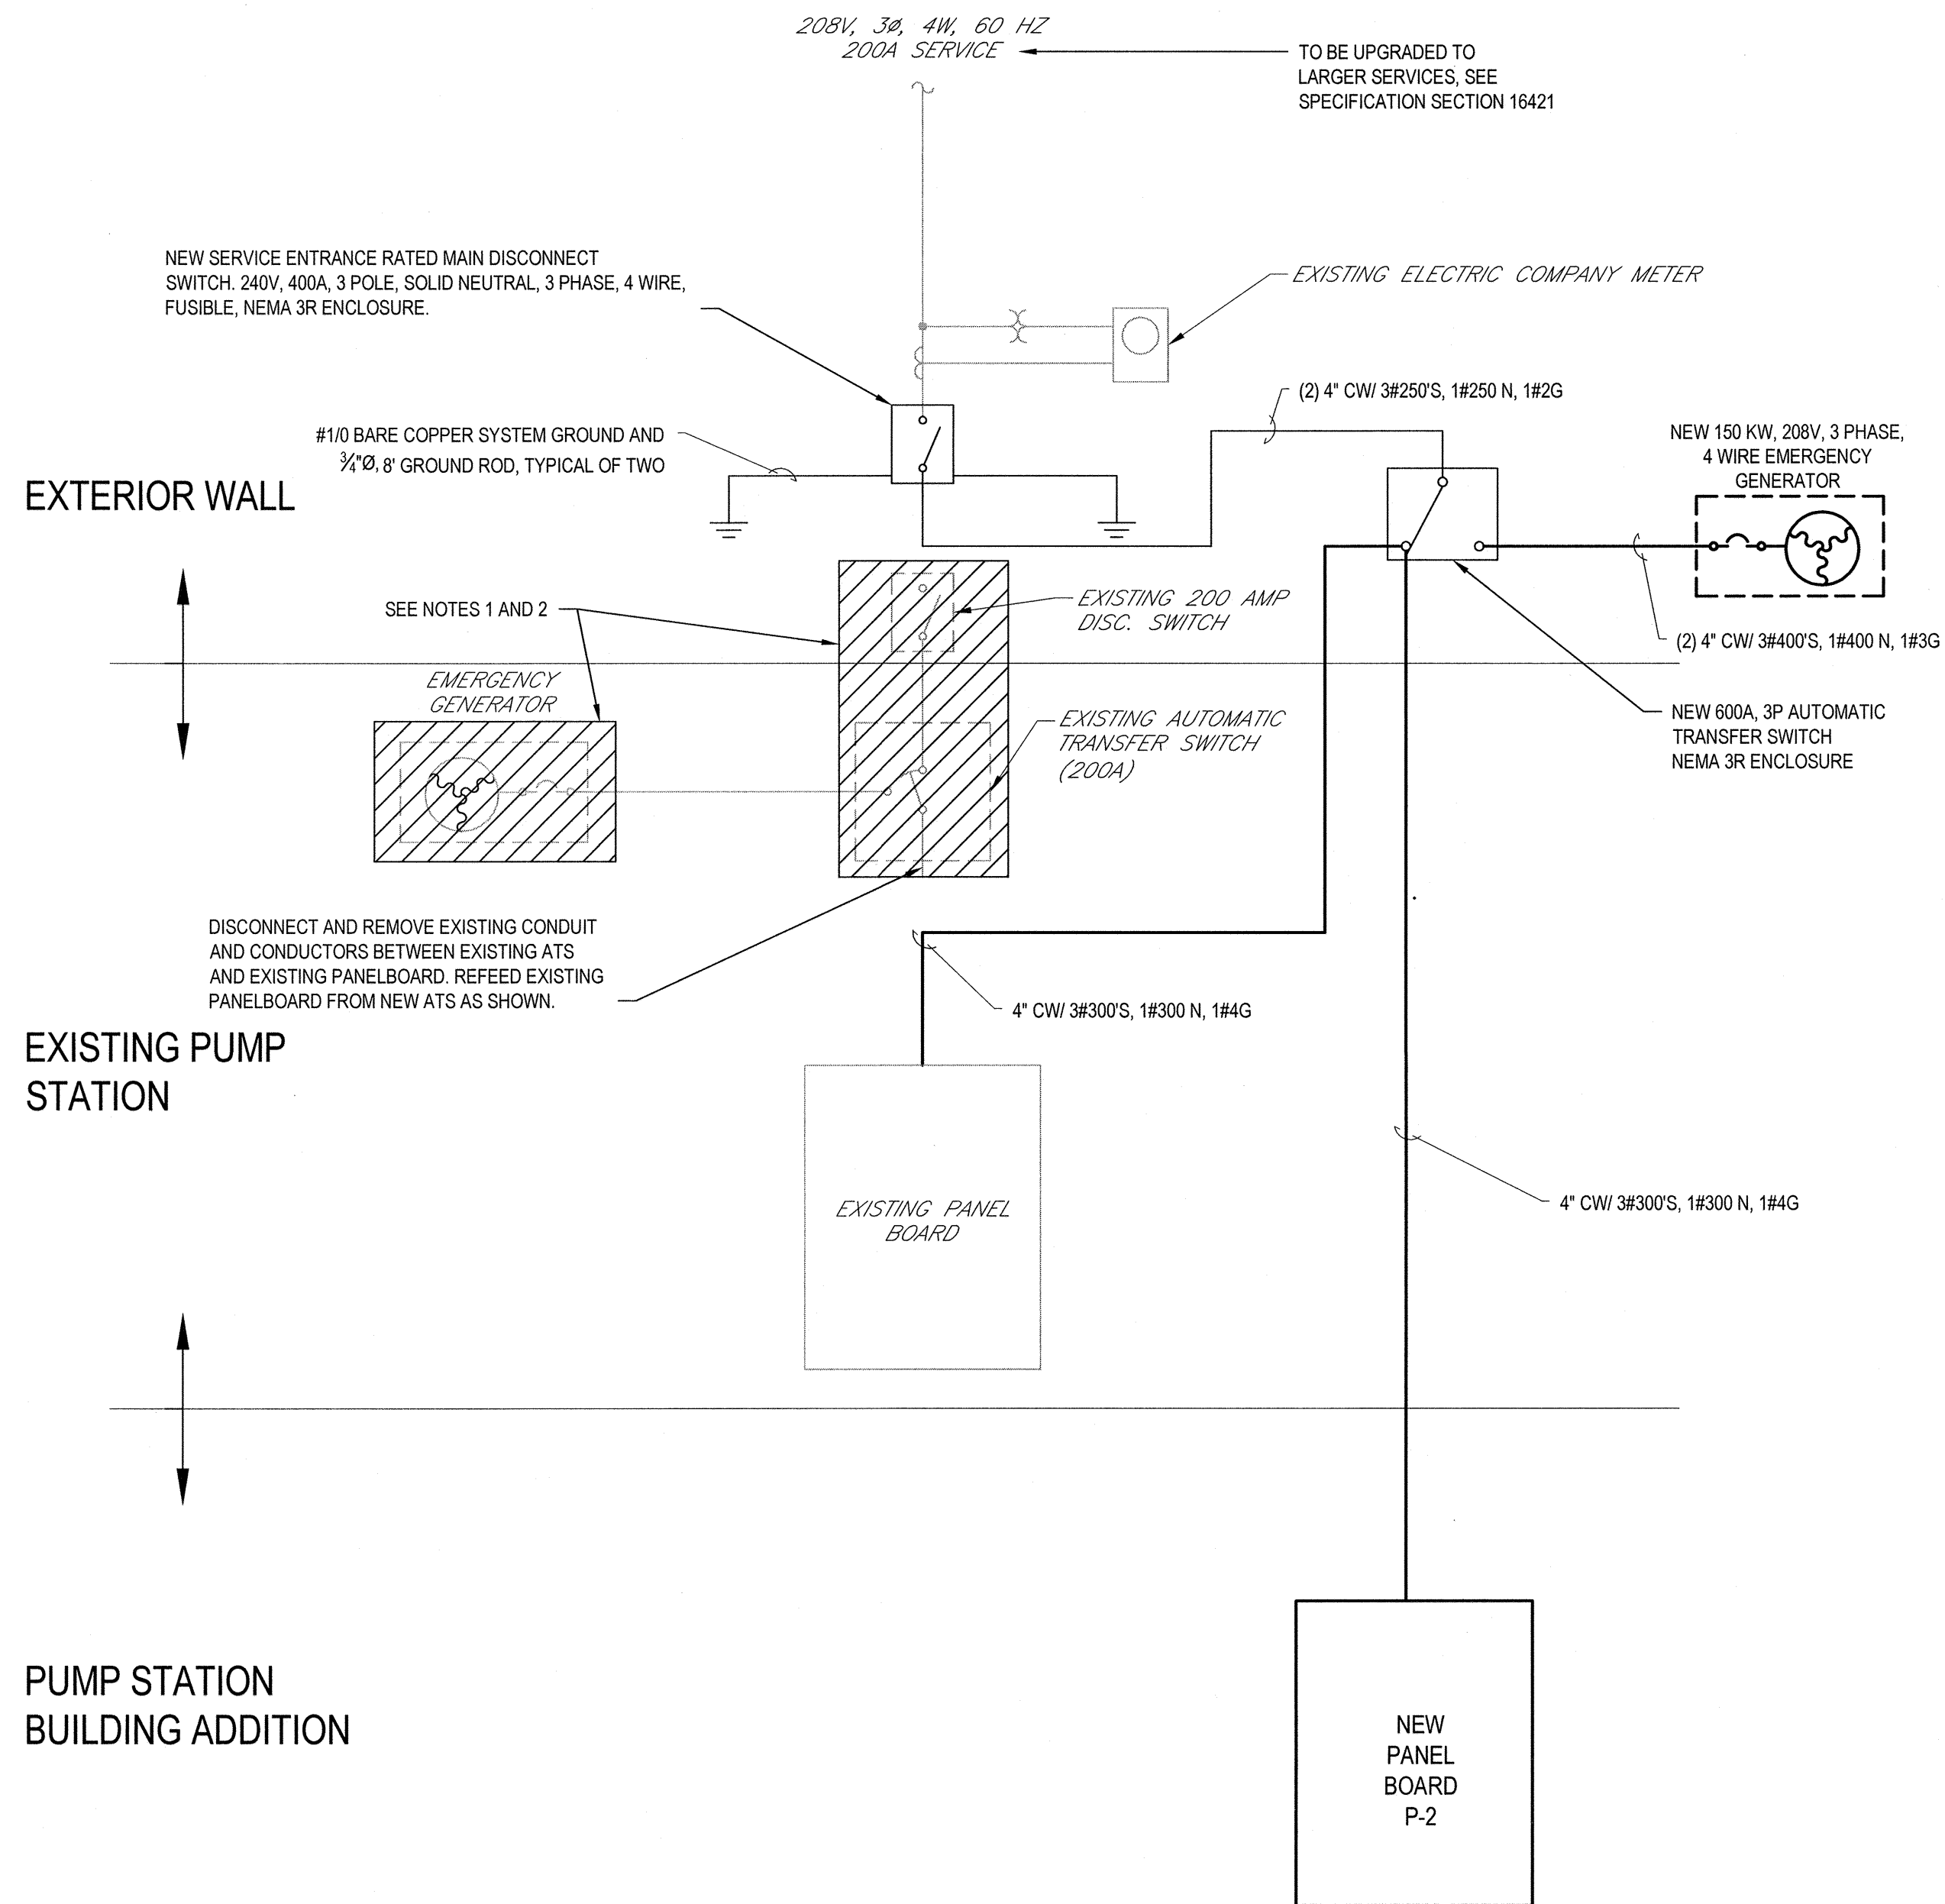
1. ELECTRIC ACTUATOR DETAIL IS TYPICAL FOR INSTALLATION ON BUTTERFLY, PINCH, PLUG, GATE VALVES, WIER, SLUICE AND SLIDE GATES, ETC. ACTUATOR ORIENTATION SHALL BE COORDINATED FOR EACH SPECIFIC VALVE INSTALLATION.
2. DETAIL IS SHOWN WITH AN INTEGRAL CONTROL STATION. PROVIDE REMOTE CONTROL STATIONS WHERE SPECIFIED OR SHOWN ON THE CONTRACT DRAWINGS. REMOTE CONTROL STATIONS SHALL BE PROVIDED WITH CONDUIT AND CONTROL CONDUCTORS BACK TO THE MOTOR TERMINAL BOX. CONTROL CONDUCTOR QUANTITIES AND CONNECTIONS SHALL BE COORDINATED WITH THE GATE VALVE MANUFACTURER.
3. ELECTRIC ACTUATORS SHALL BE PROVIDED WITH DISCONNECT SWITCHES LOCATED ADJACENT TO EACH ACTUATOR REGARDLESS IF SHOWN ON THE PLANS. POWER AND CONTROL CONDUITS SHALL BE PROVIDED AS SHOWN ON THE DETAIL AND MAY NOT BE SCHEDULED OR SHOWN ON THE PLANS FOR CLARITY.
4. ALL CONNECTIONS SHALL BE MADE TO THE BOTTOM OF THE OPERATOR. PROVIDE ADDITIONAL PULLBOXES OR JUNCTION BOXES W/ DRAIN FITTINGS. BOX TO BE INSTALLED BELOW OPERATOR.

905 SCALE: NTS

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Drawn IDG		Designer IDG		Client	TOWN OF NORTH CASTLE, NEW YORK	
Drafting Check TWD		Design Check TWD		Project	NORTH BROADWAY ULTRAVIOLET DISINFECTION	
Approved (Project Director) Date 6/30/15		 Contract No. 1		Title	ABBREVIATIONS, SYMBOLS, NOTES AND DETAILS	
Scale AS SHOWN		This Drawing shall not be used for Construction unless Signed and Sealed For Construction		Original Size Arch D	Drawing No: 86-16786-E001	
				Rev:	0	





ONE LINE DIAGRAM
NOT TO SCALE


NEW PANELBOARD P-2 SCHEDULE

LOCATION: PUMP STATION BUILDING ADDITION						FED FROM: NEW AUTOMATIC TRANSFER SWITCH					
MAIN BUS RATINGS: 208/120 VOLTS, 3 PHASE, 4 WIRE, 225 A						INCOMING FEED: 3#300's, 1#300 N, 1#4 G					
MINIMUM SHORTCIRCUIT INTERRUPTION RATING: 22,000 AIC						ENCLOSURE: NEMA 1					
MAIN BREAKER TRIP: 225 A, 3P											
ESTIMATED CONNECTED LOAD:											
DESCRIPTION	LOAD	CB TRIP/POLE	CIR.	A B C	CIR.	CB TRIP/POLE	LOAD	DESCRIPTION			
MOTOR ACTUATED VALVE MCV-1	.58 HP	10A/1P	1	—	2	30A	6	UV REACTOR 1			
MOTOR ACTUATED VALVE MCV-2	.58 HP	10A/1P	3	—	4						
FLOWMETER FE-1 / FIT-1		10A/1P	5	—	6	3P	KW				
FLOWMETER FE-2 / FIT-2		10A/1P	7	—	8	30A	6	UV REACTOR UV-2			
UV TRANSMITTANCE ANALYZER UVT-1		10A/1P	9	—	10						
CHLORINE RESIDUAL ANALYZER ALT-1		20A/1P	11	—	12	3P	KW				
RECEPTACLE FOR CL2 FEED PUMP 1 CFP-1		20A/1P	13	—	14	10A/1P		GAS FIRED UNIT HEATER			
RECEPTACLE FOR CL2 FEED PUMP 2 CFP-2		20A/1P	15	—	16						
LIGHTS		20A/1P	17	—	18	30A	5	GENERATOR HEATER ENGINE BLOCK			
GENERATOR BATTERY CHARGER		20A/1P	19	—	20						
GENERATOR RECEPTACLE		20A/1P	21	—	22	3P	KW				
GENERATOR CONTROL PANEL		20A/1P	23	—	24						
RECEPTACLES		20A/1P	25	—	26						
			27	—	28						
			29	—	30						

NOTES:

- EXISTING EMERGENCY GENERATOR, AUTOMATIC TRANSFER SWITCH AND MAIN DISCONNECT SWITCH TO BE DISCONNECTED, REMOVED, AND GIVEN TO THE OWNER FOR RE-USE IN ANOTHER APPLICATION.
- PROVIDE NEW MAIN SERVICE RATED DISCONNECT SWITCH, AUTOMATIC TRANSFER SWITCH AND EMERGENCY GENERATOR AS SHOWN AND AS SPECIFIED.
- FIELD VERIFY MAIN LUG SIZES ON EXISTING PANELBOARD REPLACE AS REQUIRED TO ACCOMMODATE NEW INCOMING CONDUCTORS AS SHOWN ON ONE-LINE.


				NOTES:					 GHD Consulting Services, Inc. One Remington Park Drive Cazenovia NY 13035 USA T 1 315 679 5800 F 1 315 679 5801 E cazmail@ghd.com W www.ghd.com	Drawn IDG	Designer IDG	Client TOWN OF NORTH CASTLE, NEW YORK	
				UNDERGROUND FACILITIES, STRUCTURES, AND UTILITIES HAVE BEEN PLOTTED FROM AVAILABLE SURVEYS AND RECORDS, AND THEREFORE THEIR LOCATIONS MUST BE CONSIDERED APPROXIMATE ONLY. THERE MAY BE OTHERS, THE EXISTENCE OF WHICH IS PRESENTLY NOT KNOWN.						Drafting Check TWD	Design Check TWD		Project NORTH BROADWAY ULTRAVIOLET DISINFECTION ONE LINE DIAGRAM AND SCHEDULES
				IT IS VIOLATION OF NEW YORK STATE EDUCATION LAW FOR ANY PERSON UNLESS ACTING UNDER THE DIRECTION OF A LICENSED PROFESSIONAL ENGINEER, TO ALTER AN ITEM ON THIS DRAWING IN ANYWAY. IF AN ITEM IS ALTERED, THE ALTERING ENGINEER SHALL AFFIX TO THE ITEM HIS/HER SEAL AND THE NOTATION "ALTERED BY" FOLLOWED BY HIS/HER SIGNATURE AND DATE OF SUCH ALTERATION AND A SPECIFIC DESCRIPTION OF THE ALTERATION.						Approved (Project Director) Date 10/30/15	Contract No. 1		
0	FOR CONSTRUCTION			IDG	NJH	KC	10/15	Scale AS SHOWN			Original Size Arch D Drawing No: 86-16786-E002	Rev: 0	
No	Revision	Note: * indicates signatures on original issue of drawing or last revision of drawing		Drawn	Job Manager	Project Director	Date	This Drawing shall not be used for Construction unless Signed and Sealed For Construction					
Plot Date: 28 October 2015 - 3:46 PM				Plotted by: Jay DeLapp				Cad File No: G:\86\16786\CADD\Drawings\Elec\86-16786-E002.dwg					

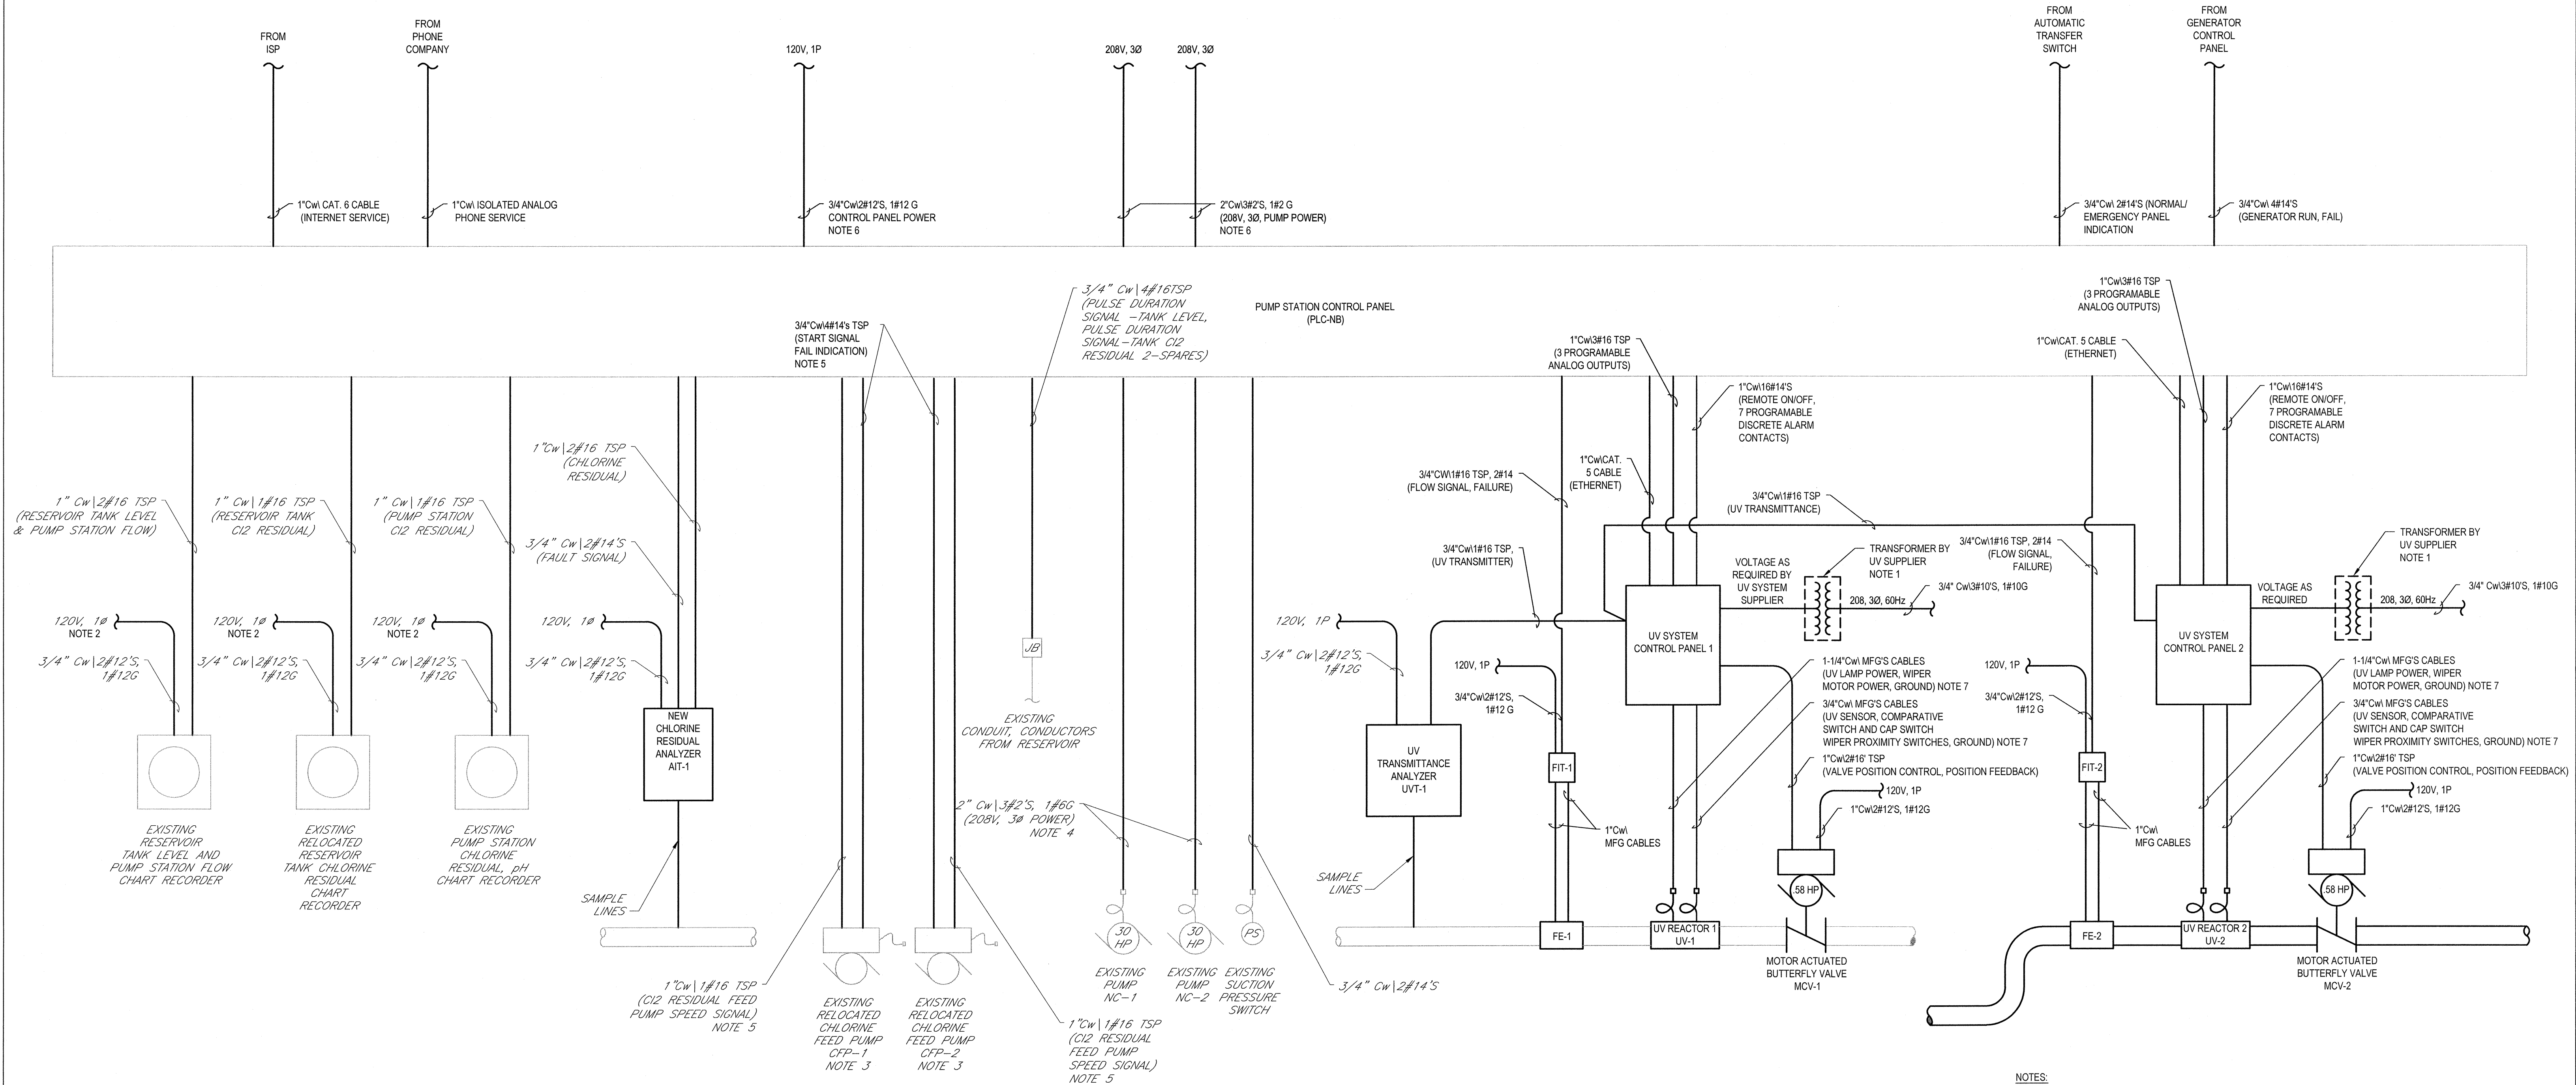

SCHEMATIC DIAGRAM
NOT TO SCALE

- NOTES:
- TRANSFORMER PROVIDED BY UV SYSTEM SUPPLIER IF REQUIRED. IF TRANSFORMER IS REQUIRED, UV SUPPLIER TO PROVIDE CONDUIT AND WIRE BETWEEN TRANSFORMER AND UV SYSTEM CONTROL PANEL. IF NO TRANSFORMER IS REQUIRED, BRING POWER FEED CONDUIT AND CONDUCTORS DIRECTLY TO UV SYSTEM CONTROL PANEL. TRANSFORMERS TO BE INSTALLED ABOVE UV SYSTEM CONTROL PANELS. (TRANSFORMER NOT SHOWN ON PLANS).
 - DISCONNECT AND REMOVE EXISTING POWER CONDUCTORS FOR EXISTING CHART RECORDERS.
 - PROVIDE DEDICATED RECEPTACLES FOR CHLORINE FEED PUMPS. SEE PLAN ON SHEET E-004.
 - RE-FEED POWER TO EXISTING PUMPS FROM NEW PUMP STATION CONTROL PANEL.
 - REMOVE EXISTING CONDUIT AND CONDUCTORS BETWEEN EXISTING CONTROL PANEL AND CHLORINE FEED PUMPS. PROVIDE NEW CONDUIT AND CONDUCTORS AS SHOWN.
 - REMOVE EXISTING CONDUIT AND CONDUCTORS BETWEEN EXISTING PANELBOARD AND EXISTING CONTROL PANEL. PROVIDE NEW CONDUIT AND CONDUCTORS BETWEEN EXISTING PANELBOARD AND NEW CONTROL PANEL AS SHOWN.
 - CONTRACTOR IS RESPONSIBLE FOR VERIFYING THE REQUIRED QUANTITY AND SIZE OF CONDUITS AND CONDUCTORS FROM THE UV CONTROL PANELS TO THE REACTORS WITH THE UV EQUIPMENT MANUFACTURER.
 - SCHEMATIC REFLECTS MINIMUM REQUIREMENT FOR LAYOUT 1 AND LAYOUT 2UV MANUFACTURERS. ANY ADDITIONAL CONDUIT AND CONDUCTORS REQUIRED BY THE SELECTED MANUFACTURER SHALL BE THE RESPONSIBILITY OF THE CONTRACTOR.

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NOTES:

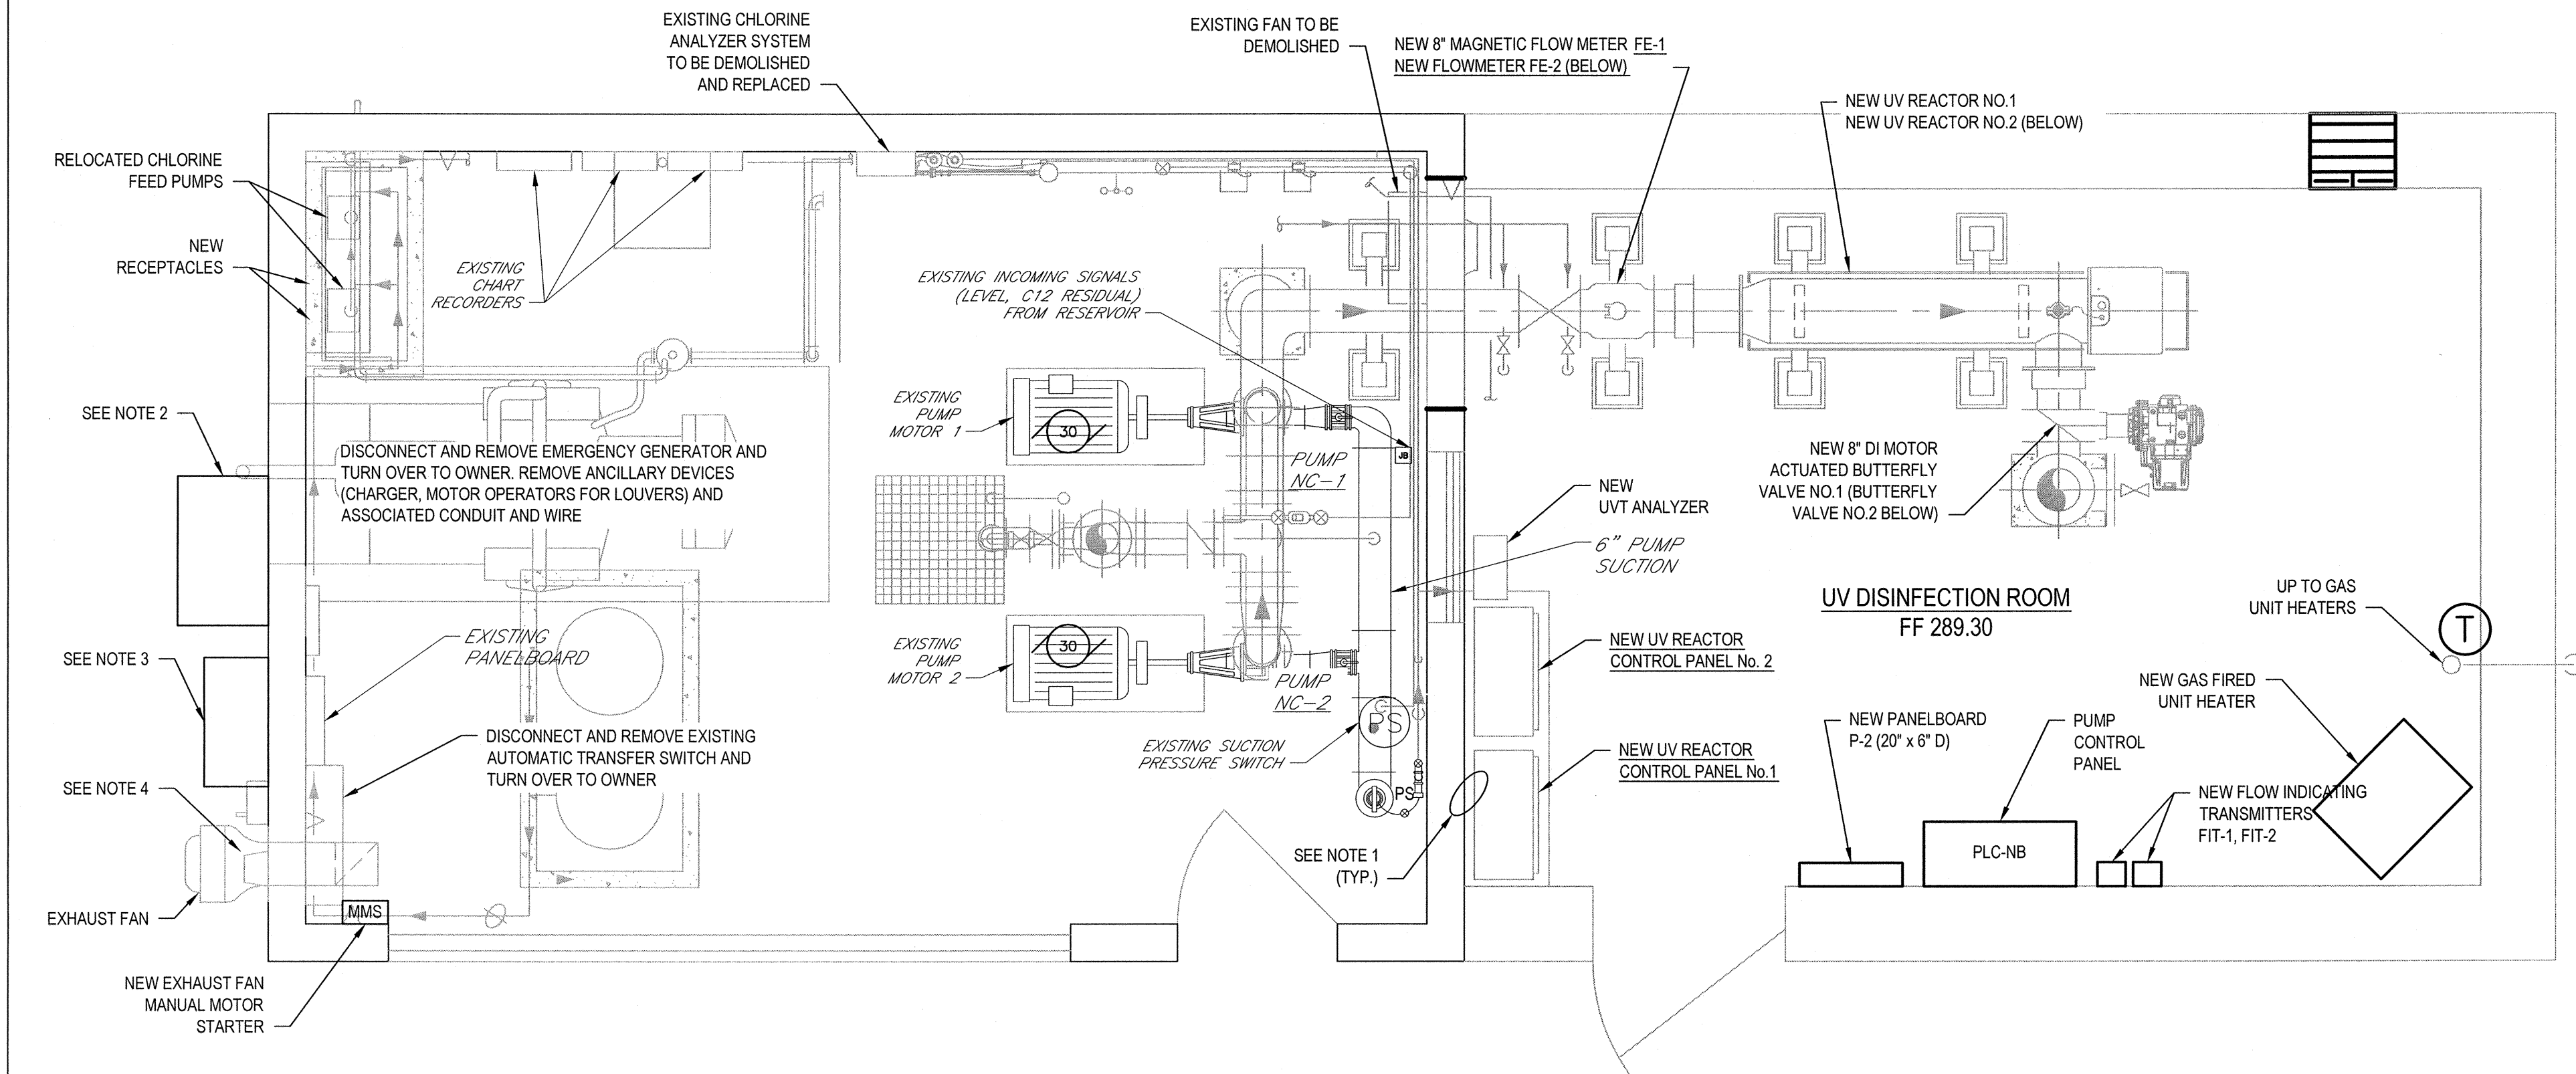
1. PROVIDE EXPANSION FITTINGS WHERE ALL CONDUIT CROSS FROM EXISTING PUMP STATION TO BUILDING ADDITION.
2. NEW AUTOMATIC TRANSFER SWITCH. SEE SITE PLAN FOR GENERATOR LOCATIONS.
3. DISCONNECT AND REMOVE EXISTING MAIN DISCONNECT SWITCH AND TURN OVER TO OWNER. PROVIDE NEW MAIN DISCONNECT SWITCH. SEE ONE LINE DIAGRAM AND SPECIFICATIONS.
4. EXISTING UTILITY SERVICE METER. COORDINATE WITH UTILITY RE: METERING REQUIREMENTS FOR UPGRADED SERVICE. SEE SPECIFICATION SECTION 16421.

ELECTRICAL PLAN

SCALE: 1/2" = 1'-0"

NOTE:

PLAN IS BASED ON UV REACTOR ALTERNATE LAYOUT 1. CONTRACTOR IS RESPONSIBLE FOR CHANGES TO EQUIPMENT LAYOUT LOCATIONS AS REQUIRED BY THE APPROVAL UV EQUIPMENT MANUFACTURER.

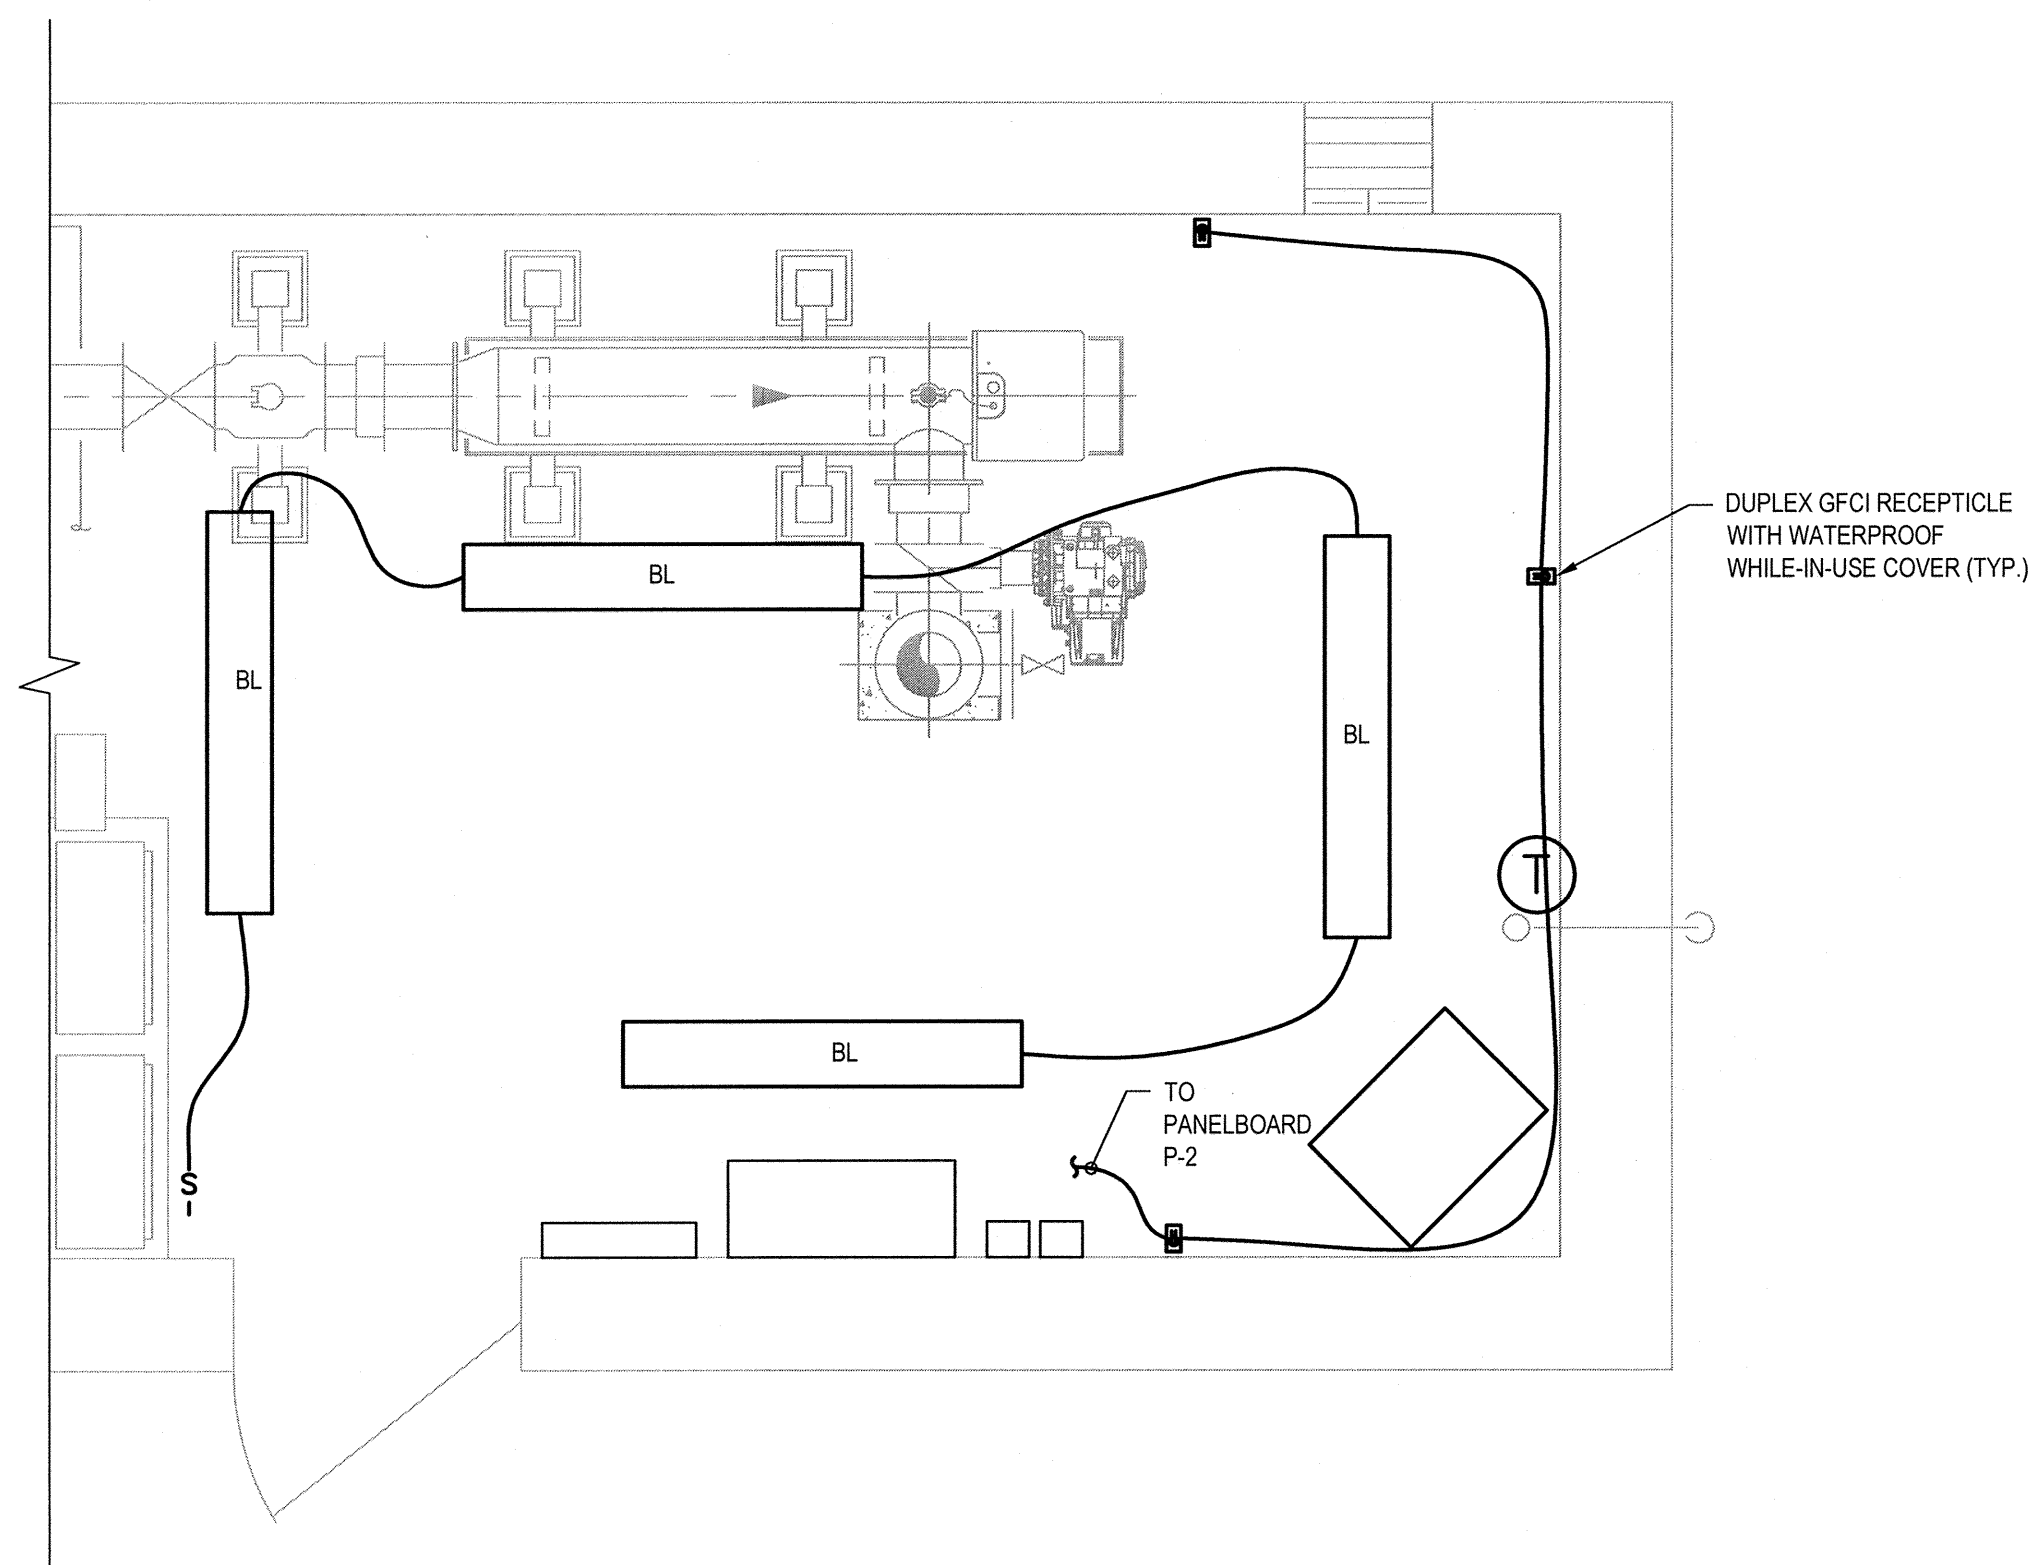



BUILDING ADDITION LIGHTING PLAN

1. NONMETALLIC LED LUMINAIRE, NOMINALLY 4-FEET LONG.
2. CEILING MOUNTED.
3. FIBERGLASS HOUSING WITH NEOPRENE GASKET.
4. ACRYLIC PRISMATIC LENS WITH SIX STAINLESS STEEL LATCHES.
5. SUITABLE FOR WET OR CORROSIVE LOCATIONS.
6. LED MINIMUM 4,1000 LUMEN OUTPUT MINIMUM 65CRI
7. RATED FOR 60,000 HOURS OF LIFE.
8. 120 VOLT OPERATION.

MANUFACTURERS:
LITHONIA: VAP LED SERIES
DAY-BRIGHT: V2 SERIES
OR APPROVED EQUAL


LUMINAIRE 'BL' SPECIFICATION

NOT TO SCALE

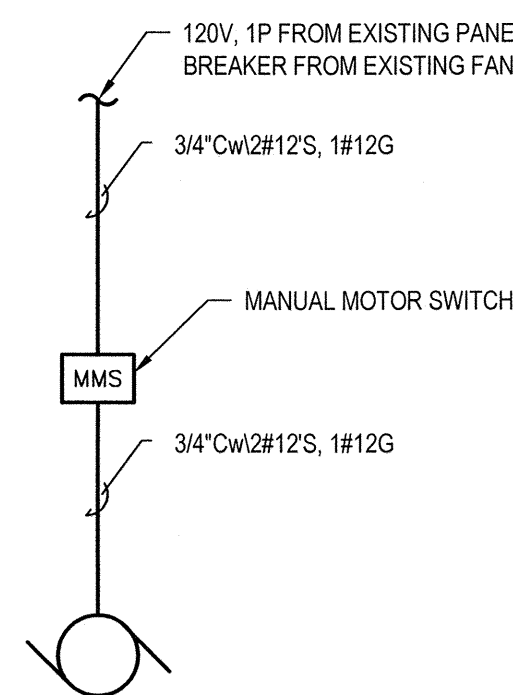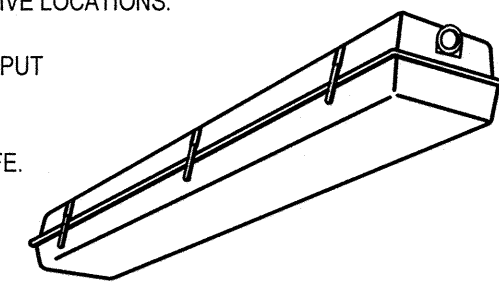


FAN SCHEMATIC DIAGRAM


NOT TO SCALE

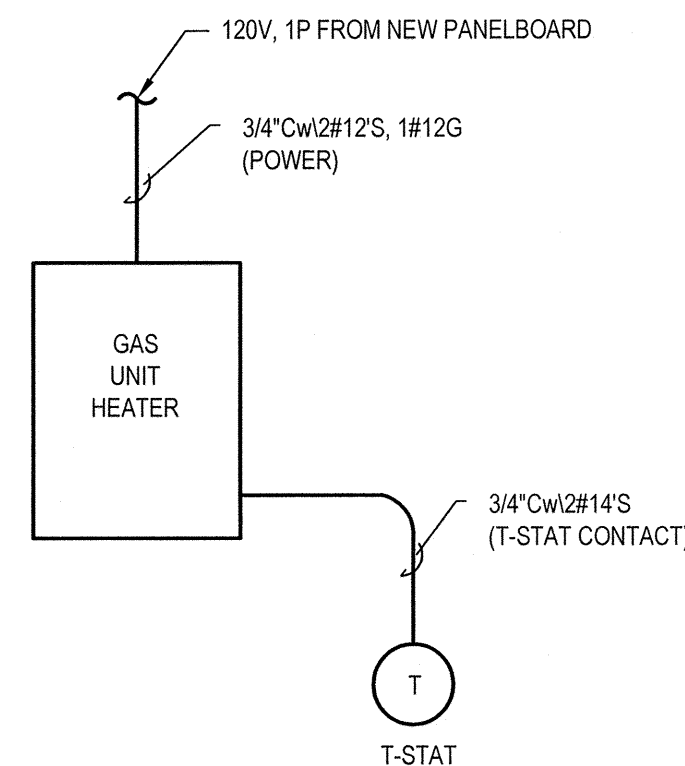

GAS FIRED UNIT HEATER SCHEMATIC DIAGRAM

NOT TO SCALE

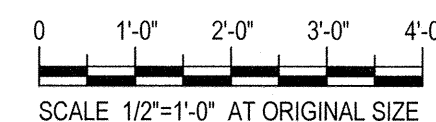


					NOTES:						 GHD Consulting Services, Inc. One Remington Park Drive Cazenovia NY 13035 USA T 1 315 679 5800 F 1 315 679 5801 E cazmail@ghd.com W www.ghd.com	Drawn GJH	Designer TWD	Client TOWN OF NORTH CASTLE, NEW YORK Project NORTH BROADWAY ULTRAVIOLET DISINFECTION ELECTRICAL PLANS Title			
					UNDERGROUND FACILITIES, STRUCTURES, AND UTILITIES HAVE BEEN PLOTTED FROM AVAILABLE SURVEYS AND RECORDS, AND THEREFORE THEIR LOCATIONS MUST BE CONSIDERED APPROXIMATE ONLY. THERE MAY BE OTHERS, THE EXISTENCE OF WHICH IS PRESENTLY NOT KNOWN.							Drafting Check TWD	Design Check TWD				
0 FOR CONSTRUCTION					MRY	NJH	KC	10/15	IT IS VIOLATION OF NEW YORK STATE EDUCATION LAW FOR ANY PERSON UNLESS ACTING UNDER THE DIRECTION OF A LICENSED PROFESSIONAL ENGINEER, TO ALTER AN ITEM ON THIS DRAWING IN ANYWAY. IF AN ITEM IS ALTERED, THE ALTERING ENGINEER SHALL AFFIX TO THE ITEM HIS/HER SEAL AND THE NOTATION "ALTERED BY" FOLLOWED BY HIS/HER SIGNATURE AND DATE OF SUCH ALTERATION AND A SPECIFIC DESCRIPTION OF THE ALTERATION.					Approved (Project Director) 	Date 10/30/15	Contract No. 1	Original Size Arch D Drawing No: 86-16786-E004
No	Revision	Note: * indicates signatures on original issue of drawing or last revision of drawing			Drawn	Job Manager	Project Director	Date						Scale AS SHOWN	This Drawing shall not be used for Construction unless Signed and Sealed For Construction		

Plot Date: 28 October 2015 - 4:16 PM

Plotted by: Jay DeLapp


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- NOTES:
1. PROVIDE FLEXIBLE CONDUIT/CONDUCTORS WITH SUFFICIENT SLACK TO ALLOW UP TO 2-INCHES OF SLAB HEAVING/SETTLEMENT DURING FREEZE/THAW PERIODS.
 2. WIRING IS DIAGRAMMATIC AND FOR PRICING PURPOSES. CONFIRM ALL WIRING WITH GENERATOR MANUFACTURER PRIOR TO INSTALL.

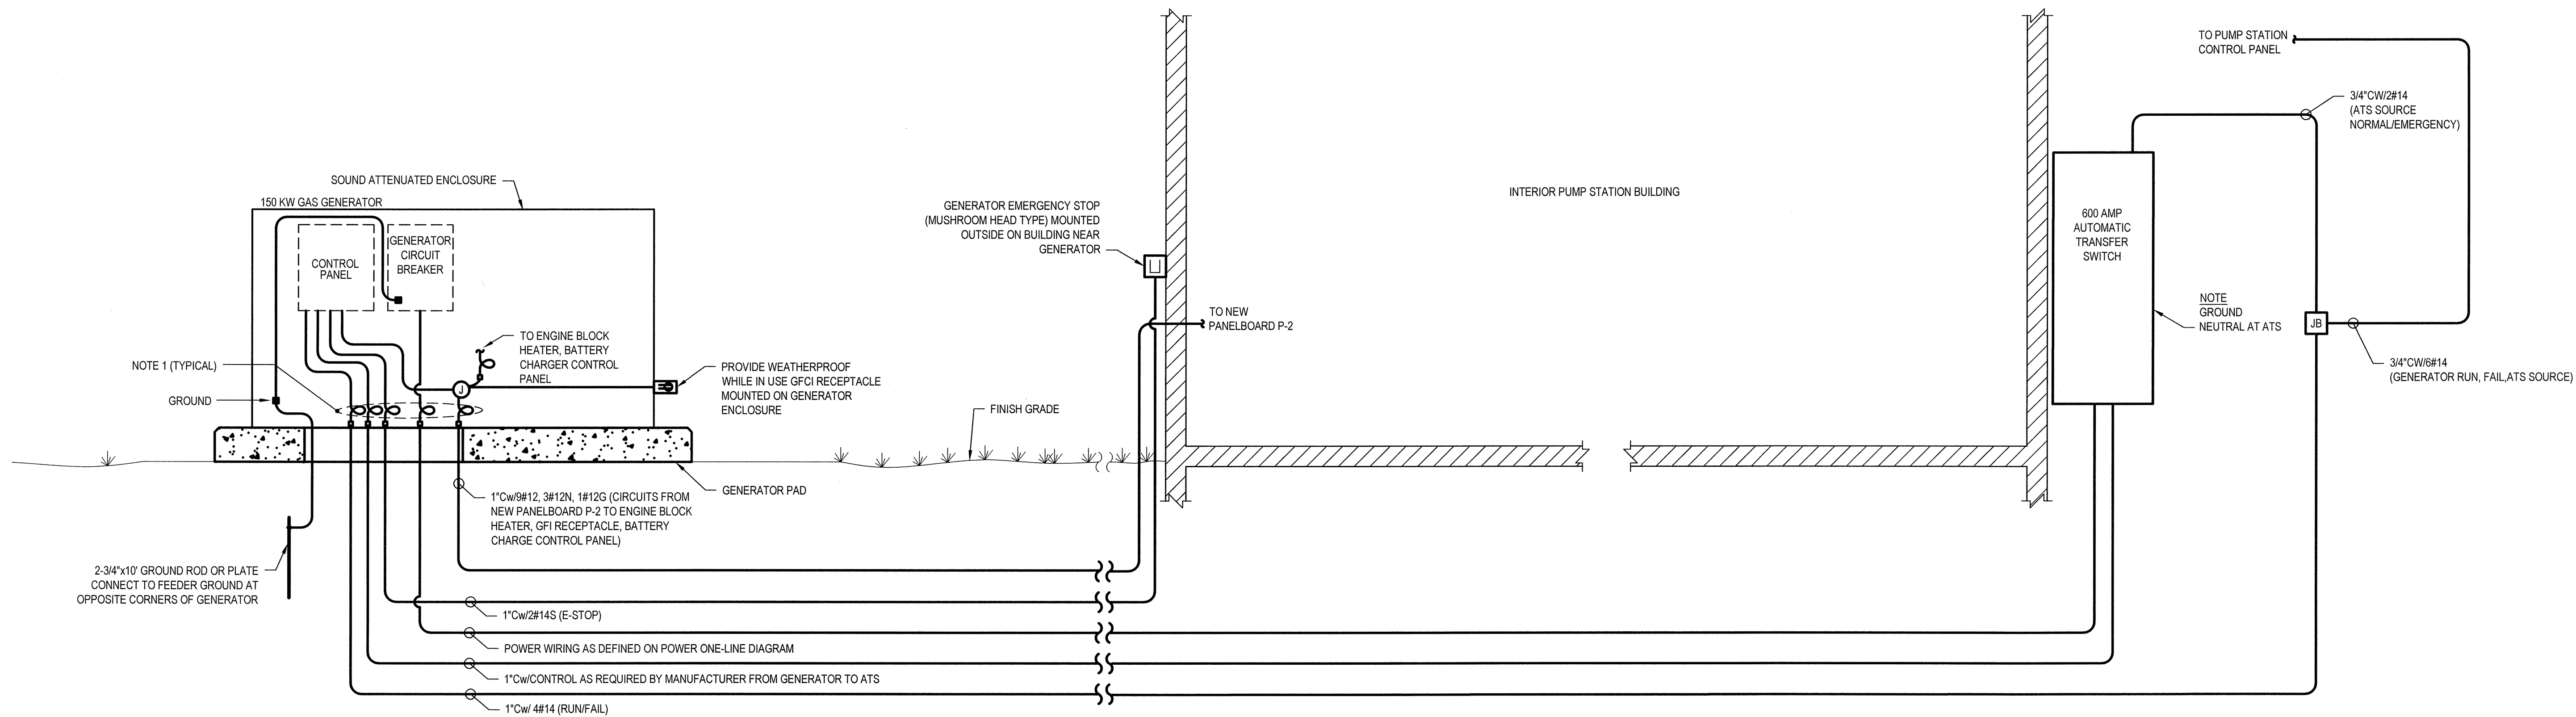GENERATOR SCHEMATIC

NOT TO SCALE



CONCRETE ENCASED UNDER PAVED AREAS

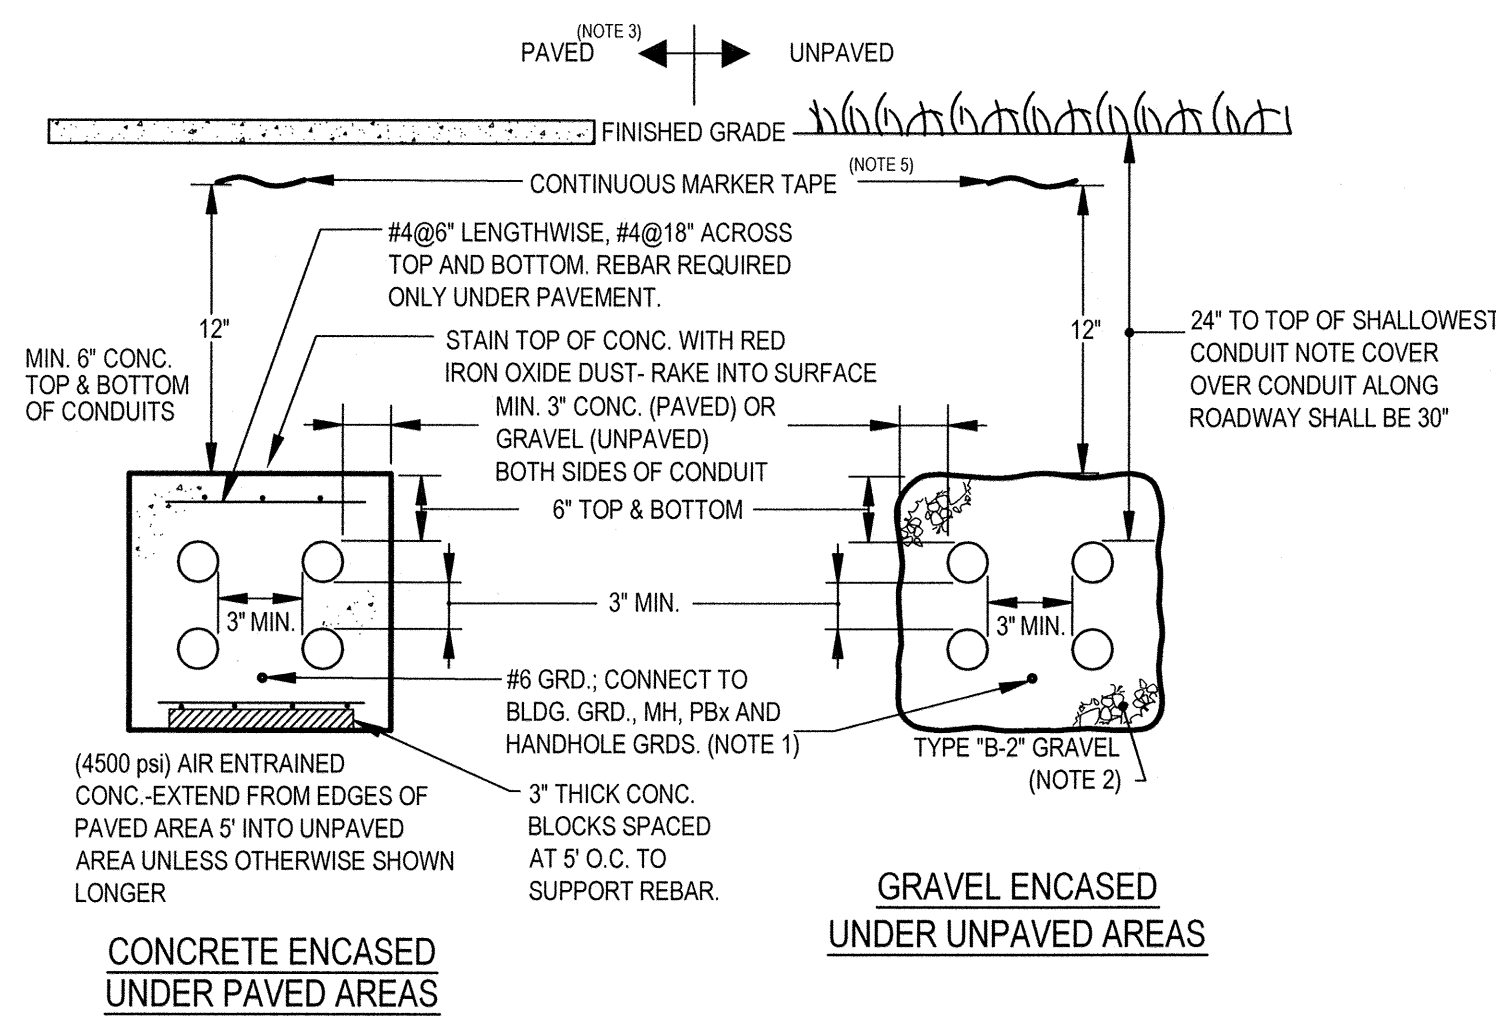
(NOTE 3)

DUCTBANK DETAIL

SCALE: NTS


DUCTBANK NOTES:

1. IF EXISTING OR NEW GROUNDS ARE NOT AVAILABLE AT DUCTBANK ENDS, PROVIDE ONE 3/4"x10" GROUND ROD, OFFSET TO SIDE OF DUCTBANK, FOR TERMINATION OF DUCTBANK GROUNDING CONDUCTORS.
2. CONTRACTOR SHALL BE PERMITTED TO USE OTHER SUITABLE GRAVEL WITH 2" MAXIMUM SIZE EXCEPT CRUSHED AGGREGATE SHALL NOT BE PERMITTED.
3. INCLUDES ALL AREAS NORMALLY SUBJECT TO VEHICULAR TRAFFIC, AND OTHER AREAS AS SHOWN ON THE PLANS.
4. DUCTBANKS SHALL BE CONCRETE ENCASED OVER ALL PIPE CROSSINGS TO 5' FROM CENTERLINE IN BOTH DIRECTIONS, AND EXTENDING 5' BEYOND PAVED AREAS.
5. ON DUCTBANKS WIDER THAN 30-INCHES, PROVIDE TWO ROWS OF WARNING TAPE, PLACED NEAR THE OUTER EDGES OF THE DUCTBANK.

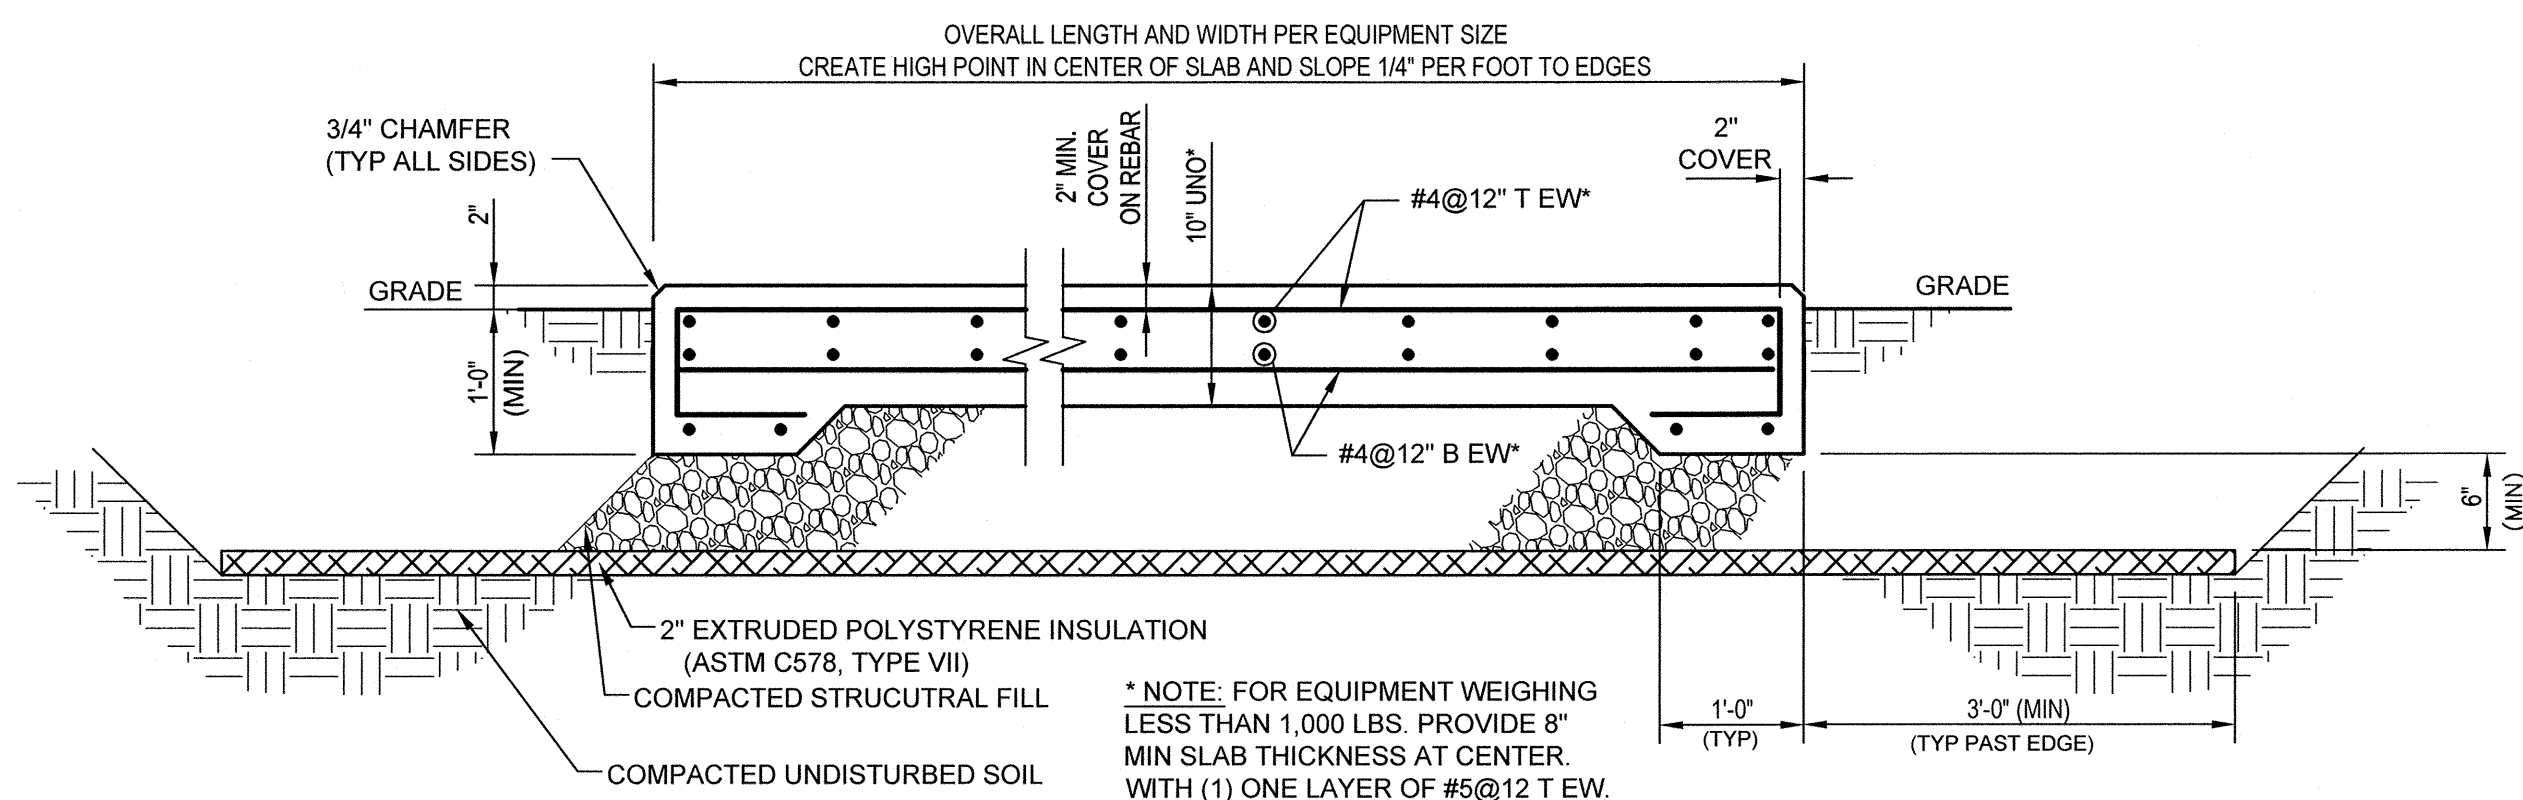

TYPICAL FROST-PROTECTED EQUIPMENT PAD DETAIL

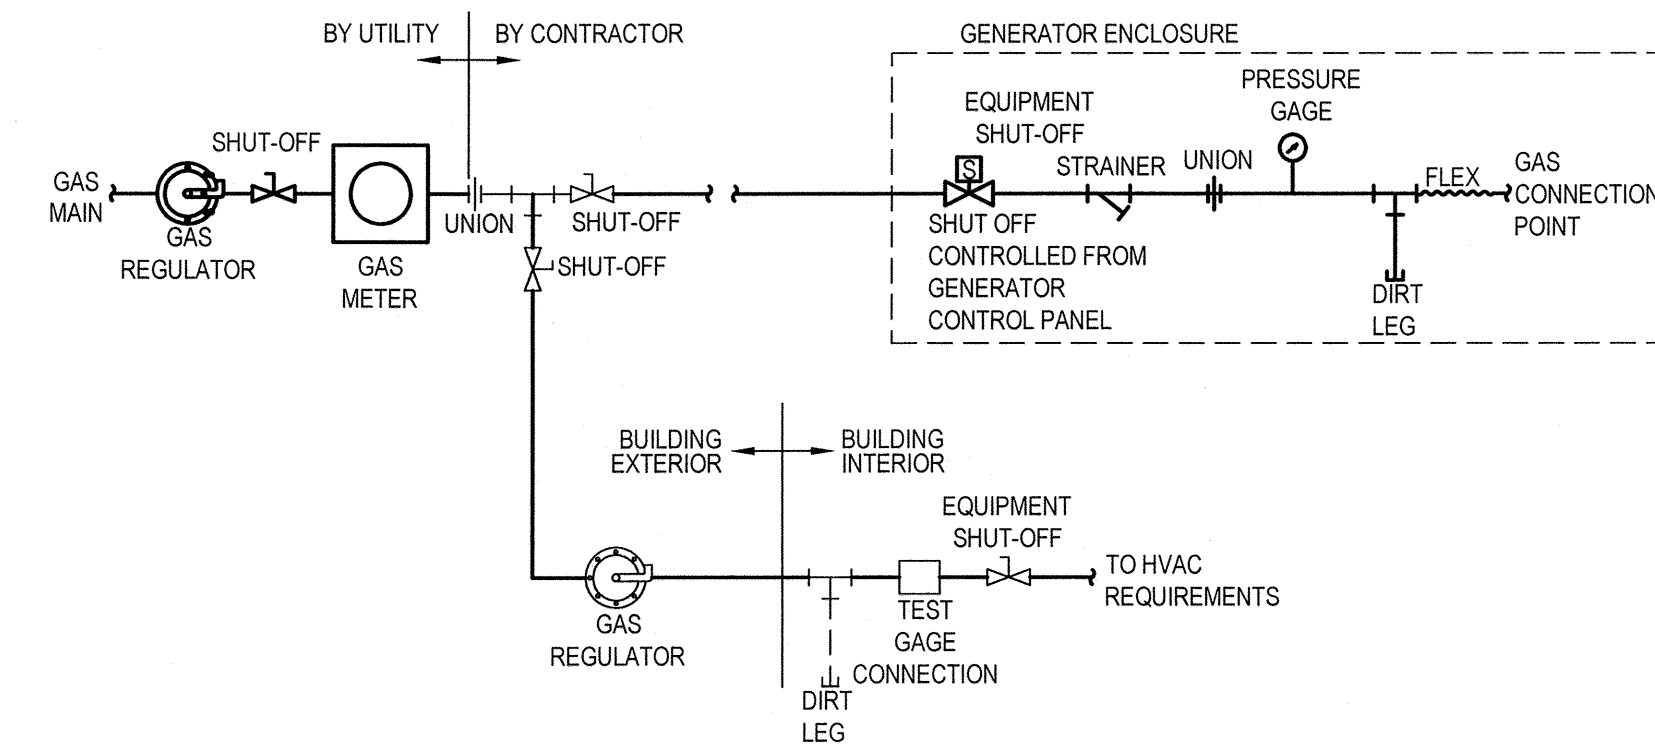

NOT TO SCALE






TYPICAL GAS PIPING SERVICE ENTRANCE

NOT TO SCALE

- ALL GAS PIPING SHALL BE MINIMUM 1 1/2" DIAMETER, UNLESS OTHERWISE NOTED, UNTIL FINAL CONNECTION TO LOADS. PROVIDE REDUCERS AS REQUIRED. SELECT PIPE ROUTING TO MINIMIZE BENDS AND ELBOWS.
- INSTALL PLASTIC / METAL ADAPTER AT METER. ALL ABOVE GRADE PIPING SHALL BE WROUGHT STEEL. PIPING INSTALLATION AND TESTING SHALL BE IN ACCORDANCE WITH LOCAL GAS UTILITY AND NFPA 54.
- NOTE: GAS SERVICE ENTRANCE PIPING IS NOT SHOWN ON THE PLAN DRAWINGS. CONTRACTOR SHALL COORDINATE WITH GAS UTILITY TO PROVIDE RELOCATED GAS SERVICE. FURNISH AND INSTALL GAS PIPING IN ACCORDANCE WITH UTILITY REQUIREMENTS AND ALL APPLICABLE CODES. GAS SERVICE REQUIREMENT IS APPROXIMATELY 2,050 CFH AT 7 TO 11 INCHES OF WATER COLUMN FOR THE GENERATOR AND 100 CFH AT 5 TO 14 INCHES OF WATER COLUMN FOR HVAC. PROVIDE ADDITIONAL REGULATORS, VALVES AND GAUGES AS REQUIRED BY GENERATOR MANUFACTURER AND HVAC REQUIREMENTS.

				NOTES:				<div><div><div></div><div>GHD Consulting Services, Inc.</div><div>One Remington Park Drive Cazenovia NY 13035 USA T 1 315 679 5800 F 1 315 679 5801 E cazmail@ghd.com W www.ghd.com</div></div></div>				Drawn IWS		Designer TWD		Client		TOWN OF NORTH CASTLE, NEW YORK	
				UNDERGROUND FACILITIES, STRUCTURES, AND UTILITIES HAVE BEEN PLOTTED FROM AVAILABLE SURVEYS AND RECORDS, AND THEREFORE THEIR LOCATIONS MUST BE CONSIDERED APPROXIMATE ONLY. THERE MAY BE OTHERS, THE EXISTENCE OF WHICH IS PRESENTLY NOT KNOWN.								Drafting Check TWD		Design Check TWD		Project		NORTH BROADWAY ULTRAVIOLET DISINFECTION ELECTRICAL PLANS	
				IT IS VIOLATION OF NEW YORK STATE EDUCATION LAW FOR ANY PERSON UNLESS ACTING UNDER THE DIRECTION OF A LICENSED PROFESSIONAL ENGINEER, TO ALTER AN ITEM ON THIS DRAWING IN ANYWAY. IF AN ITEM IS ALTERED, THE ALTERING ENGINEER SHALL AFFIX TO THE ITEM HIS/HER SEAL AND THE NOTATION "ALTERED BY" FOLLOWED BY HIS/HER SIGNATURE AND DATE OF SUCH ALTERATION AND A SPECIFIC DESCRIPTION OF THE ALTERATION.				Approved (Project Director)		Contract No. 1		Title							
0 FOR CONSTRUCTION				IWS NJH KC 10/15				Date 10/30/15		Scale AS SHOWN		This Drawing shall not be used for Construction unless Signed and Sealed For Construction		Original Size		Arch D Drawing No: 86-16786-E005		Rev: 0	
No	Revision	Note: * Indicates signatures on original issue of drawing or last revision of drawing		Drawn	Job Manager	Project Director	Date												
Plot Date: 28 October 2015 - 3:43 PM				Plotted by: Jay DeLapp				Cad File No: G:\8616786\CADD\Drawings\Elec\86-16786-E005.dwg											

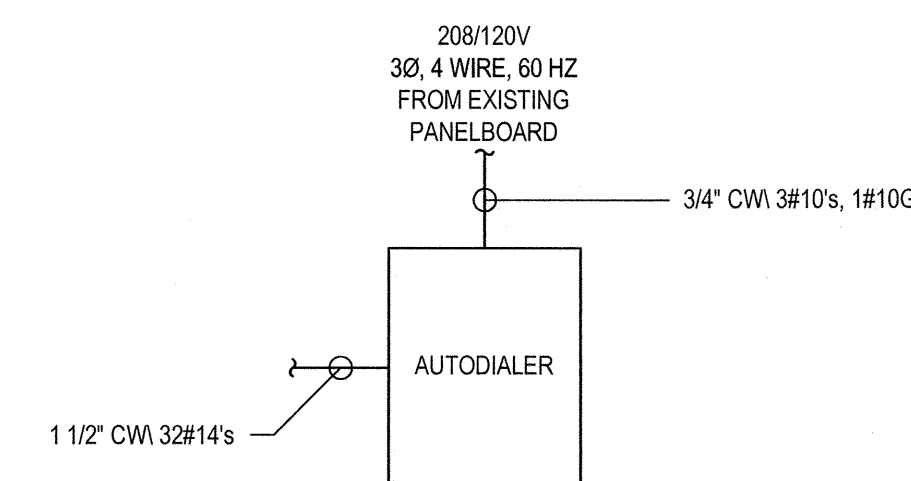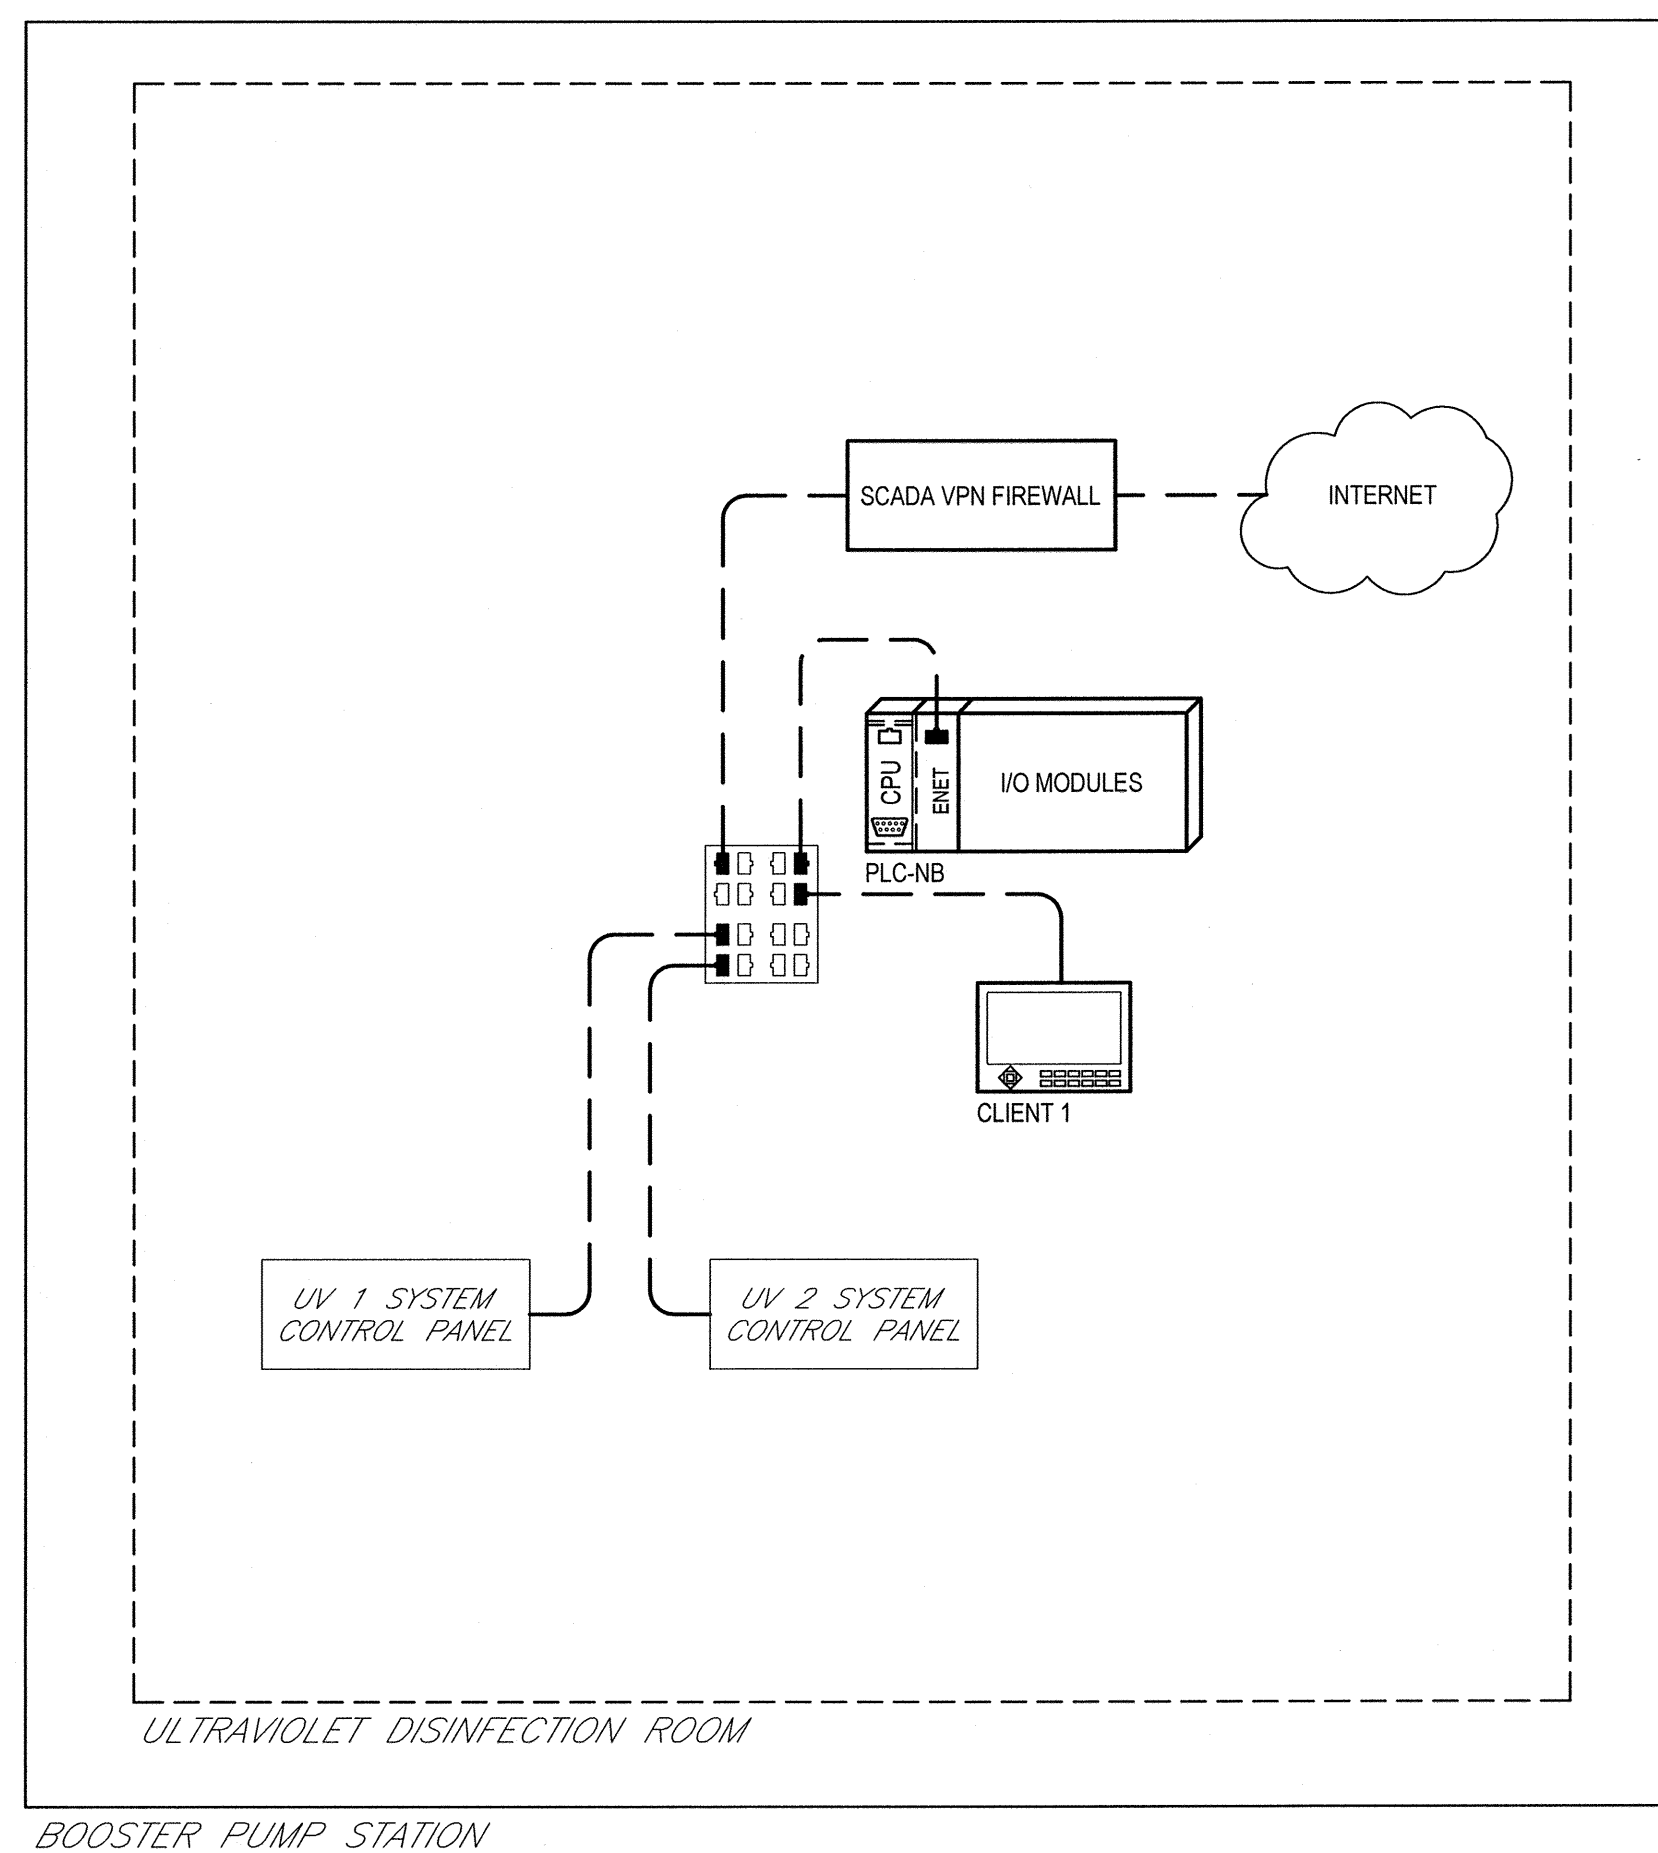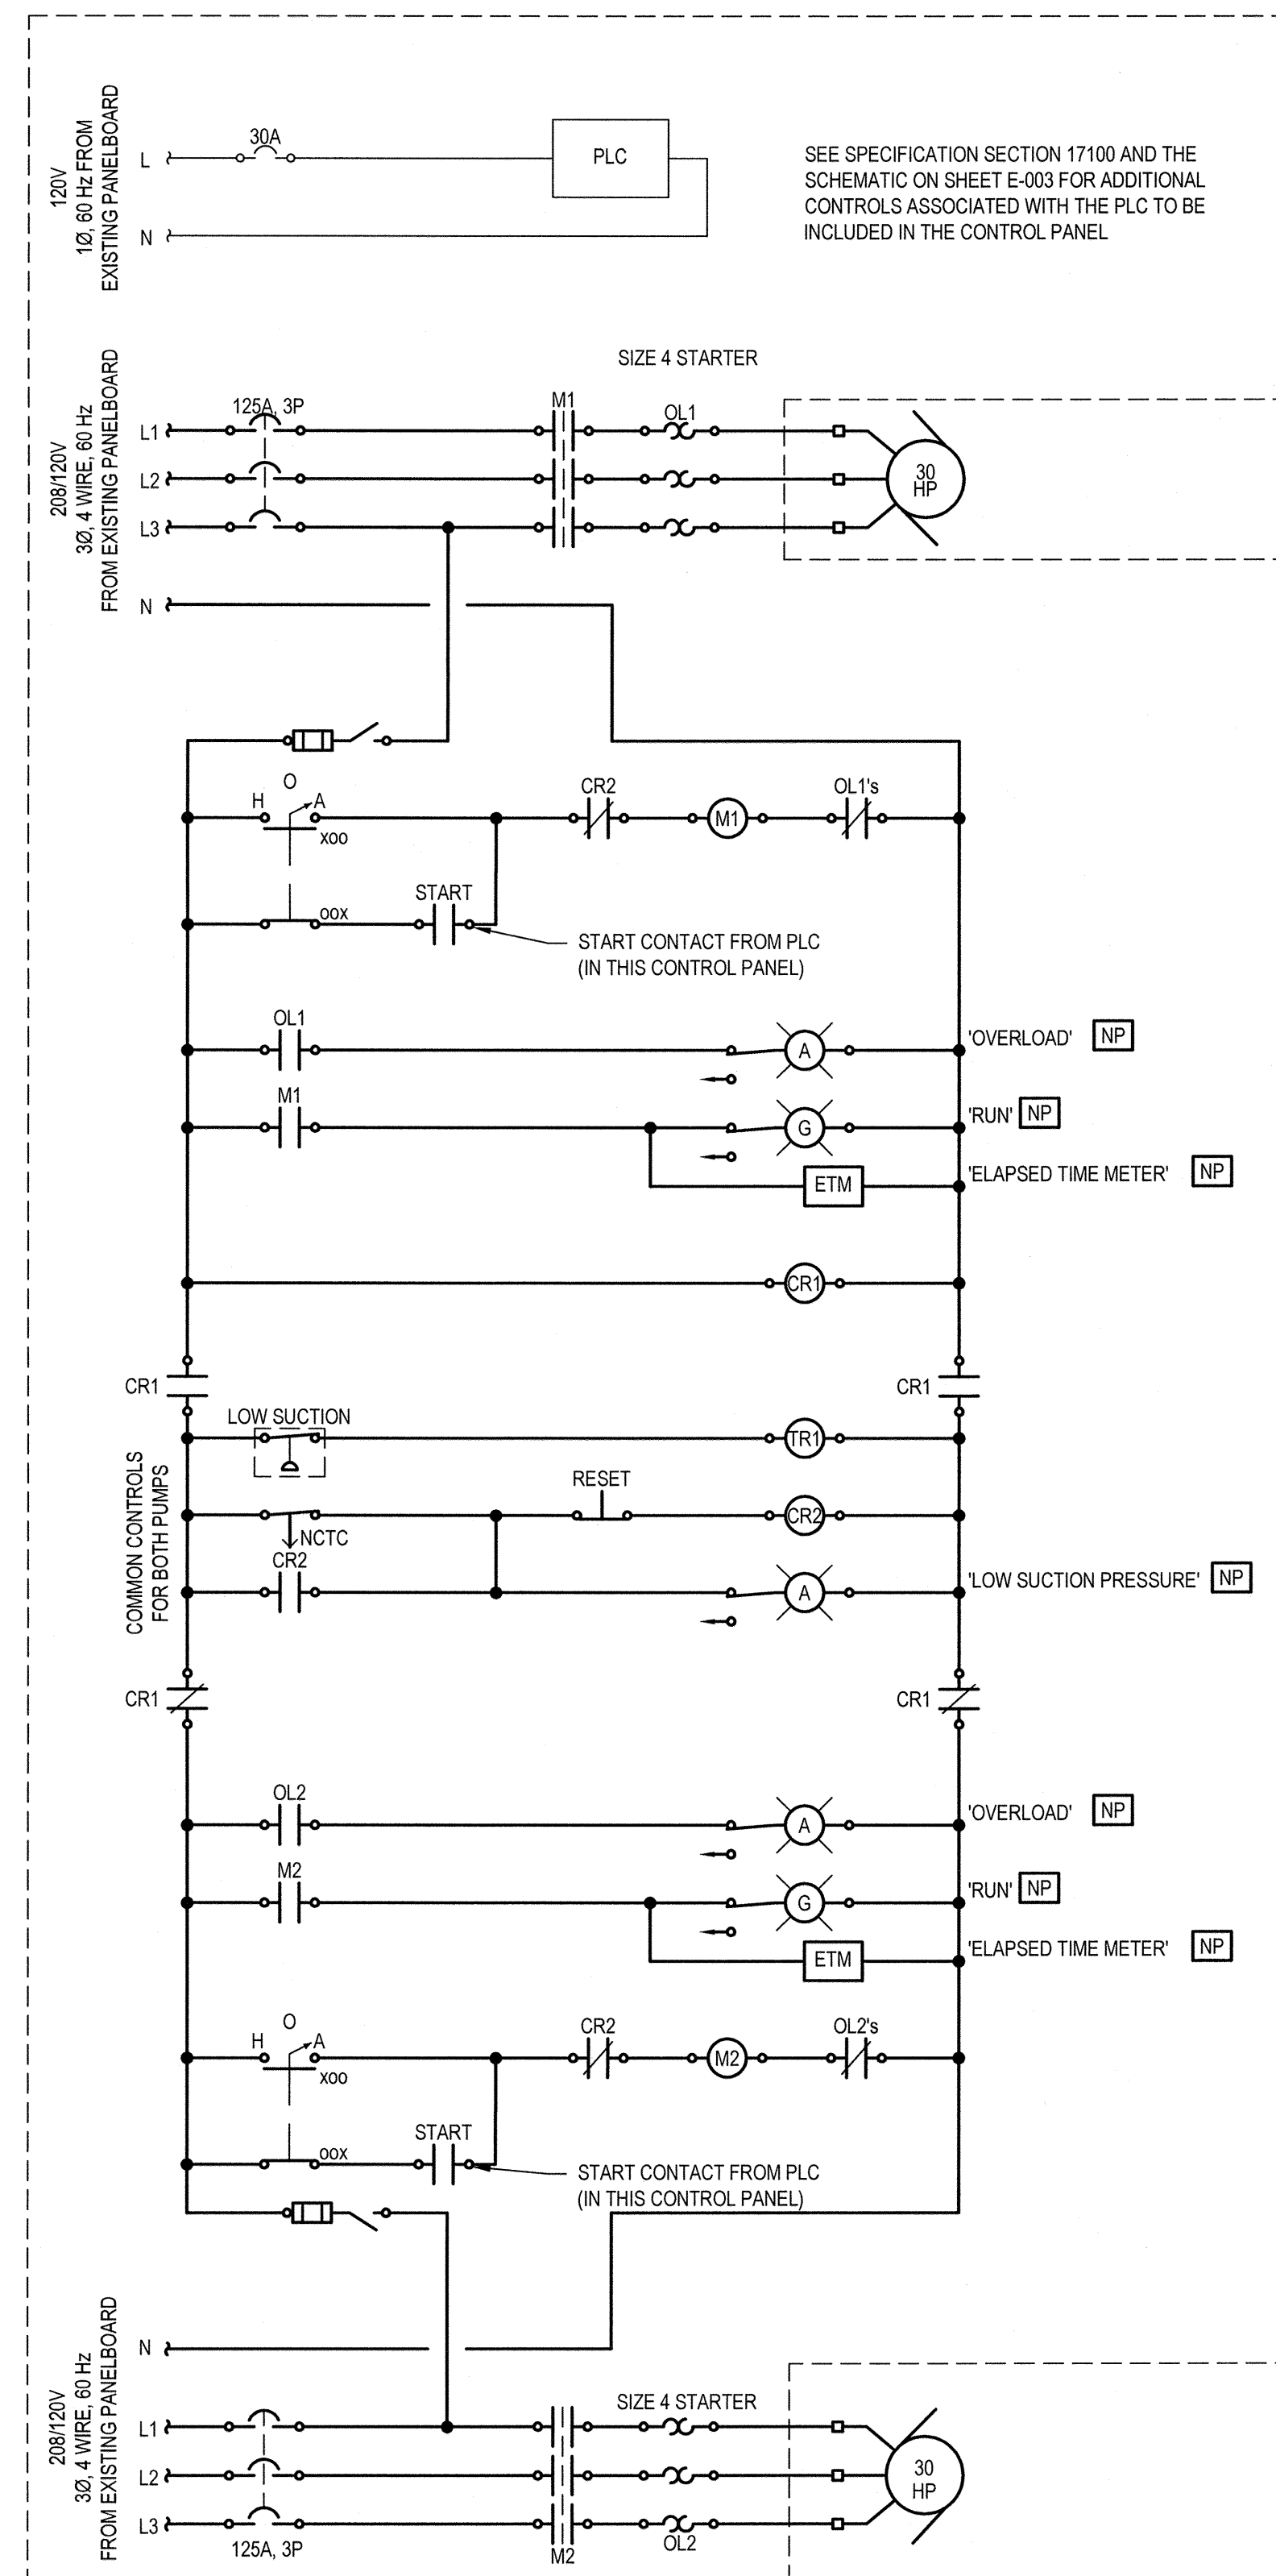

AUTODIALER WIRING		
CHANNEL	SIGNAL FROM	DESCRIPTION
1.	PLC-NB	NO CONTACT FOR ALARM FROM PLC
2	PLC-NB	NO CONTACT FOR ALARM FROM PLC
3	PLC-NB	NO CONTACT FOR ALARM FROM PLC
4	PLC-NB	NO CONTACT FOR ALARM FROM PLC
5	PLC-NB	NO CONTACT FOR ALARM FROM PLC
6	PLC-NB	NO CONTACT FOR ALARM FROM PLC
7	PLC-NB	NO CONTACT FOR ALARM FROM PLC
8	PLC-NB	NO CONTACT FOR ALARM FROM PLC
9	PLC-NB	NO CONTACT FOR ALARM FROM PLC
10	PLC-NB	NO CONTACT FOR ALARM FROM PLC
11	PLC-NB	NO CONTACT FOR ALARM FROM PLC
12	UV SYSTEM	UV ALARMS
13	UV SYSTEM	UV ALARMS
14	UV SYSTEM	UV ALARMS
15	UV SYSTEM	UV ALARMS
16	PLC-NB	NO CONTACT FOR PLC FAILURE

